ATTACHMENTS DISTRIBUTED UNDER SEPARATE COVER

PV 15/02/22 – 335 Lambton Road New Lambton – DA2021/00959 Multi dwelling housing - includes one into four lot subdivision and demolition of existing structures

PAGE 3 ITEM-1 Attachment A: Submitted Plans

ATTACHMENTS DISTRIBUTED UNDER SEPARATE COVER

PV 15/02/22 – 335 Lambton Road New Lambton – DA2021/00959 Multi dwelling housing - includes one into four lot subdivision and demolition of existing structures

ITEM - 1 Attachment A: Submitted Plans

DEVELOPMENT APPLICATION 20151

Multi Dwelling - 335 Lambton Road, New Lambton Lambton Road Developments PTY LTD

SCHEDUI	LE OF DRAWINGS
DA000	COVER PAGE
DA010	SITE ANALYSIS PLAN
DA020	DEMOLITION PLAN
DA030	SITE PLAN
DA035	SITE COVERAGE PLAN
DA040	PERSPECTIVES
DA100	GROUND FLOOR
DA110	FIRST FLOOR
DA150	ROOF PLAN
DA300	ELEVATIONS
DA301	ELEVATIONS
DA350	EXTERNAL FINISHES
DA400	SECTIONS
DA900	EXTERNAL SHADOW DIAGRAMS
DA901	EXTERNAL SHADOW DIAGRAMS
DA902	NEIGHBOURING DWELLING SHADOW DIAGRAMS
DA960	SEDIMENT CONTROL



SUBJECT SITE



SITE LOCATION

Survey By: Positive Survey Solutions Ref: 21143 Date: 17.12.2020

NSW 2289 Ph 49524425 Nominated Architect: Daniel Hadley 8209

ntained in the document is copyright and may not be used or

PO Box 601 Kotara

other project or purpose.
ns and levels on site and report any discrepancies prior to the
work and any ordering of materials.
e read in conjunction with all contract documents.

For Information Consultant Issue For Review Development Applicatio 19/05/2021 16/06/2021 28/06/2021 30/06/2021

16/07/2021

Lighting

Multi Dwelling 335 Lambton Road

Laundry

Outdoor clothes line Yes stove/Oven Gas cooktop, electric oven

DMN Assessor #16/1742

eferenced documentation

External Wall Construction

Cavity wall, direct fix plasterboard, single gap Cavity wall, direct fix

Ceiling Construction

Roof Constructio

Floor Construction 175mm Waffle Pod Slab

Al M-001-03 A Aluminium framed

Fixed shading - Eaves

ENERGY COMMITMENTS

Living

Plasterhoard with Timbe

contact Evergreen Energy Consultants.

16th July 2021

Important Note for Development Applicants:

The following specification was used to achieve the thermal performance values indicated on the Assessor Certificate. If they vary from drawings or other specifications this Specification shall take precedence. If only one specification option is detailed for a building element, that specification must

apply to all instances of that element for the whole project. If alternate specifications are detailed, the location and extent of the alternate specification must be detailed below and / or clearly indicated on

Once the development is approved by the consent authority, these specifications will become a condition of consent and must be included in the built works. If you do not want to include these

requirements, the proposed construction varies to those detailed or need further information, please

This assessment has assumed that the BCA provisions for building sealing will be complied with a

Thermal Performance Specifications

Anti-glare foil with bulk R2.5

Bulk insulation R4 0

Bulk, reflective side dov no air gap above R1.3

Group A Windows Single Glazed High Solar Gain Low-E Group B Windows Single Glazed High Solar Gain Low-E

All Group A windows are Awning, Bifold, Casement, Tilt 'n' Turn, Entry, French & Hinged windows and door All Group B windows are Double Hung, Louvre, Fixed, Sliding & Stacker windows and doors

U and SHGC values are according to NFRC. Alternate products may be used if the U value is lower and the

Thermal construction in accordance with Vol 1 Section J1.2 or Vol 2 Part 3.12.1.1 Thermal breaks in accordance with Section J1.3(d) & 1.5(c) or Part 3.12.1.2(c) & 3.12.1.4(b) Compensating for loss of ceiling insulation in accordance with Section J1.3(c) or Part 3.12.1.2(e) Floor insulation in accordance with Section J1.6(c) & (d) or Part 3.12.1.5(a)(iii) or (c) & (d)

335 Lambton Road, New Lambton SUMMARY OF BASIX COMMITMENTS This is a summary of the BASIX Commitments as detailed in the BASIX Certificate Refer to the CURRENT BASIX Certificate for Complete details.

Living 1-phase air conditioning EER 3.0-3.5 (zoned Bedrooms 1-phase air conditioning EER 3.0-3.5 (zoned Manual on/ 1-phase air conditioning EER 3.0-3.5 (zoned) Individual fan, not ducted Manual on/of Individual fan, not ducted Manual on/of

Individual fan, not ducted

1-phase air conditioning EER 3.0-3.5 (zoned)

1-phase air conditioning EER 3.0-3.5 (zoned)

Building sealing in accordance with Section J3 or Part 3.12.3.1 to 3.12.3.6.

Alternative Water – Rainwater Tank Size 4,000(L) Tank/Unit Connected To

Laundry W/M Cold Tap One Outdoor Tap All toilets

Window/Skylight in Kitchen

Window/Skylight in Bathrooms/Toilets

Number of bedrooms All Number of Living/Dining rooms All

Width includes guttering, offset is distance above windows Nominal only, refer to plan for detail

Evergreen Energy Consultants

Reference: 258/2021

Internal walls adjoining garage

External ceilings

Carpet, Tiles and Bare

Ph: 1300 584 010


New Lambton Lambton Road

COVER PAGE

@ A3 QA CHECKED

FOR AUTHORITY APPROVAL ONLY NOT FOR CONSTRUCTION

DA000 Project Numbe 20151

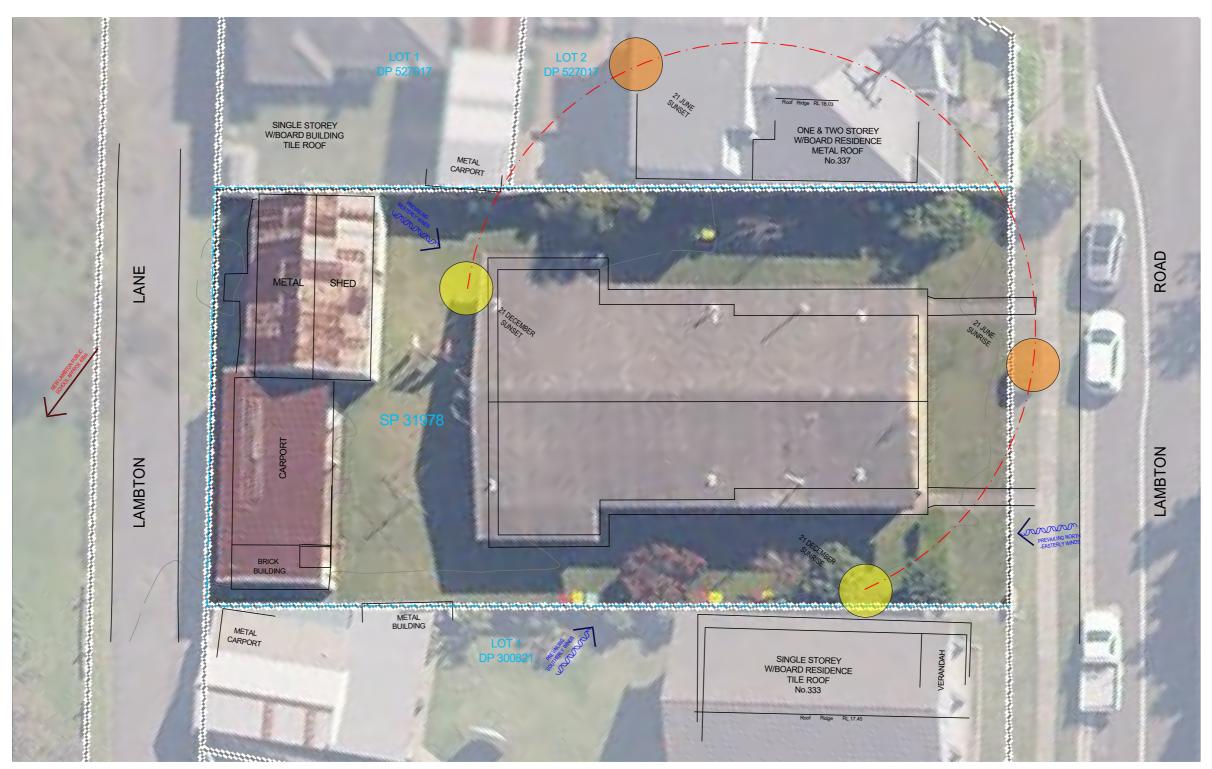

Summary of planning controls

Planning controls held within the Planning Database are summarised below. The property may be affected by additional planning controls not outlined in this report. Please contact your council for more information.

Local Environmental Plans Newcastle Local Environmental Plan 2012 (pub. 30-5-2014) R2 - Low Density Residential: (pub. 15-6-2012)

Land Zoning Height Of Building Floor Space Ratio 0.6:1 Minimum Lot Size 400 m² Heritage NA NA Land Reservation Acquisition Foreshore Building Line

Acid Sulfate Soils



FOR AUTHORITY APPROVAL ONLY NOT FOR CONSTRUCTION

PO Box 601 Kotara NSW 2289 Ph 49524425 Nominated Architect: Daniel Hadley 8209

Notes

Notes

The information contained in the document is copyright and may not be used or reproduced for any other project or purpose.

Verify all dimensions and levels on site and report any discrepancies prior to the commencement of work and any ordering of materials.

Drawings are to be read in conjunction with all contract documents.

Use figured dimensions only. Do not scale from drawings.

ELK Designs cannot guarantee the accuracy of content and format for copies of drawi issued electronically.

The completion of the issue debate contents and format for copies of drawings.



Consultants

Surveyor Positive Survey Solutions p: 02 4960 1111 e: brett@psurveys.com.au

Civil Engineer MPC Consulting Engineers p: 02 4927 5566 e: admin@mpceng.com.au

Town Planner Piper Planning Pty Ltd p: 0401660152 e: piperplanning.com.au Energy Assessor Evergreen Energy Consultants p: (02) 4975 5350 m: 0407 886 275 e: joseph@evergreenec.com.au Structural Engineer MPC Consulting Engineers p: 02 4927 5566 e: admin@mpceng.com.au

Arborist Abacus Tree Services m: 0425 203 049 e: abacustrees@gmail.com

Landscape Consultant JK's Gardencreations p: 0412582966 e: gardenflora704@gmail.com

P2 P3 P4 Consultant Issue Consultant Issue

Description

For Information Hunter Water Issue Development Application

19/05/2021 16/06/2021 30/06/2021 9/07/2021 16/07/2021

Multi Dwelling 335 Lambton Road **New Lambton**

Lambton Road Developments PTY LTD SITE ANALYSIS PLAN

@ A3

DRAWN

Drawing Number DA010

Project Number

20151

QA CHECKED










EXISTING TREE TO BE RETAINED

TO BE DEMOLISHED

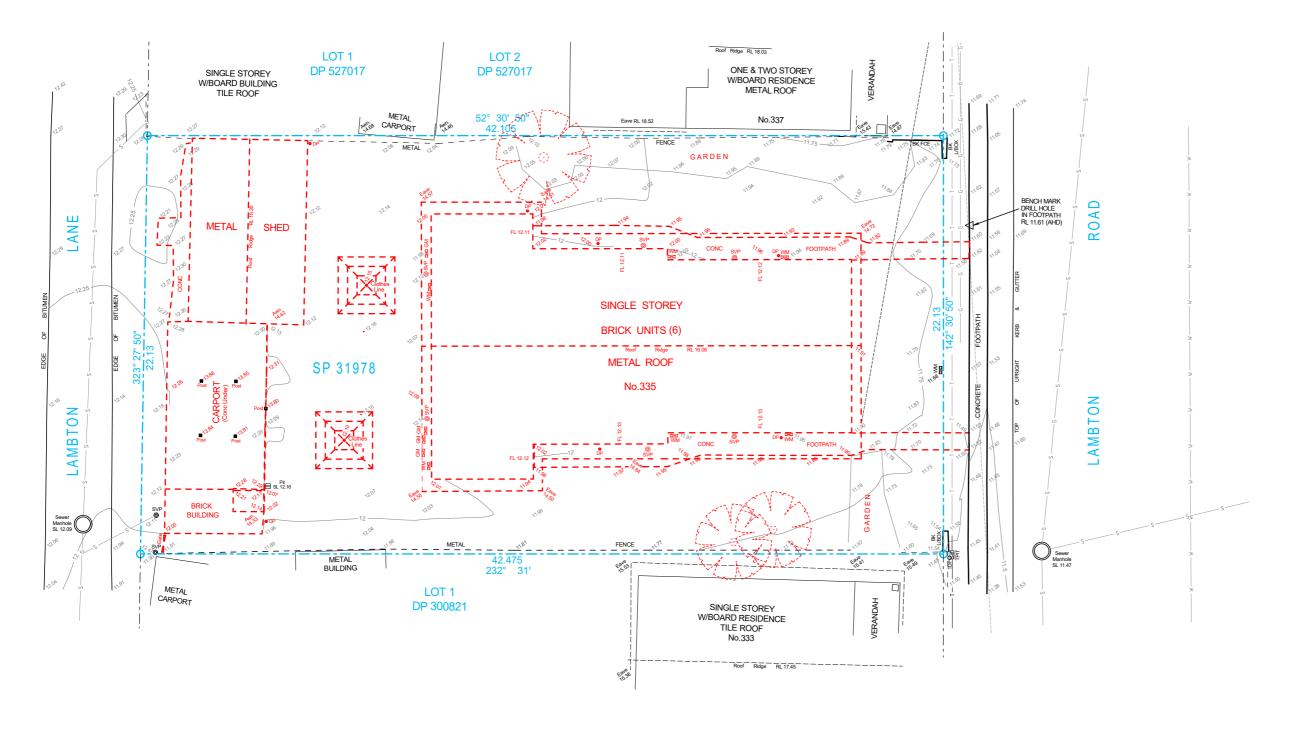



FOR AUTHORITY APPROVAL ONLY NOT FOR CONSTRUCTION

PO Box 601 Kotara NSW 2289 Ph 49524425 Nominated Architect: Daniel Hadley 8209



Town Planner Piper Planning Pty Ltd p: 0401660152 e: piperplanning.com.au

Civil Engineer MPC Consulting Engineers p: 02 4927 5566 e: admin@mpceng.com.au Energy Assessor Evergreen Energy Consultants p: (02) 4975 5350 m: 0407 886 275 e: joseph@evergreenec.com.au Structural Engineer MPC Consulting Engineers p: 02 4927 5566 e: admin@mpceng.com.au

Arborist Abacus Tree Services m: 0425 203 049 e: abacustrees@gmail.com

Landscape Consultant JK's Gardencreations p: 0412582966 e: gardenflora704@gmail.com

P1 P2 P3 P4 A Consultant Issue Consultant Issue Hunter Water Issue

Description

17/02/2021 16/06/2021 30/06/2021 9/07/2021 16/07/2021

Multi Dwelling 335 Lambton Road **New Lambton** Lambton Road

Developments PTY LTD

DEMOLITION PLAN 1:200 @ A3

DRAWN


JG

QA CHECKED

sv

Drawing Number DA020 Project Number 20151



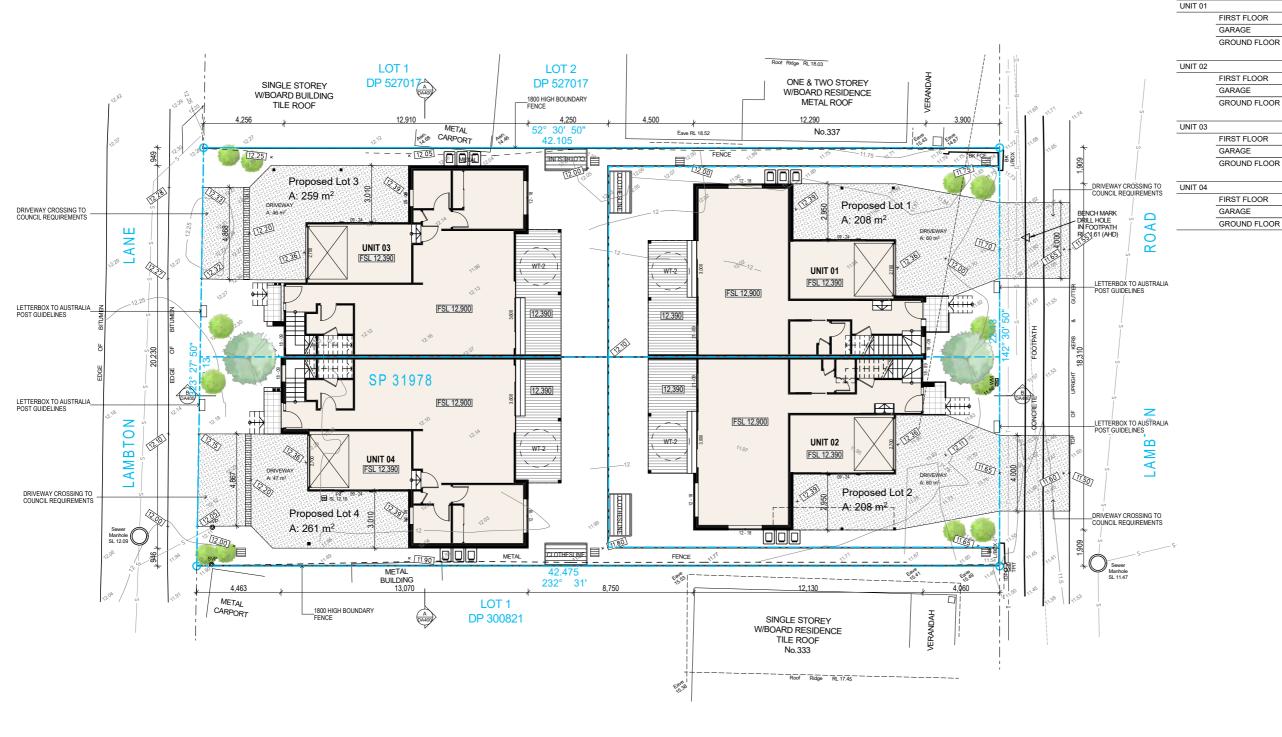

AREA CALCULATION (m2) AREAS SITE AREA 936m² FLOOR SPACE RATIO (MAX 0.60) 0.65 141 DEEP SOIL DRIVEWAY 213 LANDSCAPING 280 TOTAL GFA 611m² 208 Proposed Lot 1 LANDSCAPE 208 280m² Proposed Lot 2 30% Proposed Lot 3 259 Proposed Lot 4 261 DEEP SOIL 141m² 15% FIRST FLOOR 88 GARAGE SITE LEGEND GROUND FLOOR 62 WT-1 4,000 LITRE ABOVE GROUND WATER STORAGE TANK TO ENGINEERS AND FIRST FLOOR 87 GARAGE 17

BASIX DETAILS



62

18

78

78

17

78

4,000 LITRE UNDER GROUND WATER STORAGE TANK TO ENGINEERS AND BASIX DETAILS

RW

RETAINING WALLS TO ENGINEERS SPECIFICATIONS & DETAILS



EXISTING TREE TO BE PROPOSED BUILDING



EXISTING BUILDING

SITE NOTES

1. GFA (GROSS FLOOR AREA) AS DEFINED BY THE LOCAL COUNCIL

2. PLEASE REFER TO CONSULTING ENGINEERS DRAWINGS FOR STORMWATER DETAILS

3. FOR ROADWAY, DRIVEWAY AND RETAINING WALL DESIGN & LEVELS REFER TO CIVIL ENGINEERS DOCUMENTATION

4. DOWNPIPE POSITIONS ARE INDICATIVE ONLY, POSITION OF DOWNPIPES TO BE CONFIRMED BY HYDRAULIC ENGINEER OR BUILDER.

5 FOR LANDSCAPE DESIGN & FENCE LOCATIONS REFER TO LANDSCAPE DESIGNERS DOCUMENTATION



FOR AUTHORITY APPROVAL ONLY NOT FOR CONSTRUCTION

PO Box 601 Kotara NSW 2289 Ph 49524425 Nominated Architect: Daniel Hadley 8209

nation contained in the document is copyright and may not be used or d for any other project or purpose. limensions and levels on site and report any discrepancies prior to the ement of work and any ordering of materials. are to be read in conjunction with all contract documents.

Town Planner Piper Planning Pty Ltd p: 0401660152 e: piperplanning.com.au

Consultants

Civil Engineer MPC Consulting Engineers p: 02 4927 5566 Energy Assessor Evergreen Energy Consultants p: (02) 4975 5350 m: 0407 886 275 e: joseph@evergreenec.com.au

Structural Engineer MPC Consulting Engineers p: 02 4927 5566

Abacus Tree Services m: 0425 203 049 e: abacustrees@gmail.com

Landscape Consultant JK's Gardencreations p: 0412582966 e: gardenflora704@gmail.cor

P5 P6 P7 For Information Consultant Issue For Review P8 P9 P10 Consultant Issue Hunter Water Issue Consultant Issue

Description

Development Application

27/04/2021 19/05/2021 16/06/2021 28/06/2021 30/06/2021 9/07/2021 12/07/2021

16/07/2021

Multi Dwelling 335 Lambton Road **New Lambton** Lambton Road

Developments PTY LTD

SITE PLAN 1:200 @ A3


DRAWN


JG

QA CHECKED sv

Drawing Numbe DA030 Project Numbe 20151



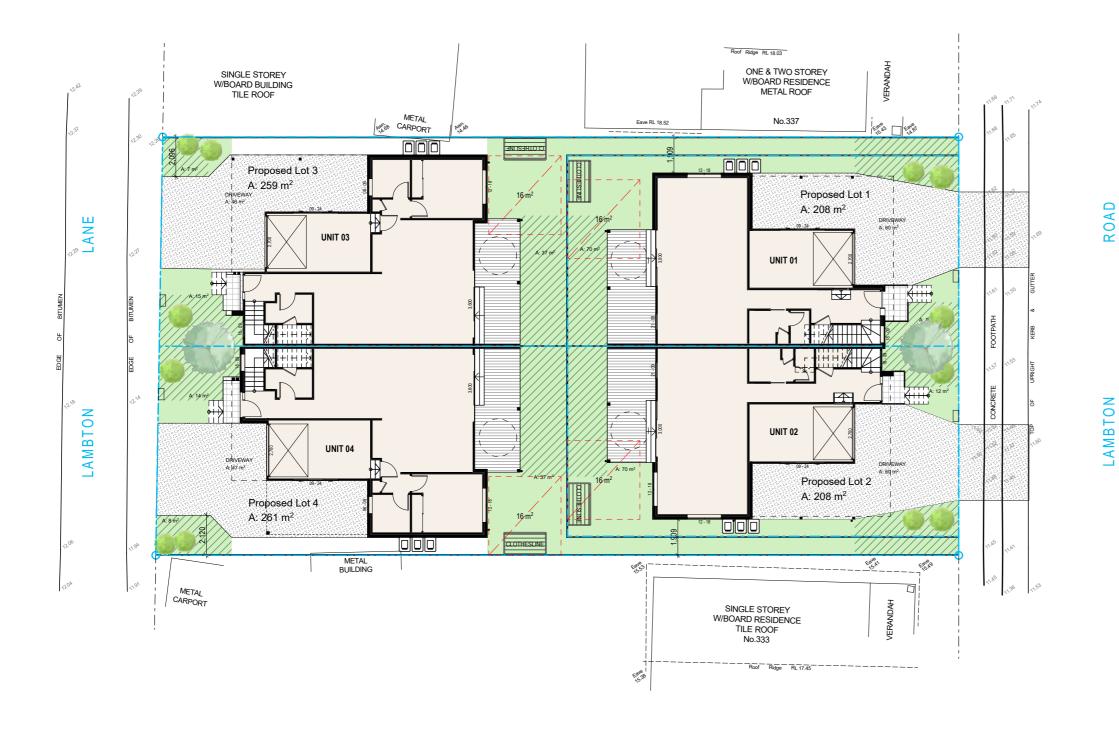

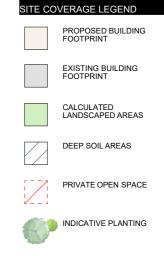

SITE COVERAGE NOTES

1. PLEASE REFER TO CONSULTING ENGINEERS DRAWINGS FOR STORMWATER DETAILS

2. FOR ROADWAY, DRIVEWAY AND RETAINING WALL DESIGN & LEVELS REFER TO CIVIL ENGINEERS DOCUMENTATION

3. FOR LANDSCAPE DESIGN & FENCE LOCATIONS REFER TO LANDSCAPE DESIGNERS DOCUMENTATION



FOR AUTHORITY APPROVAL ONLY NOT FOR CONSTRUCTION

PO Box 601 Kotara NSW 2289 Ph 49524425 Nominated Architect: Daniel Hadley 8209 Notes The information contained in the document is copyright

formation contained in the document is copyright and may not be used or used for any other project or purpose. all dimensions and levels on site and report any discrepancies prior to the encoment of work and any ordering of materials. give are to be read in conjunction with all contract documents.



Consultants

Civil Engineer MPC Consulting Engineers p: 02 4927 5566 e: admin@mpceng.com.au Town Planner Piper Planning Pty Ltd p: 0401660152 e: piperplanning.com.au

Energy Assessor Evergreen Energy Consultants p: (02) 4975 5350 m: 0407 886 275 e: joseph@evergreenec.com.au

Structural Engineer MPC Consulting Engineers p: 02 4927 5566 e: admin@mpceng.com.au Arborist Abacus Tree Services m: 0425 203 049 e: abacustrees@gmail.com

Landscape Consultant JK's Gardencreations p: 0412582966 e: gardenflora704@gmail.com

P2 P3 P4 P5 P6 P7 P8 A

Description For Review For Review For Review For Information Consultant Issue Consultant Issue

Hunter Water Issue

Development Application

2/03/2021 9/04/2021 27/04/2021 19/05/2021 16/06/2021 30/06/2021 9/07/2021

Developments PTY LTD

16/07/2021

Multi Dwelling 335 Lambton Road **New Lambton** Lambton Road

SITE COVERAGE PLAN

JG

1:200 @ A3 DRAWN

DA035 Project Number

20151

QA CHECKED

sv

Drawing Number



VIEW OF UNIT 03 & UNIT 04 FROM LANEWAY



VIEW OF UNIT 01 & UNIT 02 FROM LAMBTON ROAD



PO Box 601 Kotara NSW 2289 Ph 49524425 Nominated Architect: Daniel Hadley 8209

Notinitated Articitiest. Darlier hadrely 2029

Notes

Notes

Notes

Articles

Notes

Articles

Notes

Consultants

Surveyor Positive Survey Solutions p: 02 4960 1111 e: brett@psurveys.com.au

Town Planner Piper Planning Pty Ltd p: 0401660152 e: piperplanning.com.au

Civil Engineer MPC Consulting Engineers p: 02 4927 5566 e: admin@mpceng.com.au

Energy Assessor Evergreen Energy Consultants p: (02) 4975 5350 m: 0407 886 275 e: joseph@evergreenec.com.au

Structural Engineer MPC Consulting Engineers p: 02 4927 5566 e: admin@mpceng.com.au

Arborist Abacus Tree Services m: 0425 203 049 e: abacustrees@gmail.com

Landscape Consultant JK's Gardencreations p: 0412582966 e: gardenflora704@gmail.com

P1 P2 P3 P4 P5 P6 P7 A

Description

Hunter Water Issue

Development Application

For Review For Information Consultant Issue For Review For Review Consultant Issue

27/04/2021 19/05/2021 16/06/2021 25/06/2021 28/06/2021 30/06/2021

9/07/2021 16/07/2021

Multi Dwelling 335 Lambton Road

New Lambton Lambton Road Developments PTY LTD

PERSPECTIVES


@ A3 DRAWN


JG

QA CHECKED

Drawing Number DA040

Project Number 20151

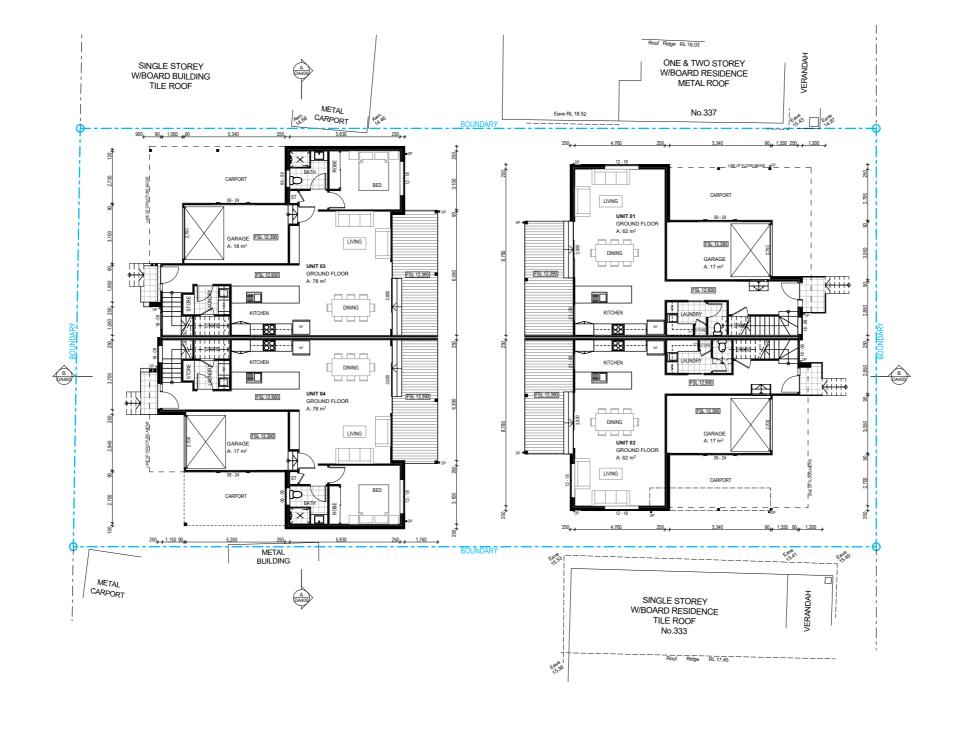

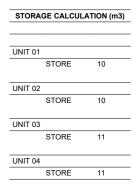



PO Box 601 Kotara NSW 2289 Ph 49524425 Nominated Architect: Daniel Hadley 8209

nation contained in the document is copyright and may not be used or 1 for any other project or purpose. imensions and levels on site and report any discrepancies prior to the ement of work and any ordering of materials. are to be read in conjunction with all contract documents.



Consultants

Town Planner Piper Planning Pty Ltd p: 0401660152 e: piperplanning.com.au Energy Assessor Evergreen Energy Consultants p: (02) 4975 5350 m: 0407 886 275 e: joseph@evergreenec.com.au

Arborist Abacus Tree Services m: 0425 203 049 e: abacustrees@gmail.com

Landscape Consultant JK's Gardencreations p: 0412582966 e: gardenflora704@gmail.com

Description For Review P3 P4 P5 P6 P7 P8 P9 A For Review For Information Consultant Issue For Review Consultant Issue Hunter Water Issue

Development Applicatio

9/04/2021 27/04/2021 19/05/2021 16/06/2021 28/06/2021 30/06/2021 9/07/2021 Developments PTY LTD 16/07/2021

Multi Dwelling 335 Lambton Road **New Lambton** Lambton Road

1:200 @ A3 DRAWN

JG

GROUND FLOOR QA CHECKED


sv

Drawing Number DA100

Project Number

20151



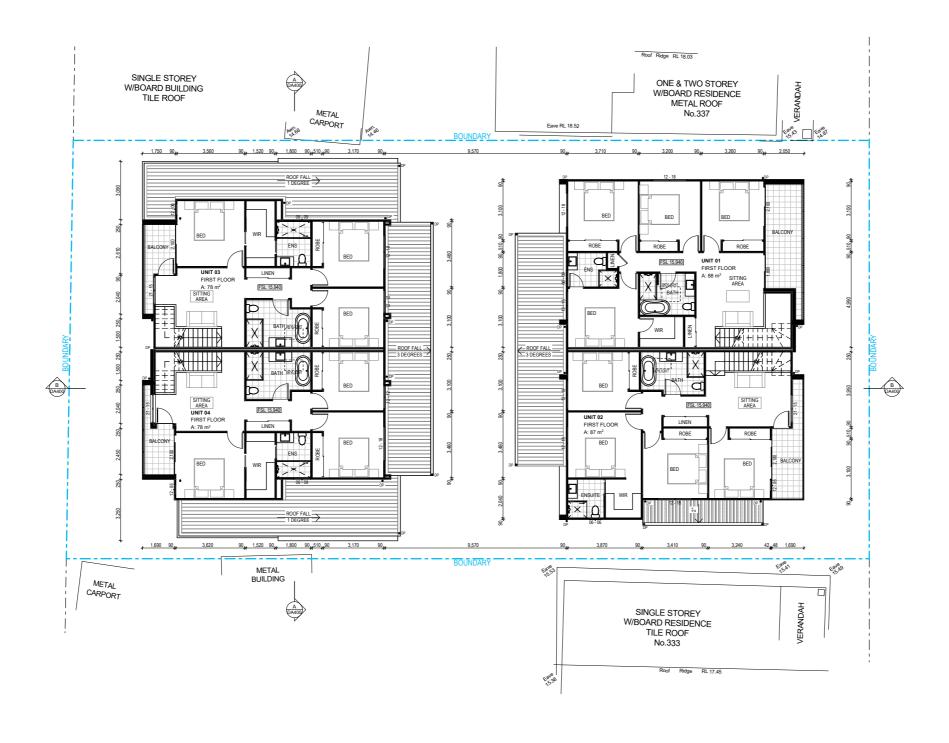



PO Box 601 Kotara NSW 2289 Ph 49524425 Nominated Architect: Daniel Hadley 8209

nation contained in the document is copyright and may not be used or of for any other project or purpose. dimensions and levels on site and report any discrepancies prior to the extended of work and any ordering of materials. are to be read in conjunction with all contract documents.



Consultants

Civil Engineer MPC Consulting Engineers p: 02 4927 5566 e: admin@mpceng.com.au Town Planner Piper Planning Pty Ltd p: 0401660152 e: piperplanning.com.au

Energy Assessor Evergreen Energy Consultants p: (02) 4975 5350 m: 0407 886 275 e: joseph@evergreenec.com.au

Structural Engineer MPC Consulting Engineers p: 02 4927 5566 e: admin@mpceng.com.au

Arborist Abacus Tree Services m: 0425 203 049 e: abacustrees@gmail.com

Landscape Consultant JK's Gardencreations p: 0412582966 e: gardenflora704@gmail.com

P3 P4 P5 P6 P7 P8 P9 A

Description For Review 27/04/2021 For Information 19/05/2021 Consultant Issue 16/06/2021 28/06/2021 For Review Consultant Issue 30/06/2021 Hunter Water Issue 9/07/2021

Development Applicatio

Multi Dwelling **New Lambton** Lambton Road Developments PTY LTD

16/07/2021

335 Lambton Road

FIRST FLOOR

1:200 @ A3 DRAWN


JG

Drawing Number DA110 Project Number 20151

QA CHECKED

sv



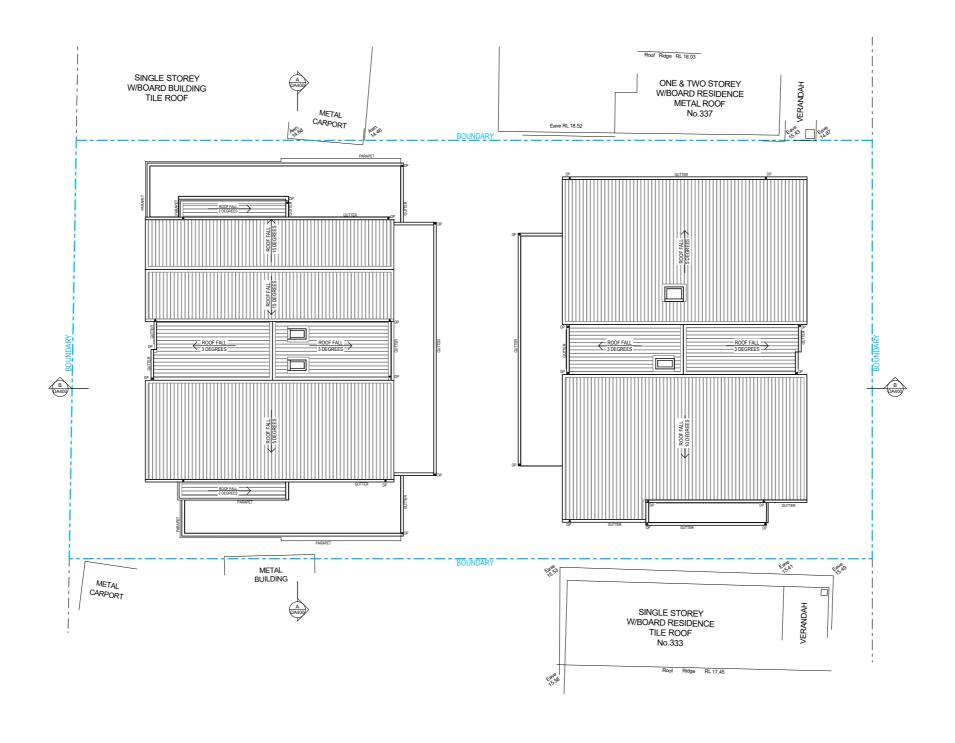



PO Box 601 Kotara NSW 2289 Ph 49524425 Nominated Architect: Daniel Hadley 8209 Notes The information contained in the document is copyright

Notinitiated Architects: Darlier Hadrely 2019

Notes

Notes

The Mode of the M

Town Planner Piper Planning Pty Ltd p: 0401660152 e: piperplanning.com.au

Civil Engineer MPC Consulting Engineers p: 02 4927 5566 e: admin@mpceng.com.au Energy Assessor Evergreen Energy Consultants p: (02) 4975 5350 m: 0407 886 275 e: joseph@evergreenec.com.au

Structural Engineer MPC Consulting Engineers p: 02 4927 5566 e: admin@mpceng.com.au Arborist Abacus Tree Services m: 0425 203 049 e: abacustrees@gmail.com

Landscape Consultant JK's Gardencreations p: 0412582966 e: gardenflora704@gmail.com

P1 P2 P3 P4 P5 A Description Consultant Issue For Review Consultant Issue

16/06/2021 28/06/2021 30/06/2021 Hunter Water Issue 9/07/2021

Multi Dwelling 335 Lambton Road **New Lambton**

Developments PTY LTD

Client Lambton Road

ROOF PLAN

1:200 @ A3 DRAWN

JG

Drawing Number DA150 Α Project Number QA CHECKED 20151

sv





ELEVATION NOTES

- 1. REFER TO EXTERNAL FINISHES FOR SELECTED MATERIALS AND COLOURS
- 2. REFER TO CONSULTING ENGINEERS DRAWINGS FOR STORMWATER DETAILS
- 3. FOR ROADWAY, DRIVEWAY AND RETAINING WALL DESIGN & LEVELS REFER TO CIVIL ENGINEERS DOCUMENTATION
- 4. DOWNPIPE POSITIONS ARE INDICATIVE ONLY, POSITION OF DOWNPIPES TO BE CONFIRMED BY BUILDER.
- 5. FOR LANDSCAPE DESIGN & FENCE LOCATIONS REFER TO LANDSCAPE DESIGNERS DOCUMENTATION



FOR AUTHORITY APPROVAL ONLY NOT FOR CONSTRUCTION

O Box 601 Kotara
SW 2289 Ph 49524425
Iominated Architect: Daniel Hadley 8209
otes
he information contained in the document is copyright and may not be used or produced for any other project or purpose.
erify all dimensions and levels on site and report any discrepancies prior to the
rawings are to be read in conjunction with all contract documents.
se figured dimensions only. Do not scale from drawings.
LK Designs cannot guarantee the accuracy of content and format for copies of drawing

Consultants

Surveyor Positive Survey Solutions p: 02 4960 1111 e: brett@psurveys.com.au

1:200

Town Planner Piper Planning Pty Ltd p: 0401660152 e: piperplanning.com.au

Civil Engineer MPC Consulting Engineers p: 02 4927 5566 e: admin@mpceng.com.au

Structural Engineer MPC Consulting Engineers p: 02 4927 5566 e: admin@mpceng.com.au Energy Assessor Evergreen Energy Consultants p: (02) 4975 5350 m: 0407 886 275 e: joseph@evergreenec.com.au

Arborist Abacus Tree Services m: 0425 203 049 e: abacustrees@gmail.com

Landscape Consultant JK's Gardencreations p: 0412582966 e: gardenflora704@gmail.com

P2 P3 P4 P5 P6 A

Description

For Review For Information Consultant Issue For Review Consultant Issue Hunter Water Issue Development Application 16/07/2021

27/04/2021 19/05/2021 16/06/2021 28/06/2021 30/06/2021 9/07/2021

Multi Dwelling 335 Lambton Road **New Lambton** Lambton Road

Developments PTY LTD

ELEVATIONS

1:200 @ A3 DRAWN

JG

DA300 Project Numbe 20151

QA CHECKED

sv

Drawing Numbe





E-06 INTERNAL EAST ELEVATION



FOR AUTHORITY APPROVAL ONLY NOT FOR CONSTRUCTION

PO Box 601 Kotara NSW 2289 Ph 49524425 Nominated Architect: Daniel Hadley 8209 Notes The information contained in the document is copyright reproduced for any other project or purpose Notinitiated Architects: Darlier Hadrely 2019

Notes

Notes

The Mode of the M

Consultants

Surveyor Positive Survey Solutions p: 02 4960 1111 e: brett@psurveys.com.au

Town Planner Piper Planning Pty Ltd p: 0401660152 e: piperplanning.com.au

Civil Engineer MPC Consulting Engineers p: 02 4927 5566 e: admin@mpceng.com.au Energy Assessor Evergreen Energy Consultants p: (02) 4975 5350 m: 0407 886 275 e: joseph@evergreenec.com.au

Structural Engineer MPC Consulting Engineers p: 02 4927 5566 e: admin@mpceng.com.au Arborist Abacus Tree Services m: 0425 203 049 e: abacustrees@gmail.com

Landscape Consultant JK's Gardencreations p: 0412582966 e: gardenflora704@gmail.com

P1 P2 P3 P4 P5 A

Description For Information Consultant Issue For Review Consultant Issue Hunter Water Issue

19/05/2021 16/06/2021 28/06/2021 30/06/2021 9/07/2021 16/07/2021

Multi Dwelling

335 Lambton Road **New Lambton** Client Lambton Road

Developments PTY LTD

Drawing ELEVATIONS

1:200 @ A3 DRAWN


JG

QA CHECKED

sv

Drawing Number DA301 Α Project Number 20151



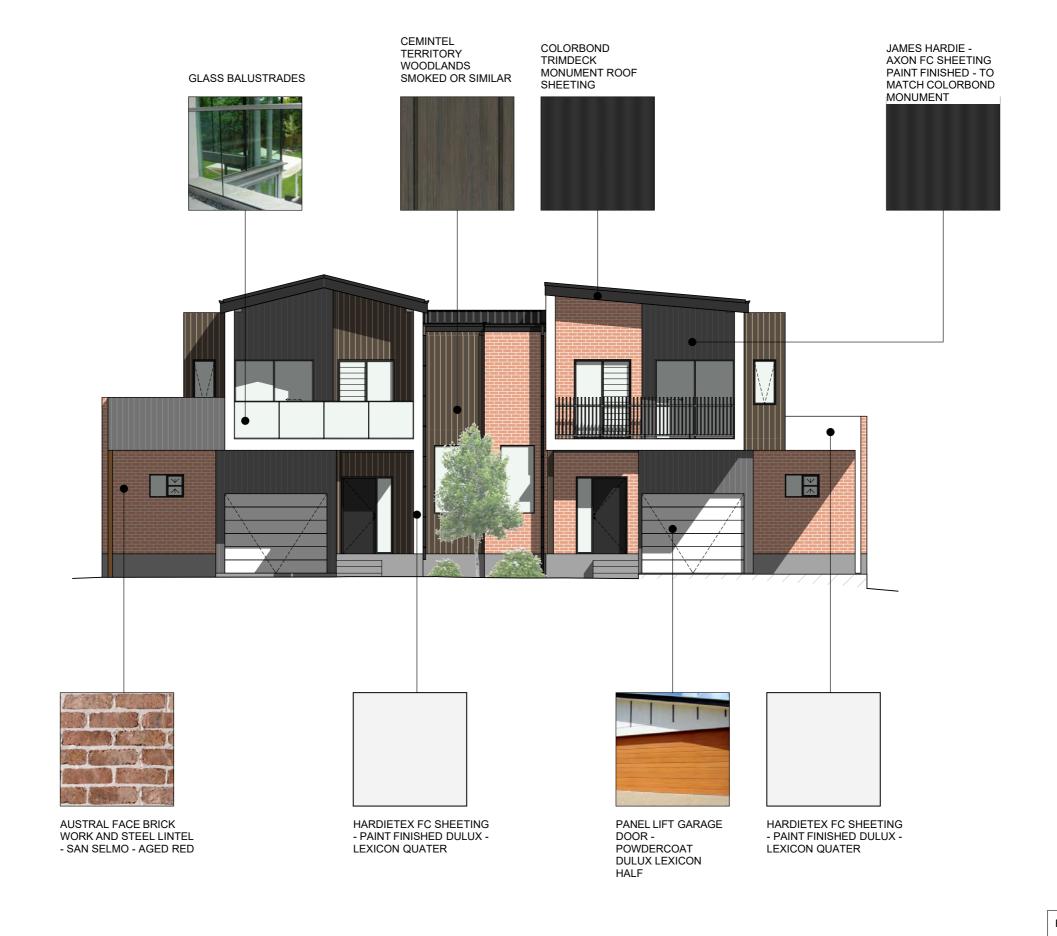



PO Box 601 Kotara NSW 2289 Ph 49524425 Nominated Architect: Daniel Hadley 8209 Notes The information contained in the document is copyright reproduced for any other project or purpose.

Notinitiated Architect. Daffier Hadley 2029

Notes

The Move of the Counter is copylight and may not be used or the counter is copylight and may not be used or the counter is copylight and may not be used or the counter of the commencement of work and any ordering of materials.

Drawings are to be read in conjunction with all contract documents.

Use figured dimensions only. Do not scale from drawings.

ELK Designs cannot guarantee the accuracy of content and format for copies of drawing issued electronically.

See the counter of the counter of content and format for copies of drawing issued electronically of the counter of the counter of counter of the coun

Consultants

Town Planner Piper Planning Pty Ltd p: 0401660152 e: piperplanning.com.au

Civil Engineer MPC Consulting Engineers p: 02 4927 5566 e: admin@mpceng.com.au

Energy Assessor Evergreen Energy Consultants p: (02) 4975 5350 m: 0407 886 275 e: joseph@evergreenec.com.au

Structural Engineer MPC Consulting Engineers p: 02 4927 5566 e: admin@mpceng.com.au Arborist Abacus Tree Services m: 0425 203 049 e: abacustrees@gmail.com

P1 P2 P3 P4 P5 A

For Review Consultant Issue For Review Consultant Issue

Description

Hunter Water Issue

27/04/2021 16/06/2021 28/06/2021 30/06/2021 9/07/2021

Multi Dwelling

335 Lambton Road **New Lambton**

Client Lambton Road

Developments PTY LTD

EXTERNAL FINISHES

1:100 @ A3

JG

DRAWN


Drawing Number DA350

QA CHECKED

sv

Project Number 20151



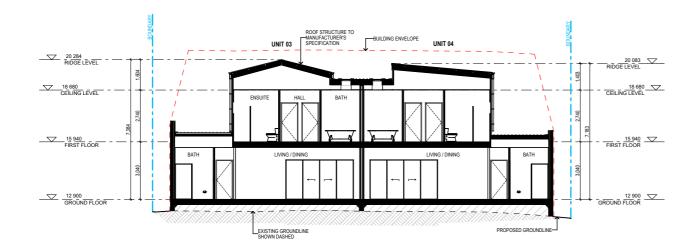





SECTION BB 1:200



FOR AUTHORITY APPROVAL ONLY NOT FOR CONSTRUCTION

Consultants

Surveyor Positive Survey Solutions p: 02 4960 1111 e: brett@psurveys.com.au

Town Planner Piper Planning Pty Ltd p: 0401660152 e: piperplanning.com.au

Energy Assessor Evergreen Energy Consultants p: (02) 4975 5350 m: 0407 886 275 e: joseph@evergreenec.com.au

Structural Engineer MPC Consulting Engineers p: 02 4927 5566 e: admin@mpceng.com.au Arborist Abacus Tree Services m: 0425 203 049 e: abacustrees@gmail.com Landscape Consultant JK's Gardencreations p: 0412582966 e: gardenflora704@gmail.com

P1 P2 P3 P4 P5 A Consultant Issue For Review Consultant Issue Hunter Water Issue

Description

19/05/2021 16/06/2021 28/06/2021 30/06/2021 9/07/2021

Multi Dwelling 335 Lambton Road **New Lambton** Client Lambton Road

Developments PTY LTD

Drawing SECTIONS

Scale 1:200 @ A3 DRAWN

JG

Drawing Number DA400 Project Number 20151


QA CHECKED

sv


SHADOW DIAGRAM LEGEND


AREA OF OPEN SPACE ACHIEVING SOLAR ACCESS


AREA OF RESIDENTS COMMUNAL OPEN SPACE WITH SOLAR ACCESS

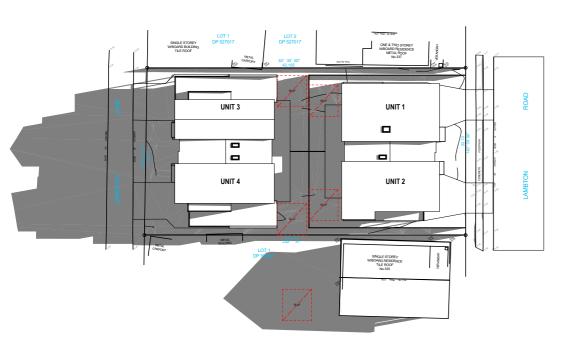

21 JUN at 09:00

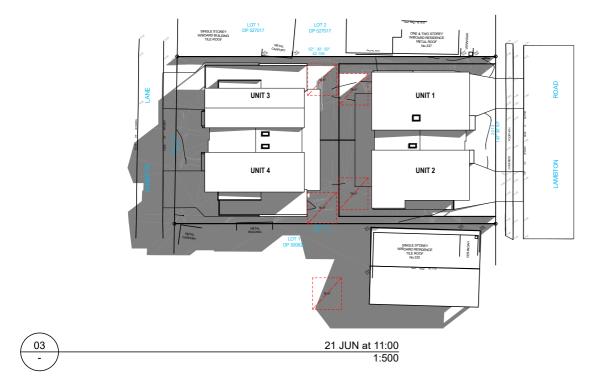

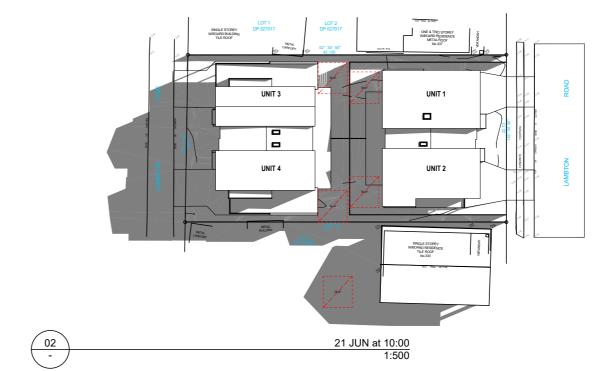

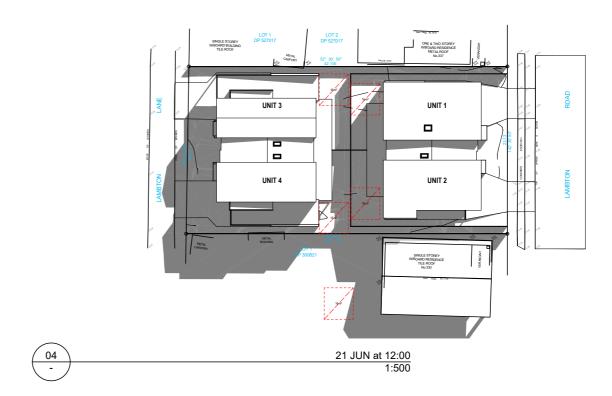



FOR AUTHORITY APPROVAL ONLY NOT FOR CONSTRUCTION

PO Box 601 Kotara NSW 2289 Ph 49524425 Nominated Architect: Daniel Hadley 8209 Notes The information contained in the document is copyright

Notinitated Architect. Dafine Inabilety 2019

Notes

Notes

Notes

The Notes

Notes

The Notes

Note



Consultants

Surveyor Positive Survey Solutions p: 02 4960 1111 e: brett@psurveys.com.au

Town Planner Piper Planning Pty Ltd p: 0401660152 e: piperplanning.com.au

Civil Engineer MPC Consulting Engineers p: 02 4927 5566 e: admin@mpceng.com.au

Energy Assessor Evergreen Energy Consultants p: (02) 4975 5350 m: 0407 886 275 e: joseph@evergreenec.com.au

Structural Engineer MPC Consulting Engineers p: 02 4927 5566 e: admin@mpceng.com.au Arborist Abacus Tree Services m: 0425 203 049 e: abacustrees@gmail.com Landscape Consultant JK's Gardencreations p: 0412582966 e: gardenflora704@gmail.com

P1 P2 P3 P4 A Consultant Issue

For Review Consultant Issue Hunter Water Issue Development Application

Description

9/07/2021

16/06/2021 28/06/2021 30/06/2021

16/07/2021

Multi Dwelling 335 Lambton Road **New Lambton** Lambton Road

Developments PTY LTD

DRAWN

JG

EXTERNAL SHADOW DIAGRAMS 1:500 @ A3

QA CHECKED

sv


Drawing Number DA900 Project Number 20151

SHADOW DIAGRAM LEGEND


AREA OF OPEN SPACE ACHIEVING SOLAR ACCESS



AREA OF RESIDENTS COMMUNAL OPEN SPACE WITH SOLAR ACCESS

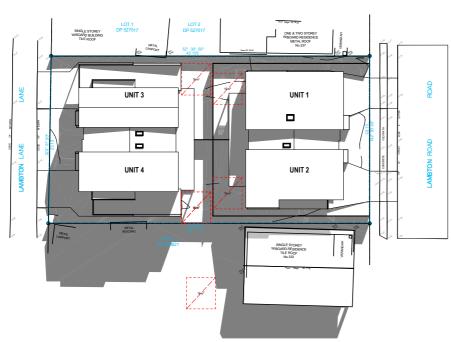

01 21 JUN at 13:00 1:500

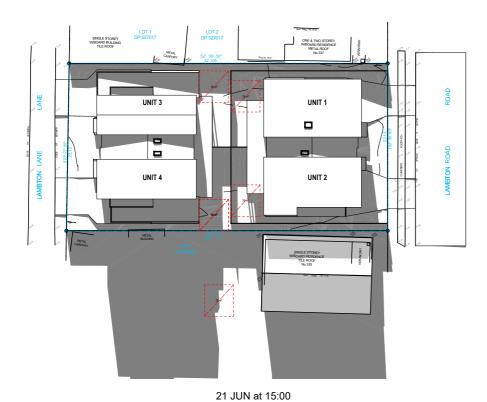

METAL CARPORT UNIT 3 UNIT 1 UNIT 4 UNIT 2 21 JUN at 14:00 1:500

FOR AUTHORITY APPROVAL ONLY NOT FOR CONSTRUCTION

03

PO Box 601 Kotara NSW 2289 Ph 49524425 Nominated Architect: Daniel Hadley 8209 Notes The information contained in the document is copyright

Notinitated Articitiest. Darlier hadrely 2029

Notes

Notes

Notes

Articles

Notes

Articles

Notes

Consultants

Town Planner Piper Planning Pty Ltd p: 0401660152 e: piperplanning.com.au

Civil Engineer MPC Consulting Engineers p: 02 4927 5566 e: admin@mpceng.com.au

Structural Engineer MPC Consulting Engineers p: 02 4927 5566 e: admin@mpceng.com.au Energy Assessor Evergreen Energy Consultants p: (02) 4975 5350 m: 0407 886 275 e: joseph@evergreenec.com.au

Arborist Abacus Tree Services m: 0425 203 049 e: abacustrees@gmail.com

Landscape Consultant JK's Gardencreations p: 0412582966 e: gardenflora704@gmail.com

P1 P2 P3 P4 A

02

Consultant Issue For Review Consultant Issue Hunter Water Issue Development Application

Description

9/07/2021

16/06/2021 28/06/2021 30/06/2021

16/07/2021

Multi Dwelling 335 Lambton Road **New Lambton** Lambton Road

Developments PTY LTD

DRAWN

JG

DIAGRAMS 1:500 @ A3

EXTERNAL SHADOW

DA901 Project Number 20151

QA CHECKED


sv

Drawing Number





9am Neighbouring Overshadow

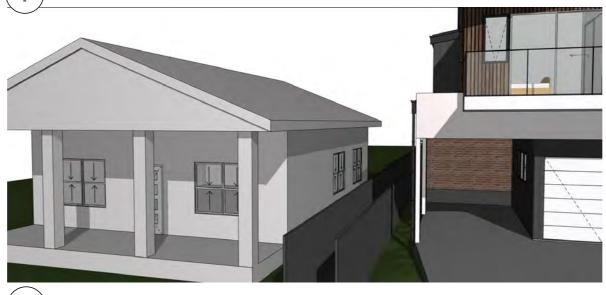

10am Neighbouring Overshadow



11am Neighbouring Overshadow

FOR AUTHORITY APPROVAL ONLY NOT FOR CONSTRUCTION

PO Box 601 Kotara

NSW 2289 Ph 49524425

Nominated Architect: Daniel Hadley 8209

Notes

Note

Consultants

Surveyor Positive Survey Solutions p: 02 4960 1111 e: brett@psurveys.com.au

Town Planner Piper Planning Pty Ltd p: 0401660152 e: piperplanning.com.au

Civil Engineer MPC Consulting Engineers p: 02 4927 5566 e: admin@mpceng.com.au

Energy Assessor Evergreen Energy Consultants p: (02) 4975 5350 m: 0407 886 275 e: joseph@evergreenec.com.au

Structural Engineer MPC Consulting Engineers p: 02 4927 5566 e: admin@mpceng.com.au

Arborist Abacus Tree Services m: 0425 203 049 e: abacustrees@gmail.com

Landscape Consultant JK's Gardencreations p: 0412582966 e: gardenflora704@gmail.com

P1 P2 P3 P4 P5 A Description For Review

For Review For Review Consultant Issue

Hunter Water Issue

Multi Dwelling 22/06/2021

25/06/2021 28/06/2021 30/06/2021 9/07/2021

335 Lambton Road 16/07/2021

New Lambton Client Lambton Road

Developments PTY LTD

Drawing NEIGHBOURING DWELLING SHADOW DIAGRAMS

1:410.19 @ A3

DRAWN

JG

Drawing Number DA902

QA CHECKED

sv

Project Number 20151



Sediment and erosion control

All erosion and sediment control measures to be installed prior to site

The project manager to inform all contractors and sub-contractors of their obligations under the erosion and sediment control plan.

Topsoil from all areas that will be disturbed to be stripped and stockpiled at the nominated site.

All sediment control structures to be inspected by site supervisor after each rainfall event for structural damage and all trapped sediment to be removed to a nominated stockpile site.

Sediment and erosion control shall be effectively maintained at all times during the course of construction and shall not be removed until the site has been stabilised or landscaped to the superintendent's satisfaction.

A single all weather access way will be provided at the front of the property consisting of 50-75 aggregate or similar material at a minimum thickness of 150 laid over needle-punched geotextile fabric and constructed prior to commencement of works.

The contractor shall ensure that no spoil or fill encroaches upon adjacent areas for the duration of works.

The contractor shall ensure that kerb inlets and drains receiving stormwater shall be protected at all times during development. Kerb inlet sediment traps shall be installed along the immediate vicinity along the street frontage.

Sediment fencing shall be secured by post (where metal star pickets are used plastic safety caps shall be used) at 3000 intervals with geotextile fabric embedded 200 in soil.

All topsoil stripped from the site and stockpiled does not interfere with drainage lines and stormwater inlets and will be suitably covered with an impervious membrane material and screened by sediment fencing.

Soil conservation

Prior to commencement of construction provide 'sediment fence,' 'sediment trap' and washout area to ensure the capture of water borne material generated from the site.


Maintain the above during the course of construction, and clear the 'sediment trap after each storm.


Sediment trap

1000 x 1000 wide 500 deep pit, located at the lowest point to the trap

Sediment fence

Provide sediment fence on down slope boundary as shown on plan. Fabric to be buried below ground at lower edge.

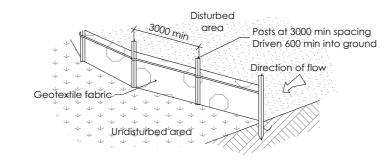


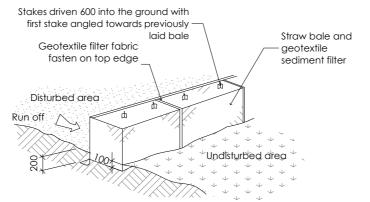

Drainage area 0.5 ha. max. slope gradient 1:2 max. slope length 50m.


Washout area

to be 1800 x 1800 allocated for the washing of tool and equipment

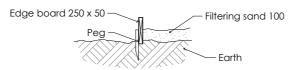


Vehicle access to site

Vehicle access to the building site should be restricted to a single point so as to reduce the amount of soil deposited on the street pavement.

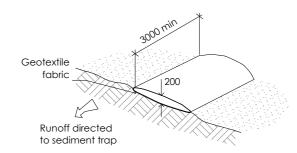


Building material stockpiles

All stockpiles of building material such as sand and soil must be protected to prevent scour and erosion.they should never be placed in the street gutter where they will wash away with the first rainstorm.

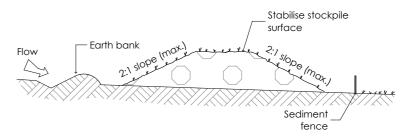

Sandbag kerb sediment trap

In certain circumstances extra sediment trapping may be needed in the street autter.

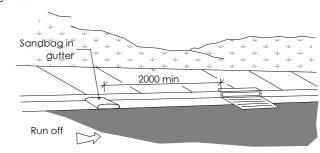



FOR AUTHORITY APPROVAL ONLY NOT FOR CONSTRUCTION

PO Box 601 Kotara ted Architect: Daniel Hadley 8209

ained in the document is copyright and may not be used or other project or purpose. is and levels on site and report any discrepancies prior to the work and any ordering of materials. read in conjunction with all contract documents.

Town Planner Piper Planning Pty Ltd p: 0401660152 e: piperplanning.com.au

Evergreen Energy Consultants p: (02) 4975 5350 m: 0407 886 275

Abacus Tree Services m: 0425 203 049 e: abacustrees@gmail

For Review P3 P4

Description Consultant Issue Consultant Issue Hunter Water Issue Development Application

16/06/2021 28/06/2021 30/06/2021 9/07/2021 16/07/2021

Multi Dwelling 335 Lambton Road **New Lambton**

Lambton Road

Developments PTY LTD


SEDIMENT CONTROL 1:100 @ A3

DA960 Project Numbe 20151

QA CHECKED

Drawing Numbe



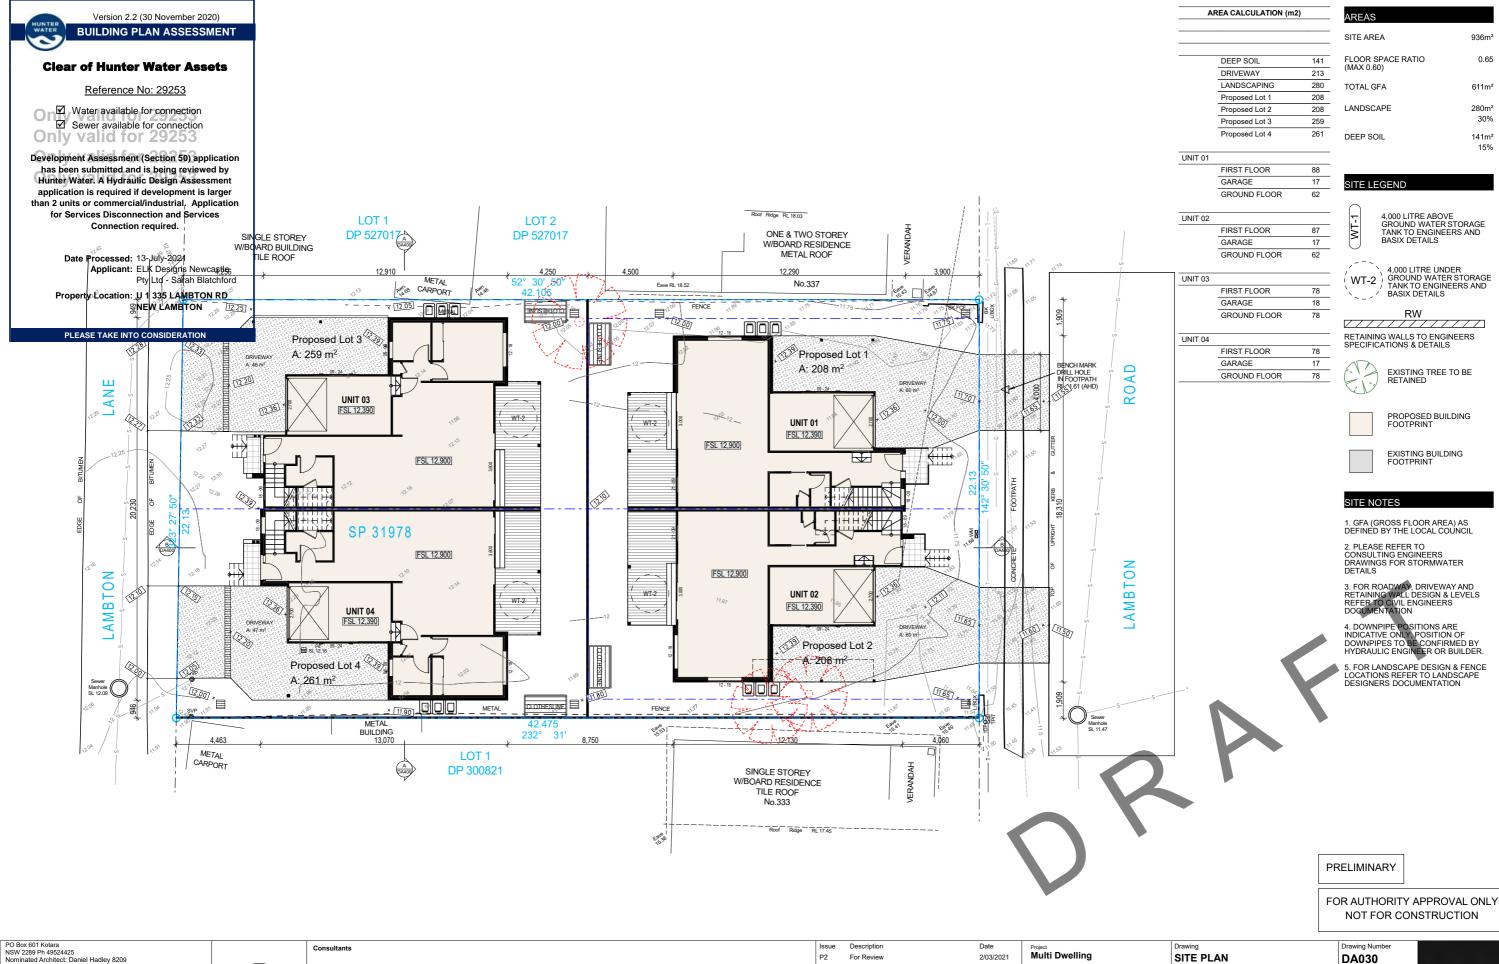

nation contained in the document is copyright and may not be used or d for any other project or purpose. Immensions and levels on site and report any discrepancies prior to the ement of work and any ordering of materials. For Review

For Review

For Information

Consultant Issue

Consultant Issue

Hunter Water Issu

For Review

P4

9/04/2021

27/04/2021

19/05/2021

16/06/2021

28/06/2021

30/06/2021

9/07/2021

335 Lambton Road

1:200 @ A3

DRAWN

New Lambton

Lambton Road

Developments PTY LTD

ELK


P9

QA CHECKED

sv

Project Numbe

20151

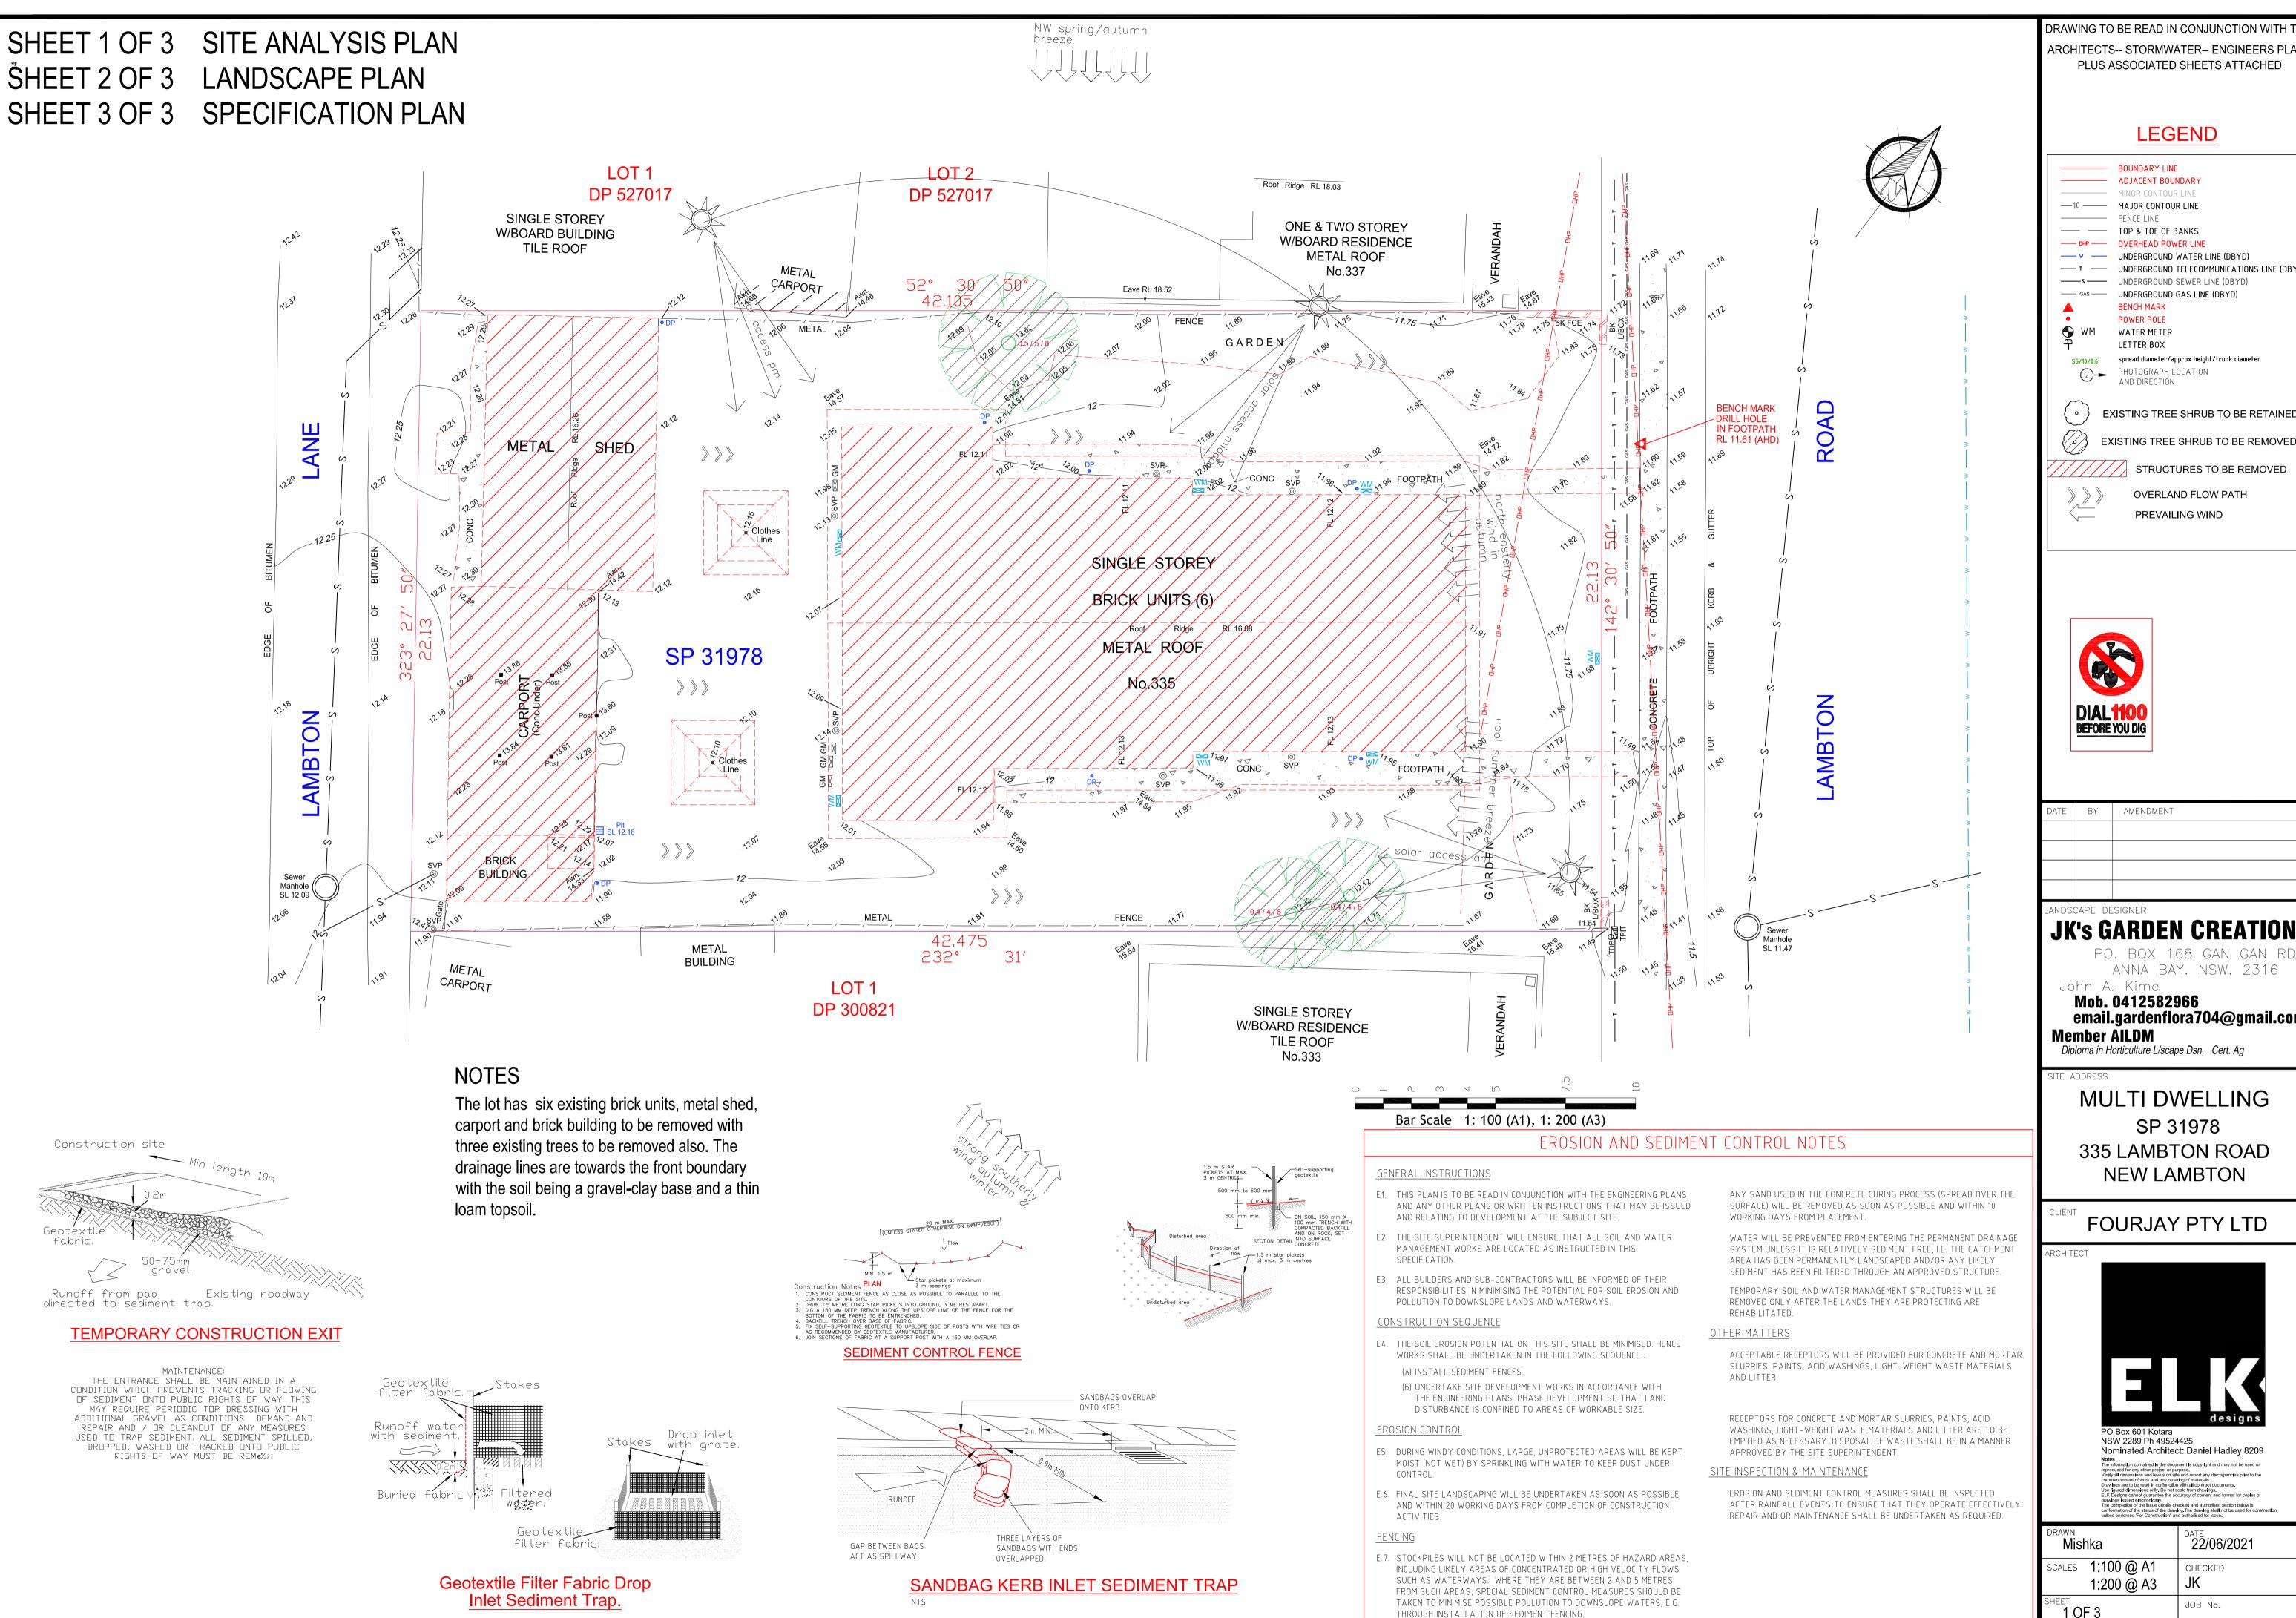

DRAWING TO BE READ IN CONJUNCTION WITH TH ARCHITECTS-- STORMWATER-- ENGINEERS PLANS PLUS ASSOCIATED SHEETS ATTACHED

LEGEND

ADJACENT BOUNDARY —10 — MAJOR CONTOUR LINE TOP & TOE OF BANKS

UNDERGROUND WATER LINE (DBYD) -----s ---- UNDERGROUND SEWER LINE (DBYD) UNDERGROUND GAS LINE (DBYD)

> WATER METER spread diameter/approx height/trunk diameter

EXISTING TREE SHRUB TO BE RETAINED

STRUCTURES TO BE REMOVED

OVERLAND FLOW PATH PREVAILING WIND



AMENDMENT

JK's GARDEN CREATIONS

PO. BOX 168 GAN GAN RD ANNA BAY. NSW. 2316

Mob. 0412582966 email.gardenflora704@gmail.com Member AILDM

Diploma in Horticulture L/scape Dsn, Cert. Ag

MULTI DWELLING SP 31978 335 LAMBTON ROAD **NEW LAMBTON**

FOURJAY PTY LTD





NSW 2289 Ph 49524425 Nominated Architect: Daniel Hadley 8209 Notes

The Information contained in the document is copyright and may not be used or reproduced for any other project or purpose.

Verify all dimensions and levels on site and report any discrepancies prior to the commencement of work and any ordering of materials.


Drawings are to be read in conjunction with all contract documents.

Use figured dimensions only. Do not scale from drawings.

ELK Designs cannot guarantee the accuracy of content and format for copies of drawings issued electronically.

The completion of the issue details checked and authorised section below is conformation of the status of the drawing. The drawing shall not be used for construction's and authorised for issue.

22/06/2021 scales 1:100 @ A1 CHECKED 1:200 @ A3 JK JOB No. FOUR300421 Site Analysis Plan

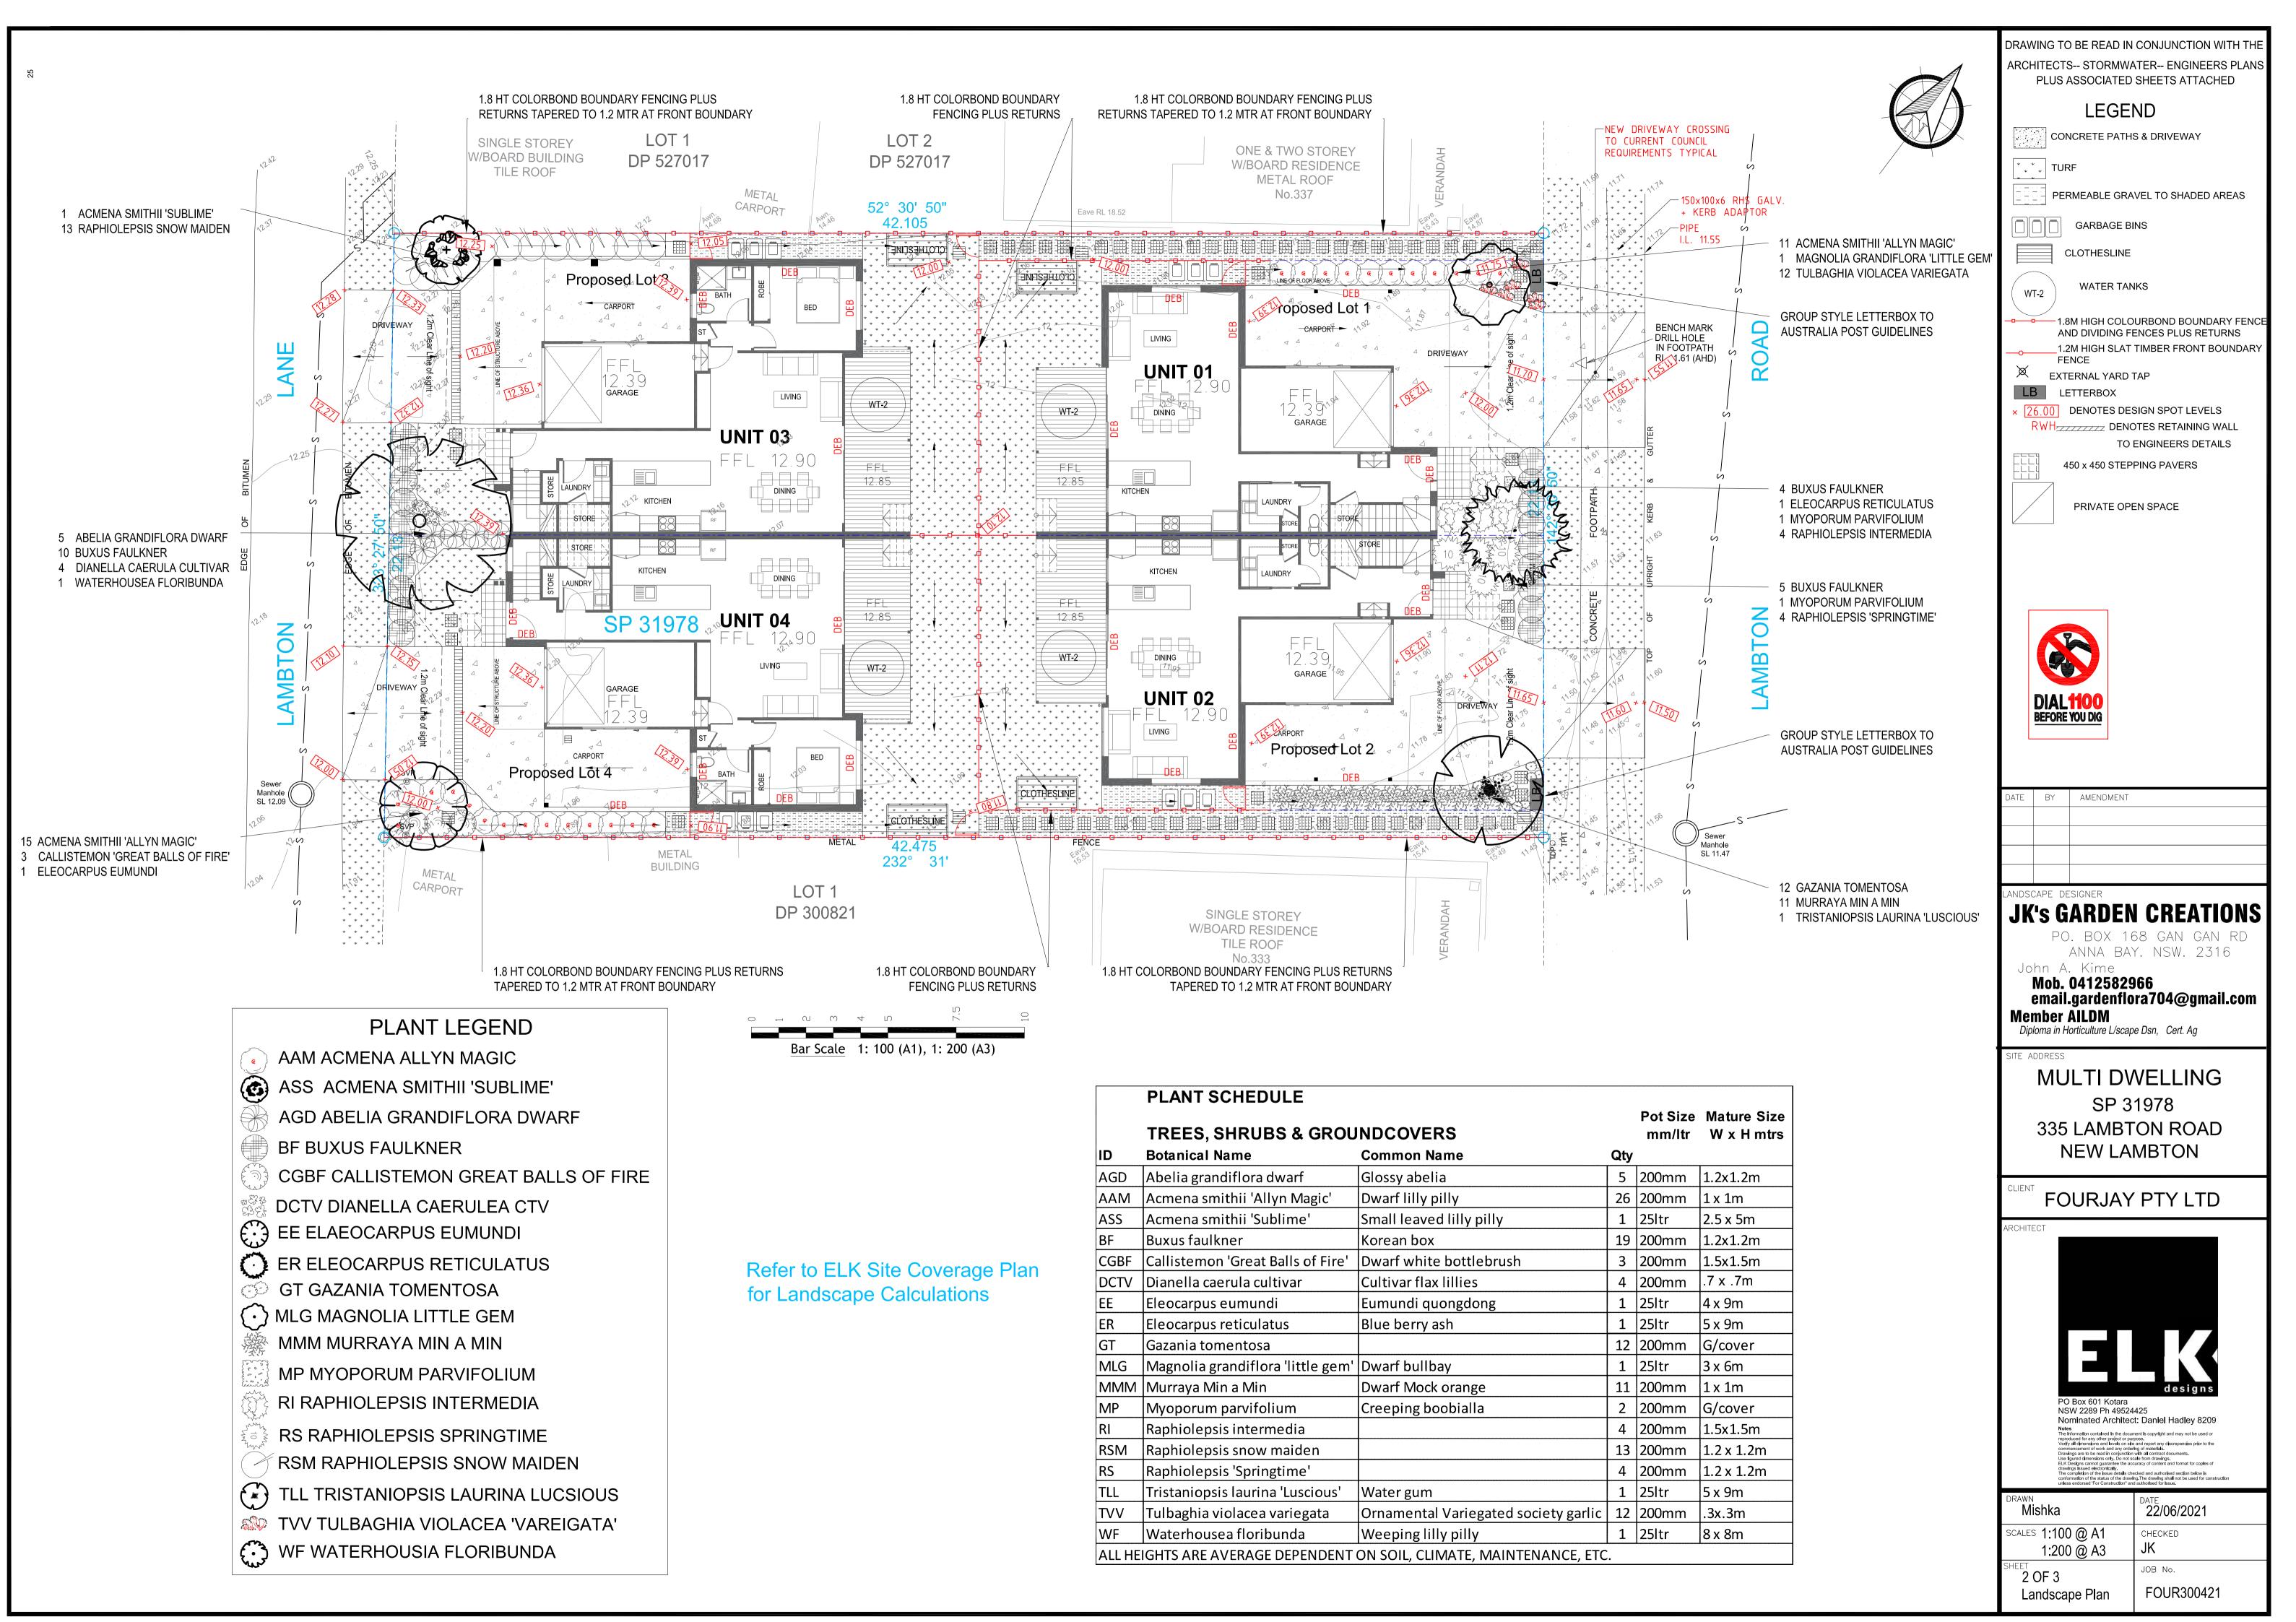

INITIAL PREPARATION

Verify all dimensions on site prior to commencement, locate all underground services and ensure no damage occurs to them throughout the contract. Comply with the requirements of the Council site guidelines in reference to erosion and sediment control regulations and other environmental controls to contain all within confines of the site. Spray with approved herbicide weed killer to all proposed lawn and garden areas to manufactures directions. Spray all weeds before commencement of any site works are carried and throughout the contract so as to suppress any weeds that may arise. Source all plants before start of job so the time factor to purchase from species list, will be true to plant schedule. The trees and shrubs recommended may sometimes be difficult to source due to times of year, weather, disease etc, this being the case, please inform early so arrangements to substitute can be made. Excess soils and contaminated soil are to removed within the guidelines of the council requirements to approved sites.

SOIL PREPARATION

Cultivate to the minimum depth of 200mm in all garden areas and 100mm depth in all lawn areas; add a clay breaker to all garden areas, before the addition of garden soil is added. In all areas where fill is required, gain required levels using a premium soil mix. Where excavation is required as with clay excavate as required to allow for addition of 200-400mm depth of premium garden soil to garden areas and 100-300mm depth of topsoil to lawn areas. Undertake all required action to ensure that no root balls of proposed plants sit in clay wells and that all garden and lawn areas drain satisfactorily. It is the contractor's responsibility to ensure the end result of the project is that all lawn and garden areas drain sufficiently (both surface and subsurface), are at required finished levels and have sufficient soil depths to enable lawn and plants to thrive and grow. Soil levels are to allow for the addition of turf and mulches to specified requirements.

GARDEN EDGING

EDGING: Timber edging shall be located to all planter bed edges where meeting new or existing turfed areas. Use 38x150mm treated pine edging with 50x50 pegs at 1200 centres finished 30mm below top of edging.

PLANTING

Purchase plants from an approved nursery that supplies plants that are true to type and species, healthy and able to store at nursery to maintain vigor before planting. Plant within 24hrs of plants being delivered. Set out plants as indicated on plan. Plant holes shall be dug approximately twice the width and 100mm deeper than the plant root balls that they are to receive. Add fertilizer, followed by 100mm of garden soil shall be placed into the base of hole and lightly consolidated. Remove plant from container install and backfill with garden soil and firmed into place. Base of stem shall finish flush with finished soil level. Thoroughly water all plants on first planting to soak soil of plant and surrounding soil so as to allow roots to adjust, do not allow drying out. Water regular over the first 3-4 weeks.

FERTILISING

Use slow release fertilizers such as osmocote and or agriform tablets on all plants.

MULCHING

Install 100mm minimum of Forest mulch as a mulch over all gardens. Shaded areas mulch with 10-25mm pebble mulch with weedmat under.

GRAVEL AREAS

- Consolidated crushed rhyolite, 100mm thick, over a compacted road base. Contain areas between gardens & gravel with timber edging.

RETAINING WALLS

Erection of masonry block retaining walls treated timber retaining walls to be as per retaining wall specification guidelines. All retaining walls and footings to remain within the confines of boundary.

TURF

Prepare for, level and lay cultivated Buffalo turf to all areas nominated on the plan as being lawn. To be layed within 24 hrs of delivery on site, making sure all areas are level for drainage, garden edging and paths.


COMPLETION

Prior to practical completion removal from site all unwanted debris occurring from work. Satisfy council that all landscaping work has been undertaken in strict accordance with council's landscape codes and guide lines.

At the completion of landscape works and prior to the issue of the Certificate of Practical Completion.


Carry out the following during the maintenance period (determined by Builder). These works shall include but not limited to watering, weeding, fertilizing, pest and disease control, returfing, staking and tying, replanting, cultivation, pruning, aerating, renovation, top dressing and the like. EXISTING TREES

The existing trees to be retained on site are to be protected by surrounding with a 1.8m high chainmesh fence 3.00m from the base of the tree. This fence is to be erected prior to works commencing on site and is to be retained until all building works are completed. The enclosed area is to remain free of materials, machinery, vehicles or site sheds. With this preparation is to protect the existing tree and its critical roots from mechanical damage, compaction or any other adverse impacts resulting from construction activity and allowing the trees to grow the optimum growth once all works have been finalized.

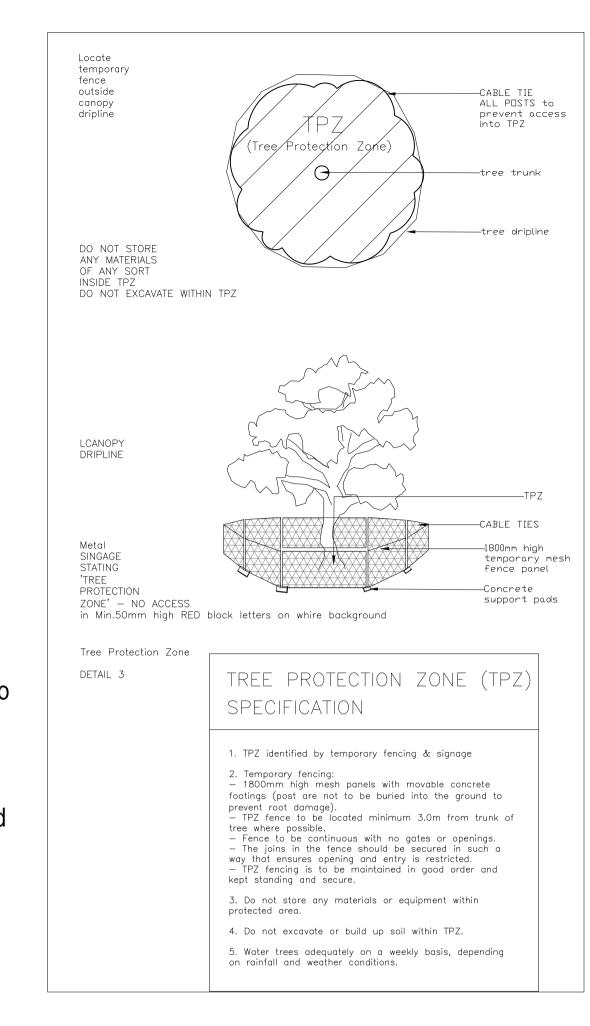

TREES STAKE DIAGRAM



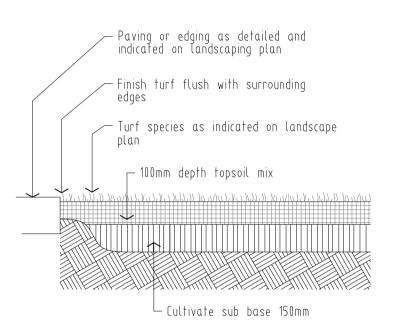

Ground preparation
Grassed area: turf using imported topsoil
Detail. Not.To.Scale.

-50 x 50mm HWD STAKES

75mm MULTCH AS SPECIFIED

BACKFILL WITH TOPSOIL

FERTILIZER IN SIDE

MIXTURE


OF HOLE

25L-100L

DECREASE AT BASE OF TRUNK

HESSIAN WEBBING TIED

IN FIGURE 8 PATTERN

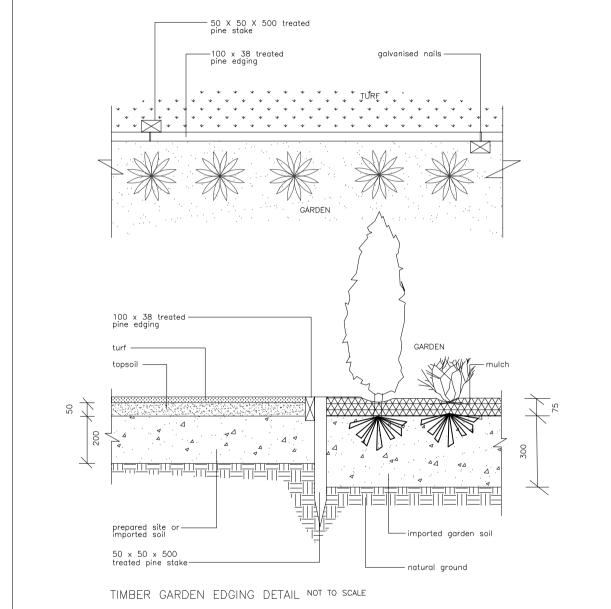

	PLANT SCHEDULE					
	TREES, SHRUBS & GROU		Pot Size mm/ltr	Mature Size W x H mtrs		
ID	Botanical Name	Common Name	Qty		VV X II III III	
AGD	Abelia grandiflora dwarf	Glossy abelia	5	200mm	1.2x1.2m	
AAM	Acmena smithii 'Allyn Magic'	Dwarf lilly pilly	26	200mm	1 x 1m	
ASS	Acmena smithii 'Sublime'	Small leaved lilly pilly	1	25ltr	2.5 x 5m	
BF	Buxus faulkner	Korean box	19	200mm	1.2x1.2m	
CGBF	Callistemon 'Great Balls of Fire'	Dwarf white bottlebrush	3	200mm	1.5x1.5m	
DCTV	Dianella caerula cultivar	Cultivar flax lillies	4	200mm	.7 x .7m	
EE	Eleocarpus eumundi	Eumundi quongdong	1	25ltr	4 x 9m	
ER	Eleocarpus reticulatus	Blue berry ash	1	25ltr	5 x 9m	
GT	Gazania tomentosa		12	200mm	G/cover	
MLG	Magnolia grandiflora 'little gem'	Dwarf bullbay	1	25ltr	3 x 6m	
MMM	Murraya Min a Min	Dwarf Mock orange	11	200mm	1 x 1m	
MP	Myoporum parvifolium	Creeping boobialla	2	200mm	G/cover	
RI	Raphiolepsis intermedia		4	200mm	1.5x1.5m	
RSM	Raphiolepsis snow maiden		13	200mm	1.2 x 1.2m	
RS	Raphiolepsis 'Springtime'		4	200mm	1.2 x 1.2m	
TLL	Tristaniopsis laurina 'Luscious'	Water gum	1	25ltr	5 x 9m	
TVV	Tulbaghia violacea variegata	Ornamental Variegated society garlic	12	200mm	.3x.3m	
WF	Waterhousea floribunda	Weeping lilly pilly	1	25ltr	8 x 8m	

ALL HEIGHTS ARE AVERAGE DEPENDENT ON SOIL, CLIMATE, MAINTENANCE, ETC.



DATE BY AMENDMENT

DRAWING TO BE READ IN CONJUNCTION WITH TI

ARCHITECTS-- STORMWATER-- ENGINEERS PLANS

PLUS ASSOCIATED SHEETS ATTACHED

00 X 25MM CCA TREATED

TO 50 X 50 X 450MM LONG

PINE BOARED CLASS H4, FIXED

00MM DEEP CONSOLIDATED RHYOLITE

00MM DEEP COMPACTED ROADBASE

JK's GARDEN CREATIONS


PO. BOX 168 GAN GAN RD ANNA BAY. NSW. 2316 John A. Kime **Mob. 0412582966**

email_gardenflora704@gmail.com
Member AILDM
Diploma in Horticulture L/scape Dsn, Cert. Ag


SITE ADDRESS

MULTI DWELLING
SP 31978
335 LAMBTON ROAD
NEW LAMBTON

FOURJAY PTY LTD

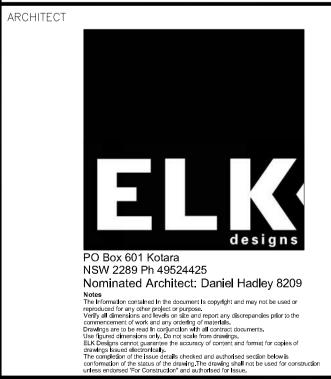

DRAWN Mishka	DATE 22/06/2021
SCALES	CHECKED JK
3 OF 3 Specification Plan	JOB No. FOUR300421

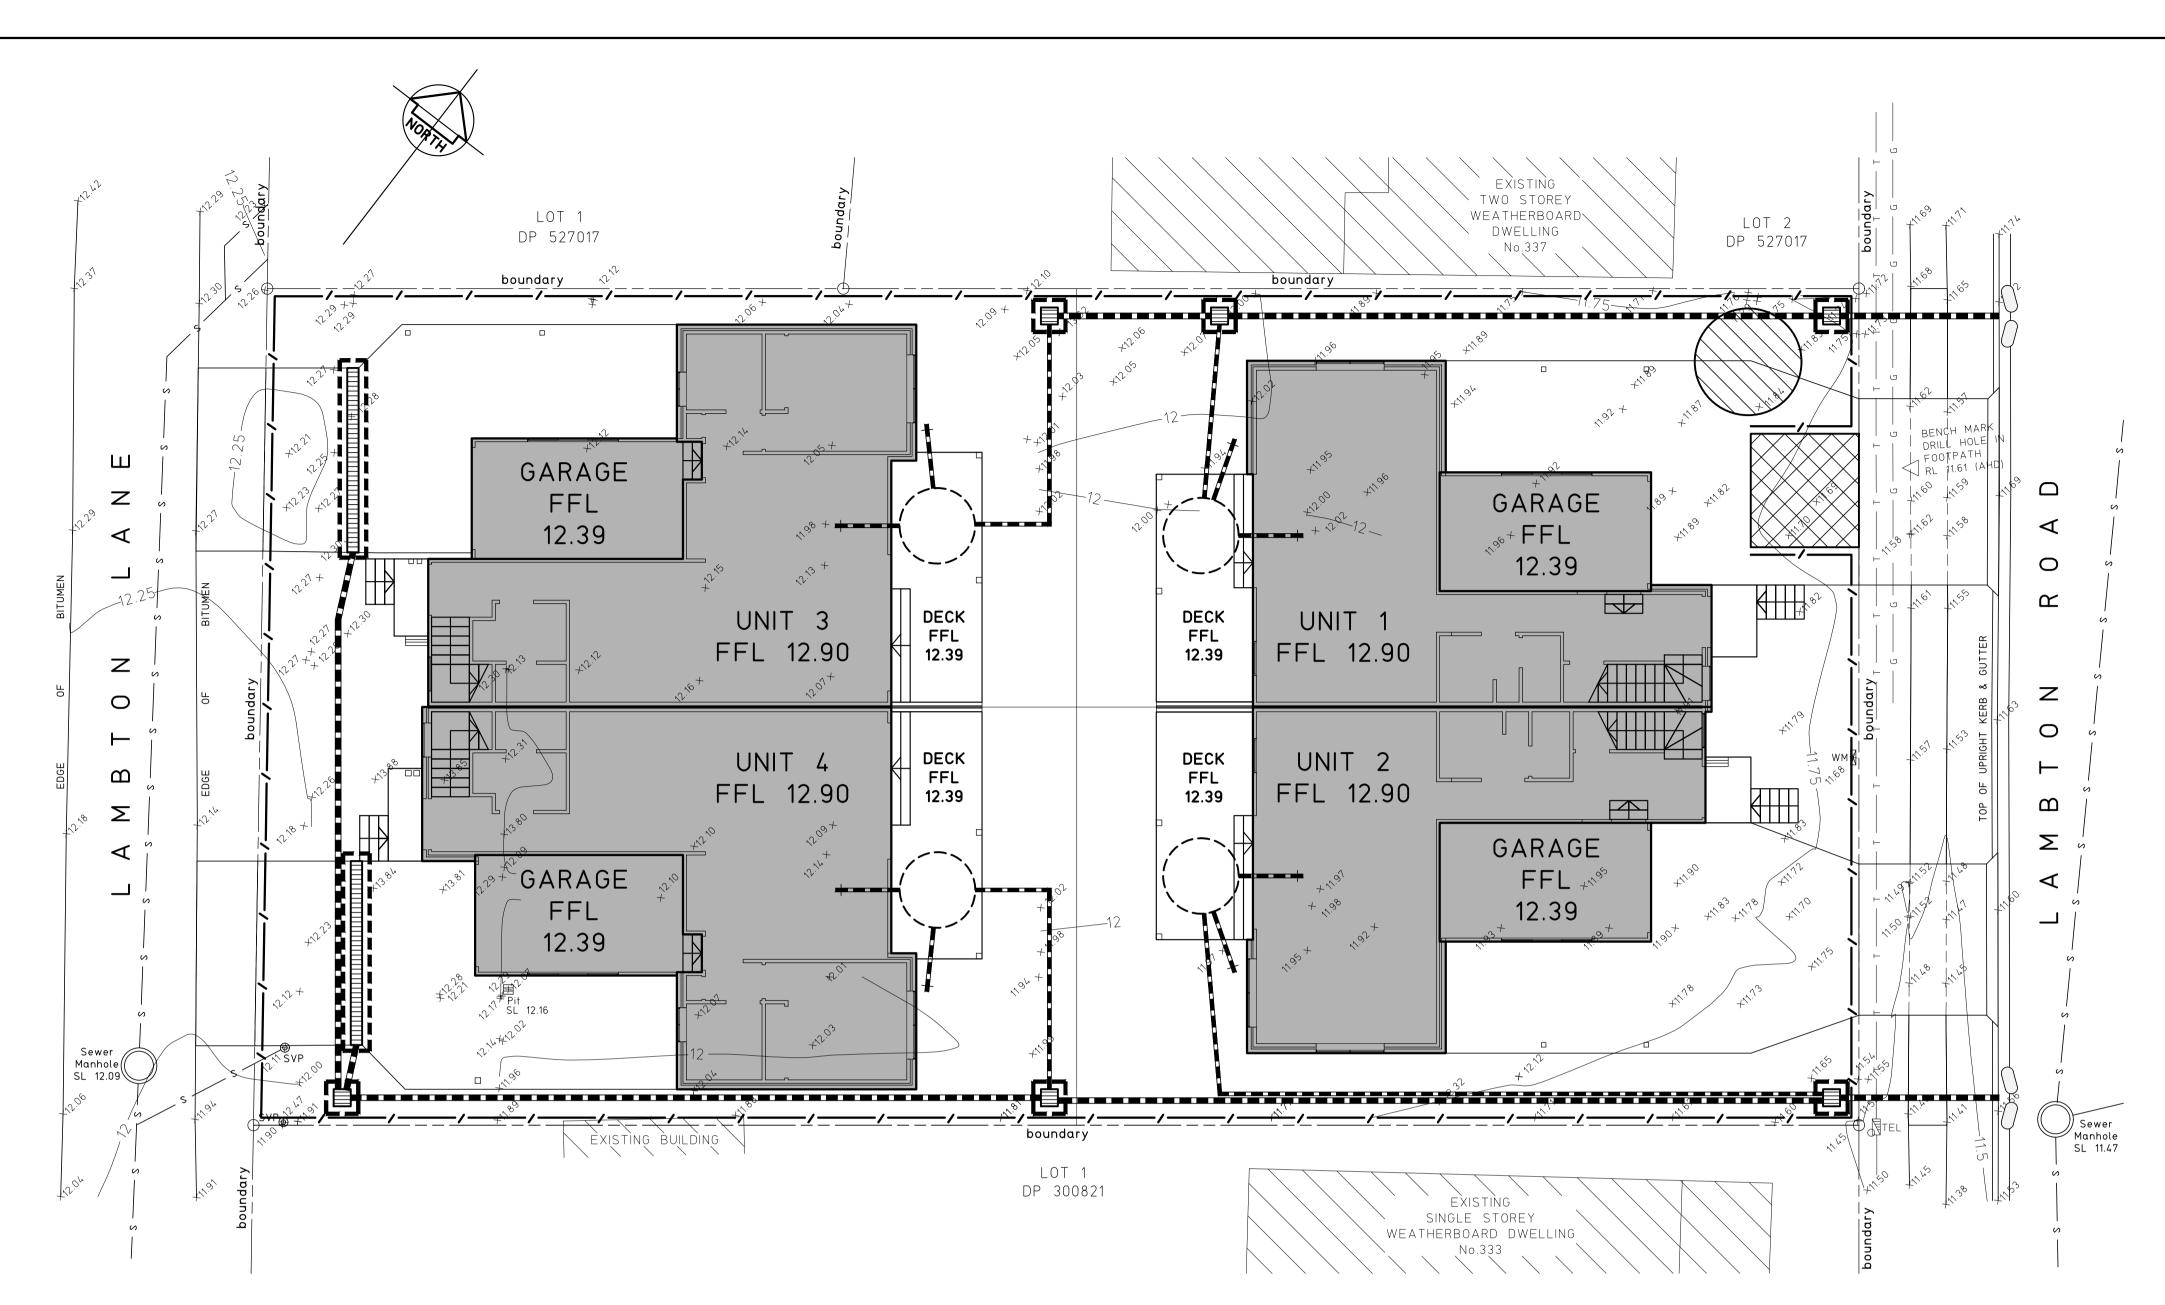

SEDIMENTATION AND EROSION CONTROL PLAN

SCALE 1:100

SEDIMENTATION AND EROSION CONTROL NOTES

1. SELECTIVE CLEARING OF VEGETATION TO BE RESTRICTED TO NOMINATED AREAS WITH CLEARED VEGETATION WIND ROWED ON THE CONTOUR.

2. ALL EROSION AND SEDIMENT CONTROL MEASURES TO BE INSTALLED PRIOR TO SITE DISTURBANCE.

3. TOPSOIL FROM ALL AREAS THAT WILL BE DISTURBED TO BE STRIPPED AND STOCKPILED AT THE NOMINATED SITE. 4. NO MORE THAN 150m OF TRENCH TO BE OPEN AT ANY ONE TIME.

5. CUT AND FILL BATTER GRADIENTS OF 1:2 (MAXIMUM).

6. A STRIP OF TURF 450mm WIDE IS TO BE PLACED IMMEDIATELY BEHIND THE KERB ON ALL NEW ROAD TO ACT AS A FILTER TRAP. REFER TO DETAIL SD6-13.

7. ALL SEDIMENT CONTROL STRUCTURES TO BE INSPECTED BY SITE SUPERVISOR AFTER EACH RAINFALL EVENT FOR STRUCTURAL DAMAGE AND ALL TRAPPED SEDIMENT TO BE REMOVED TO A NOMINATED STOCKPILE SITE.

8. THE PROJECT MANAGER TO INFORM ALL CONTRACTORS AND SUB-CONTRACTORS OF THEIR OBLIGATIONS UNDER THE

EROSION AND SEDIMENT CONTROL PLAN. 9. NO DISTURBED AREA IS TO REMAIN DENUDED LONGER THAN 14 DAYS.

10. ALL FILLS ARE TO BE LEFT WITH A LIP AT THE TOP OF THE SLOPE AT THE END OF EACH DAY'S OPERATION.

11. THE CONTRACTOR MUST ENSURE THE SUITABILITY AND INTEGRITY OF ALL WORKS AT THE END OF EACH DAY'S WORK. 12. ORANGE BARRIER TAPE TO BE AFFIXED TO TOP OF SEDIMENT CONTROL BARRIER TO IDENTIFY WORK AREA.

13. ALL SEDIMENTATION & EROSION CONTROL MEASURES ARE TO STRICTLY COMPLY WITH THE GUIDELINES DETAILED IN THE DEPARTMENT OF HOUSING PUBLICATION, "MANAGING URBAN STORMWATER - SOILS AND CONSTRUCTION", 4TH EDITION.

14 WATER TRUCKS TO BE USED AS REQUIRED TO PREVENT WIND EROSION. 15. SUBGRADE MATERIAL TO BE CONSTRUCTED IMMEDIATELY FOLLOWING FILL. **LEGEND**



DENOTES ALLOWABLE AREA FOR TEMPORARY STOCKPILING OF CUT SOIL MATERIAL,



DENOTES SEDIMENT FENCE,

REFER TO DETAIL SD4-1



REFER TO DETAIL SD6-8




DENOTES MESH AND GRAVEL INLET FILTER,



REFER TO DETAIL SD6-11



DENOTES GEOTEXTILE INLET FILTER, REFER TO DETAIL SD6-12

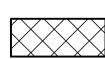

DENOTES STABILISED SITE ACCESS, REFER TO DETAIL SD6-14

NOT FOR CONSTRUCTION

		© Copyright MPC Consulting Engineers as date of issue			
			USED FOI	THIS DRAWING IS NOT TO BE R CONSTRUCTION UNLESS ENDORSED	BELOW
1	REVISED DEVELOPMENT APPLICATION	15.7.21			
0	DEVELOPMENT APPLICATION	18.6.21			
ISSUE	REASON FOR ISSUE	DATE	DATE OF RELEASE	RESPONSIBLE PRINCIPAL SIGNATURE	ISSUE

COPYRIGHT The concepts and information contained this document are the copyright of MPC Consulting Engineers Use or copying of the document in whole or in part without the written permission f MPC Consulting Engineers constitutes in infringement of copyright.



Level 1,
16 Telford Street,
NEWCASTLE EAST, NSW 2300
PO BOX 553
THE JUNCTION, NSW 2291
Tel: (02) 4927 5566
Fax: (02) 4927 5577
Email: admin@mpceng.com.au
Web: www.mpceng.com.au
A.C.N. 098 542 575


TITI C			
FOURJAY	PTY	LTD	
CLIENT			

ı	TITLE	SP 31978,
		No.335 LAMBTON ROAD,
ı	EROSION CONTROL PLAN	NEW LAMBTON

PROPOSED MULTI DWEL


LING AT;	DO NOT SCALE DRAWING					
	DRAWN L.C.	ENGINEER P.M.	No in SET	SHEET A1		
•	1:100	JOB No 210631	C01	ISSUE 1		


FULL SIZE ON ORIGINAL 0 1 2 3 4 5 6 7 8 9 10 11 12 13 14 15 cm

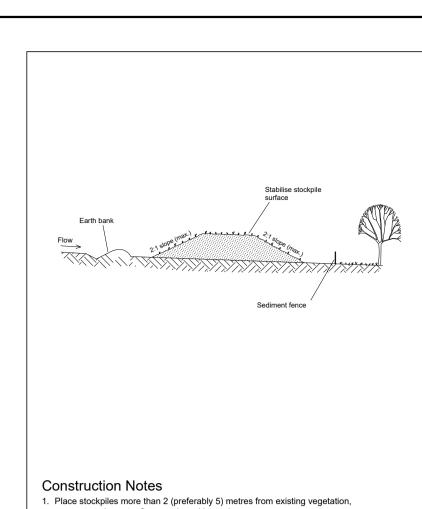



- concentrated water flow, roads and hazard areas.
- Construct on the contour as low, flat, elongated mounds 3. Where there is sufficient area, topsoil stockpiles shall be less than 2 metres in height. 4. Where they are to be in place for more than 10 days, stabilise following the approved
- ESCP or SWMP to reduce the C-factor to less than 0.10. . Construct earth banks (Standard Drawing 5-5) on the upslope side to divert water around stockpiles and sediment fences (Standard Drawing 6-8) 1 to 2 metres downslope.


STOCKPILES SD 4-1

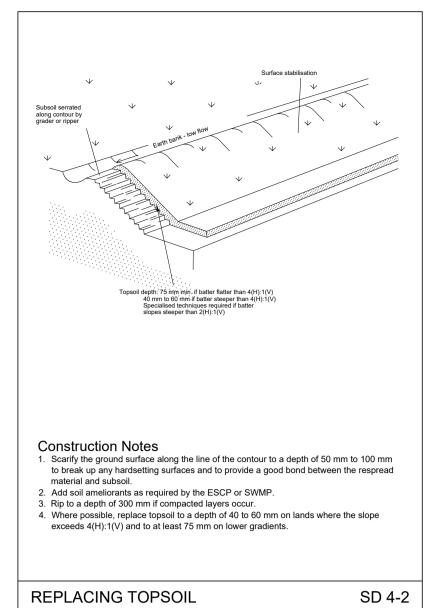


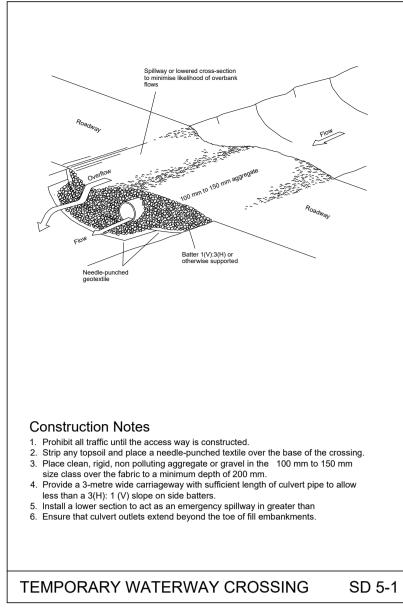


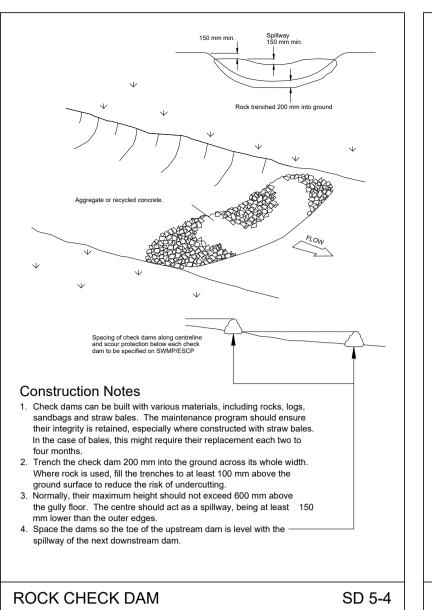

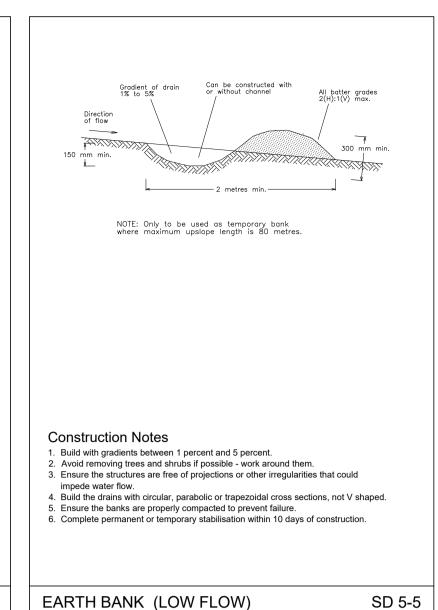

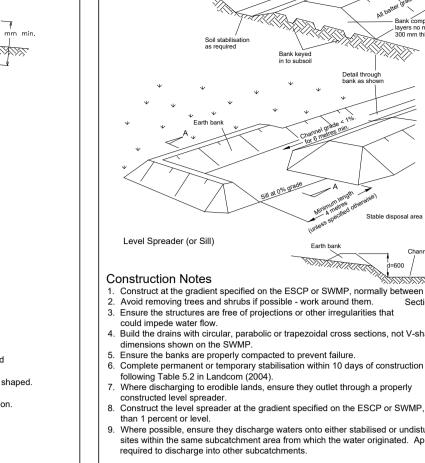

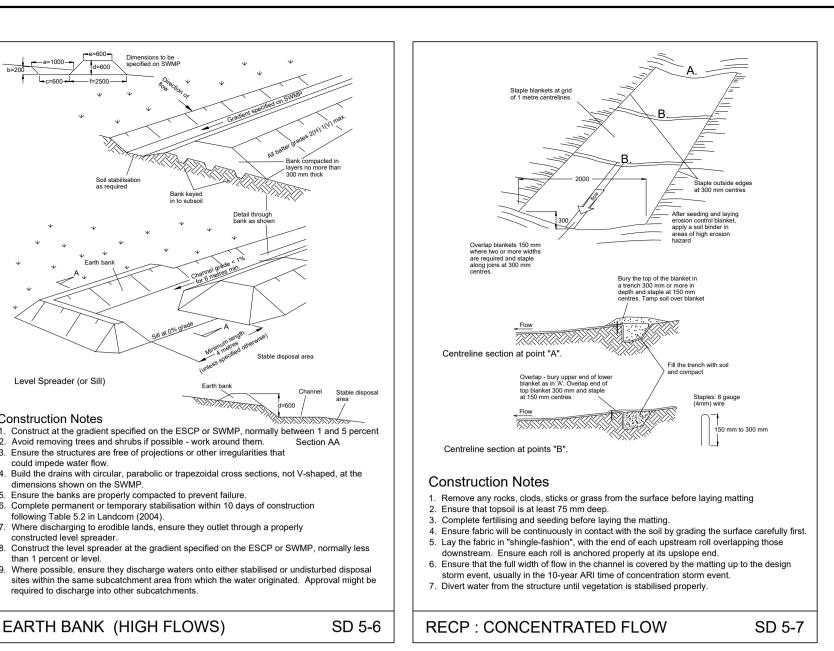

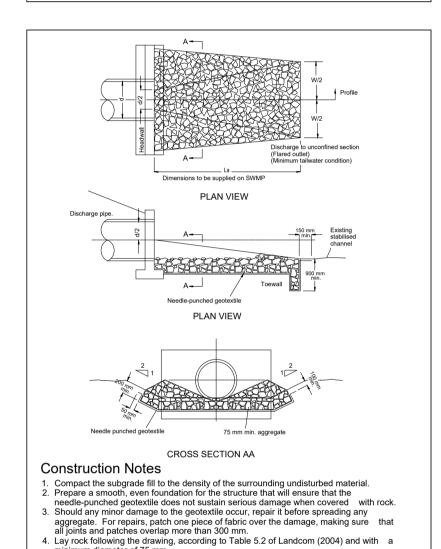


Ensure that any concrete or riprap used for the energy dissipater or the outlet protection conforms to the grading limits specified on the SWMP.

ENERGY DISSIPATER

DEVELOPMENT APPLICATION

REASON FOR ISSUE

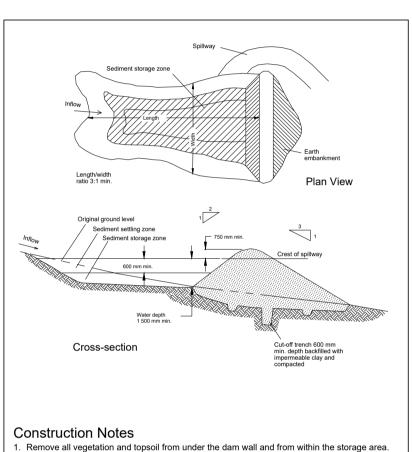

2. Construct a cut-off trench 500 mm deep and 1,200 mm wide along the centreline of the embankment extending to a point on the gully wall level with the riser crest.

3. Maintain the trench free of water and recompact the materials with equipment as specified

6. Spread the fill in 100 mm to 150 mm layers and compact it at optimum moisture content

4. Select fill following the SWMP that is free of roots, wood, rock, large stone or foreign material.

5. Prepare the site under the embankment by ripping to at least 100 mm to help bond compacted

SD 6-4

in the SWMP to 95 per cent Standard Proctor Density.

fill to the existing substrate.

Construct the emergency spillway.

EARTH BASIN - WET

(APPLIES TO 'TYPE D' AND 'TYPE F' SOILS ONLY)

8. Rehabilitate the structure following the SWMP.

following the SWMP.


18.6.21

DATE

DATE OF RELEASE


RESPONSIBLE PRINCIPAL SIGNATURE


SD 5-8

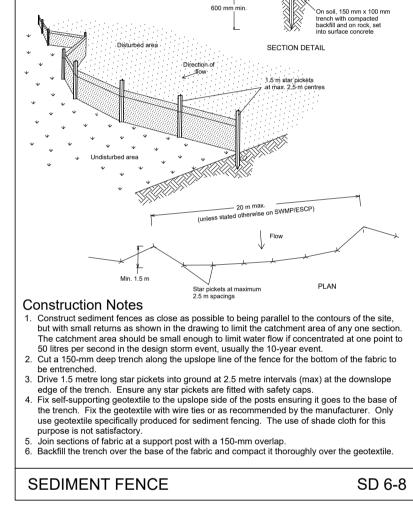

or in part without the written permission of MPC Consulting Engineers constitutes

an infringement of copyright.

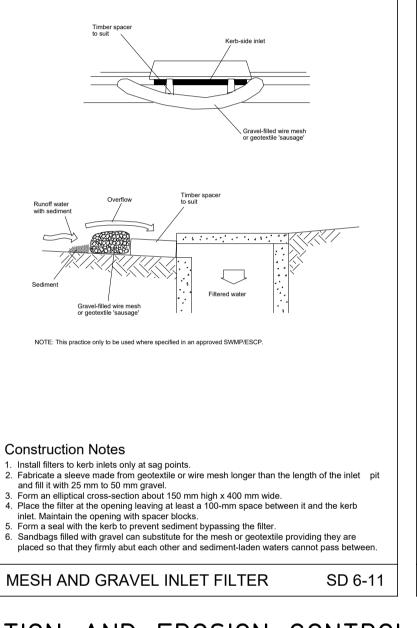

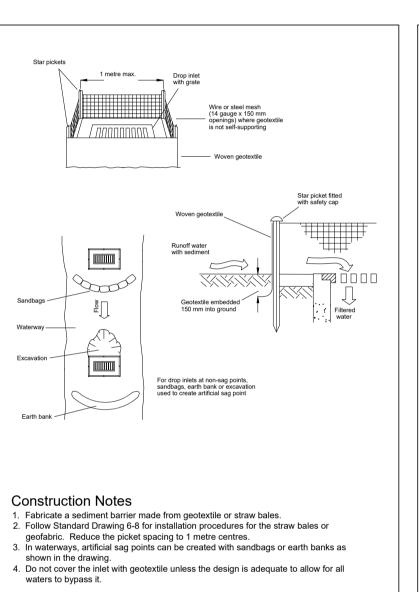

SD 6-12


No.335 LAMBTON ROAD,

NEW LAMBTON


GEOTEXTILE INLET FILTER

SEDIMENTATION AND

EROSION CONTROL DETAILS

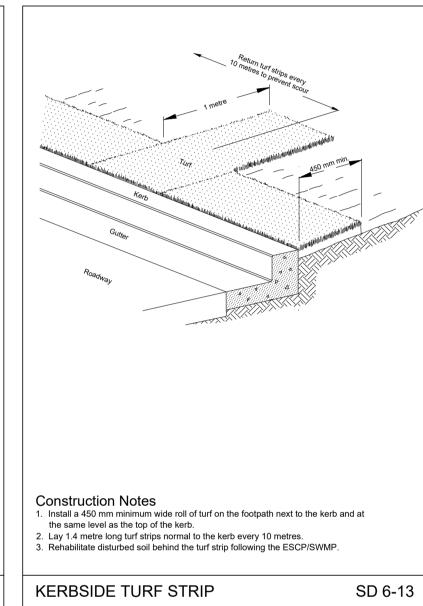

EARTH BANK (HIGH FLOWS)

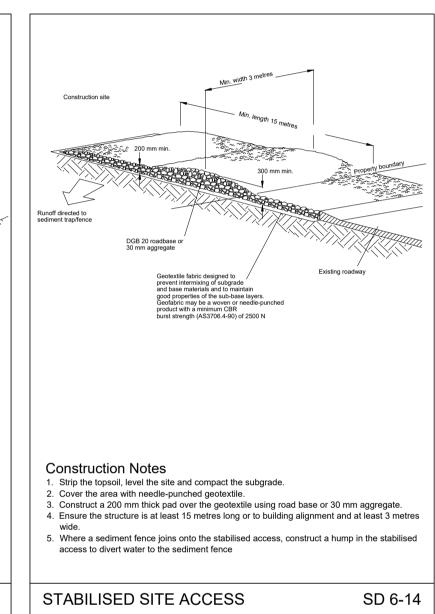

SEDIMENTATION AND EROSION CONTROL DETAILS

						N	OT FOF	CONS	STRUCT	TION
	© Copyright MPC Consulting Engineers as date of issue	COPYRIGHT		Level 1, 16 Telford Street,	CLIENT	PROJECT		DO NOT SC/	ALE DRAWING	,
		The concepts and information contained in this document are the copyright of MPC Consulting Engineers	NEWCASTLE EAST, NSW 2300	FOURJAY PTY LTD	PROPOSED MULTI DWELLING AT;	DRAWN				
		MPC Consulting Engineers Use or copying of the document in whole		THE JUNCTION, NSW 2291 Tel: (02) 4927 5566	TITLE	SP 31978,	L.C.	P.M.	3	A1

civil+structural

Fax: (02) 4927 5577


A.C.N. 098 542 575

Email: admin@mpceng.com.au

Web: www.mpceng.com.au

DO NOT SCALE DRAWING			
DRAWN	ENGINEER	No in SET	SHEET
L.C.	P.M.	3	A1
SCALES	JOB No	DRAWING No	ISSUE
N.T.S.	210631	C02	0

FULL SIZE ON ORIGINAL

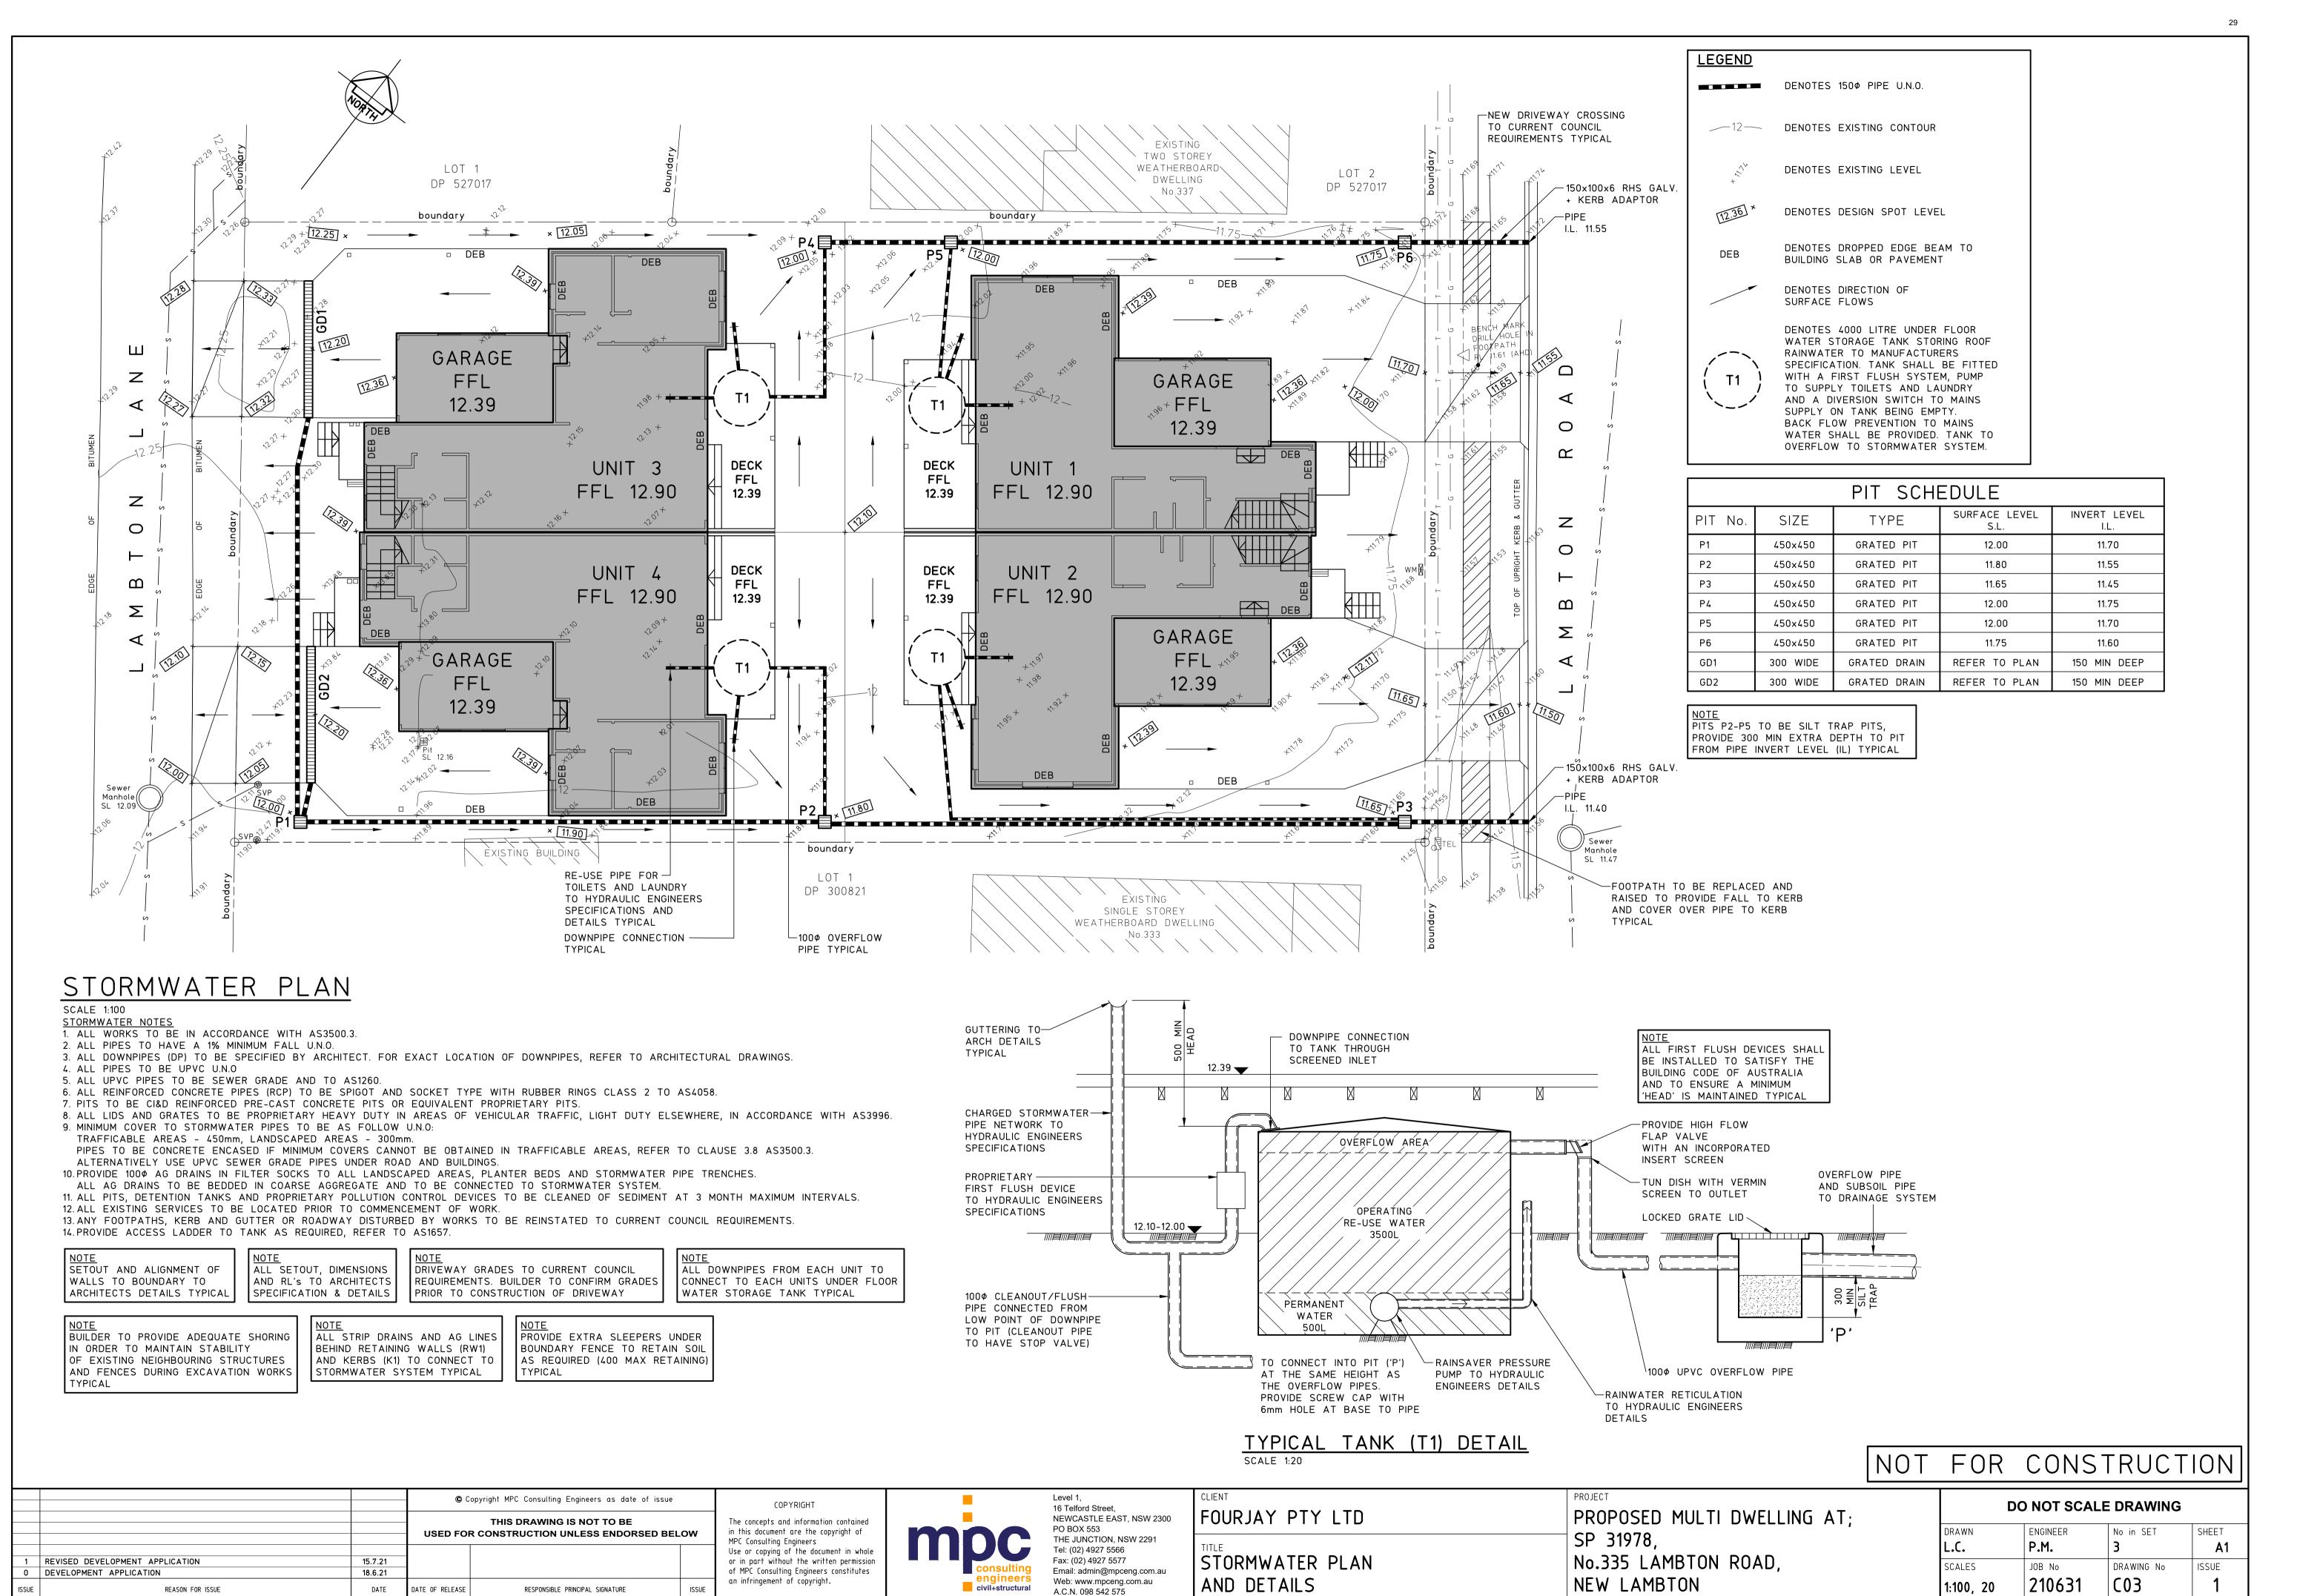

FULL SIZE ON ORIGINAL 0 1 2 3 4 5 6 7 8 9 10 11 12 13 14 15 cm