

ATTACHMENTS DISTRIBUTED UNDER SEPARATE COVER

ITEM-6 DAC 18/06/19 - DA2018/00851 - 2 PARNELL PLACE, NEWCASTLE EAST - ALTERATIONS AND ADDITIONS TO DWELLING

Attachment A Submitted Plans - 2 Parnell Place Newcastle East

ITEM-7 DAC 18/06/19 - DA2016/00982.01 - 70 AND 72 BLUE GUM ROAD, JESMOND - MODIFICATION TO MULTIPLE DWELLING HOUSING (42 DWELLINGS)

Attachment A Submitted Plans - 70 & 72 Blue Gum Road Jesmond

ITEM-8 DAC 18/06/19 - DA2018/00968 - 37 ALFRED STREET, NEWCASTLE EAST - ALTERATIONS AND ADDITIONS TO DWELLING

Attachment A Submitted Plans - 37 Alfred Street Newcastle East

DEVELOPMENT APPLICATIONS COMMITTEE MEETING

18 June 2019

ATTACHMENTS DISTRIBUTED UNDER SEPARATE COVER

REPORTS BY COUNCIL OFFICERS

Attachment A - Plans DA2018/00851- 2 Parnell Place Newcastle East

Alterations and additions to dwelling

DISTRIBUTED UNDER SEPARATE COVER

17008

Alterations and 2 Parnell Place, Newcastle East 2300 Additions Lot 5 / DP 13965 | Development Application

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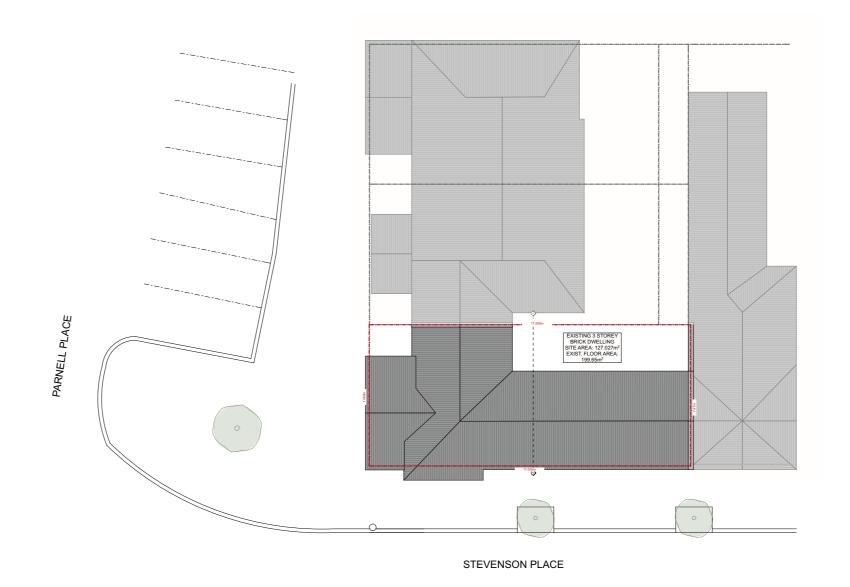












1:200 01 **EXISTING SITE PLAN**

9 Honeyeater Place, Tingira Heights, 2290, NSW, Australia www.manakin.com.au | ABN 48 298 811 589 contactus@manakin.com.au | 02 4023 2674

Do not scale drawing. Do not use drawing for construction purposes unless issued by MANAKIN for construction.

Project Number: 17008

Aterations and Additions at 2 Parnell Place, Newcastle East 2300 Lot 5 / DP13965

Proprietor:

Peter and Gail Cornish

Drawing:

Existing Site Plan Title:

1:200 @ A3 Scale:


Development Application Status: Drawn Date: Monday, 7 May 2018

Plot Date: Wednesday, 13 March 2019

Bar Scale:

1:200

Drawing No: DA01 Drawn By: JP

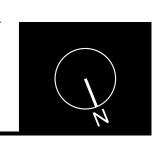

BE RETAINED OVERHEAD ELECTRICTY

EXISTING TREES TO

Legend:

BOUNDARY

SEWER MAIN


FENCE LINE

WATER MAIN


1. SITE LEVELS ARE APPROXIMATE ONLY.
PLEASE EVALUATE ON SITE BEFORE ANY
WORK OR ORDERING BEGINS.
2. THIS DRAWING TO BE READ IN
CONJUCTION WITH SPECIFICATIONS AND
ENGINEERS DRAWINGS.
3. ALL DIMENSIONS AND LEVELS TO BE
CHECKED AND VERIFIED BY BUILDER.
4. ALL WORKMANSHIP AND MATERIALS TO BE
IN ACCORDANCE WITH RELEVANT AUSTRALIAN
STANDARDS CODE AND LOCAL AUTHORITIES.
6. ALL DIMENSIONS ARE IN MILLIMETERS
UNLESS NOTED OTHERWISE.
7. ALL MATERIALS TO BE INSTALLED IN
ACCORDANCE WITH MANUFACTURERS
SPECIFICATIONS.
8. TIMBER TRUSS ROOF AND WALL FRAMING
TO MANUFACTURERS DESIGN AND
SPECIFICATION
NOTE FOR CONSTRUCTION

NOT FOR CONSTRUCTION

Revision: D 13.03.19

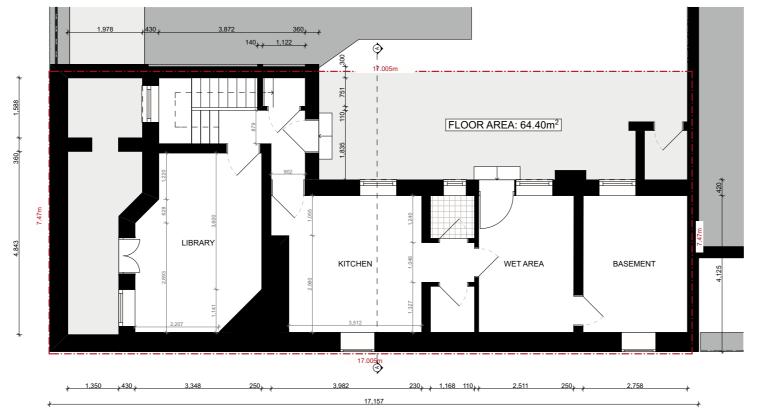

EXISTING BASEMENT PLAN 1:100

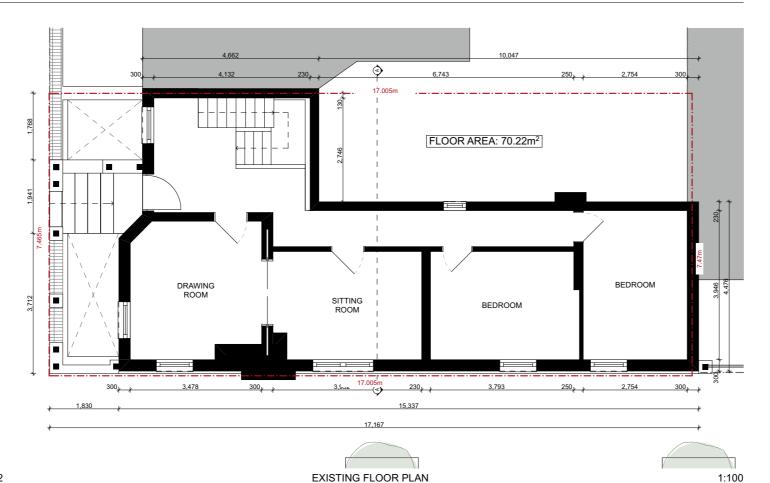

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SPECIFICATIONS.

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NOT FOR CONSTRUCTION

Revision: D 13.03.19

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Project Number: 17008

Aterations and Additions at

Proprietor:

2 Parnell Place, Newcastle East 2300 Lot 5 / DP13965

Peter and Gail Cornish

Drawing:


Existing Floor Plans Title:


Scale: 1:100 @ A3

Development Application Status: Drawn Date: Monday, 7 May 2018 Plot Date: Wednesday, 13 March 2019


Drawing No: DA02 Drawn By: JP

Bar Scale:

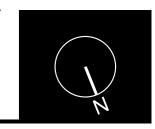

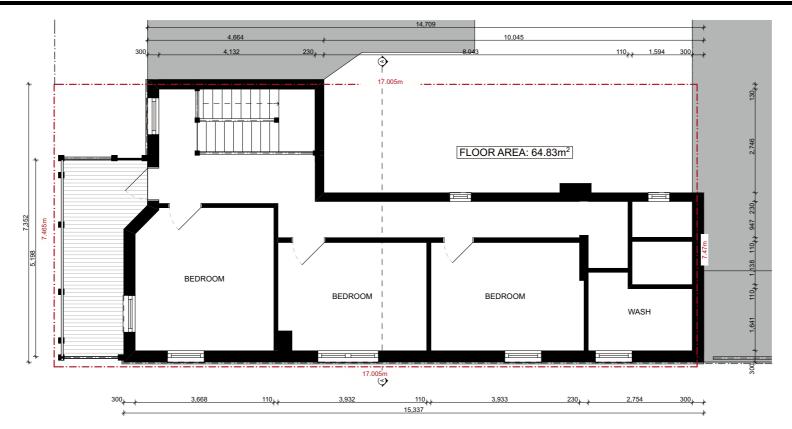

EXISTING FIRST FLOOR PLAN 1:100

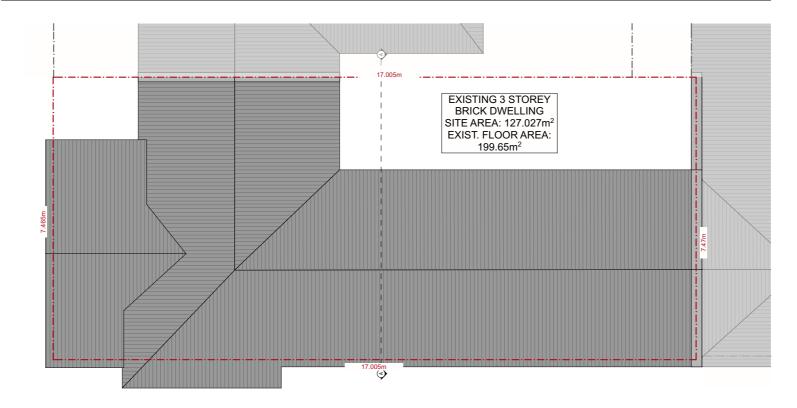

EXISTING ROOF PLAN

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Project Number: 17008

Aterations and Additions at 2 Parnell Place, Newcastle East 2300 Lot 5 / DP13965

Proprietor:

Peter and Gail Cornish


Drawing:

Existing First Floor and Roof Plans Title:


1:100 @ A3 Scale:

Development Application Status: Drawn Date: Monday, 7 May 2018

Plot Date: Wednesday, 13 March 2019

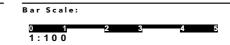


Drawing No: DA03 Drawn By: JP

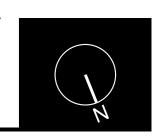





EXISTING EASTERN ELEVATION EXISTING NORTHERN ELEVATION 1:100 1:100

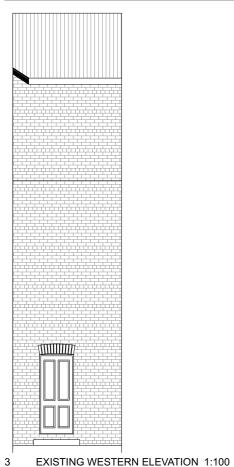



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Project Number: 17008

Aterations and Additions at 2 Parnell Place, Newcastle East 2300 Lot 5 / DP13965

Proprietor: Peter and Gail Cornish

Drawing:

Existing Elevations Title:


1:100 @ A3 Scale:

Development Application Status: Drawn Date: Monday, 7 May 2018 Plot Date: Wednesday, 13 March 2019 Drawing No: DA04

Bar Scale:

Drawn By: JP



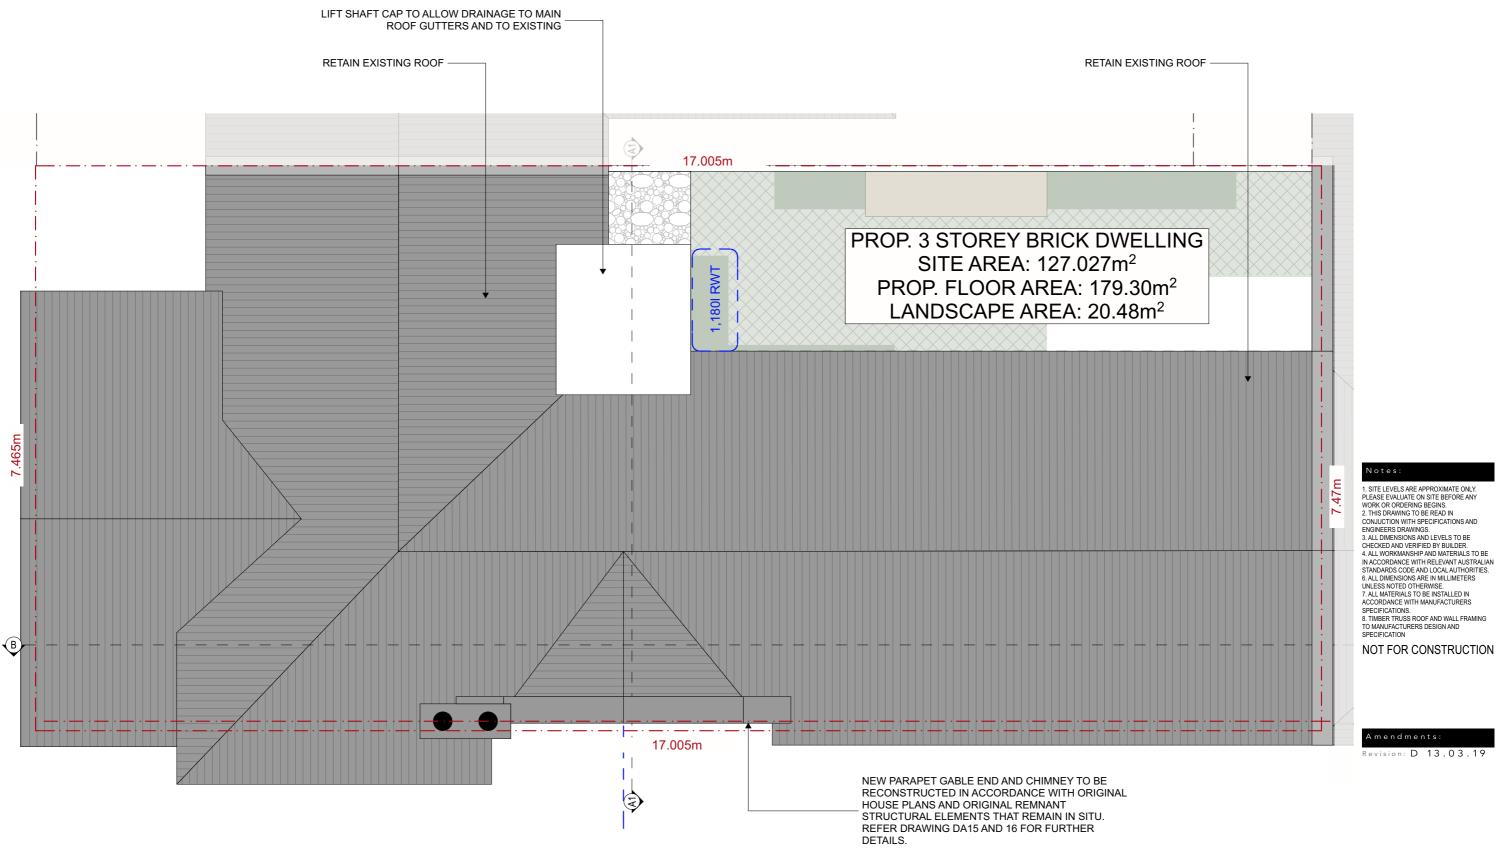



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Project Number: 17008

Aterations and Additions at 2 Parnell Place, Newcastle East 2300

Lot 5 / DP13965

Proprietor:Peter and Gail Cornish

Drawing:

Title: Proposed Site/Roof Plan

Scale: 1:50 @ A3


Status: Development Application

Drawn Date: Monday, 7 May 2018 Plot Date: Wednesday, 13 March 2019 Bar Scale:

1:100

Drawing No: DA05 Drawn By: JP



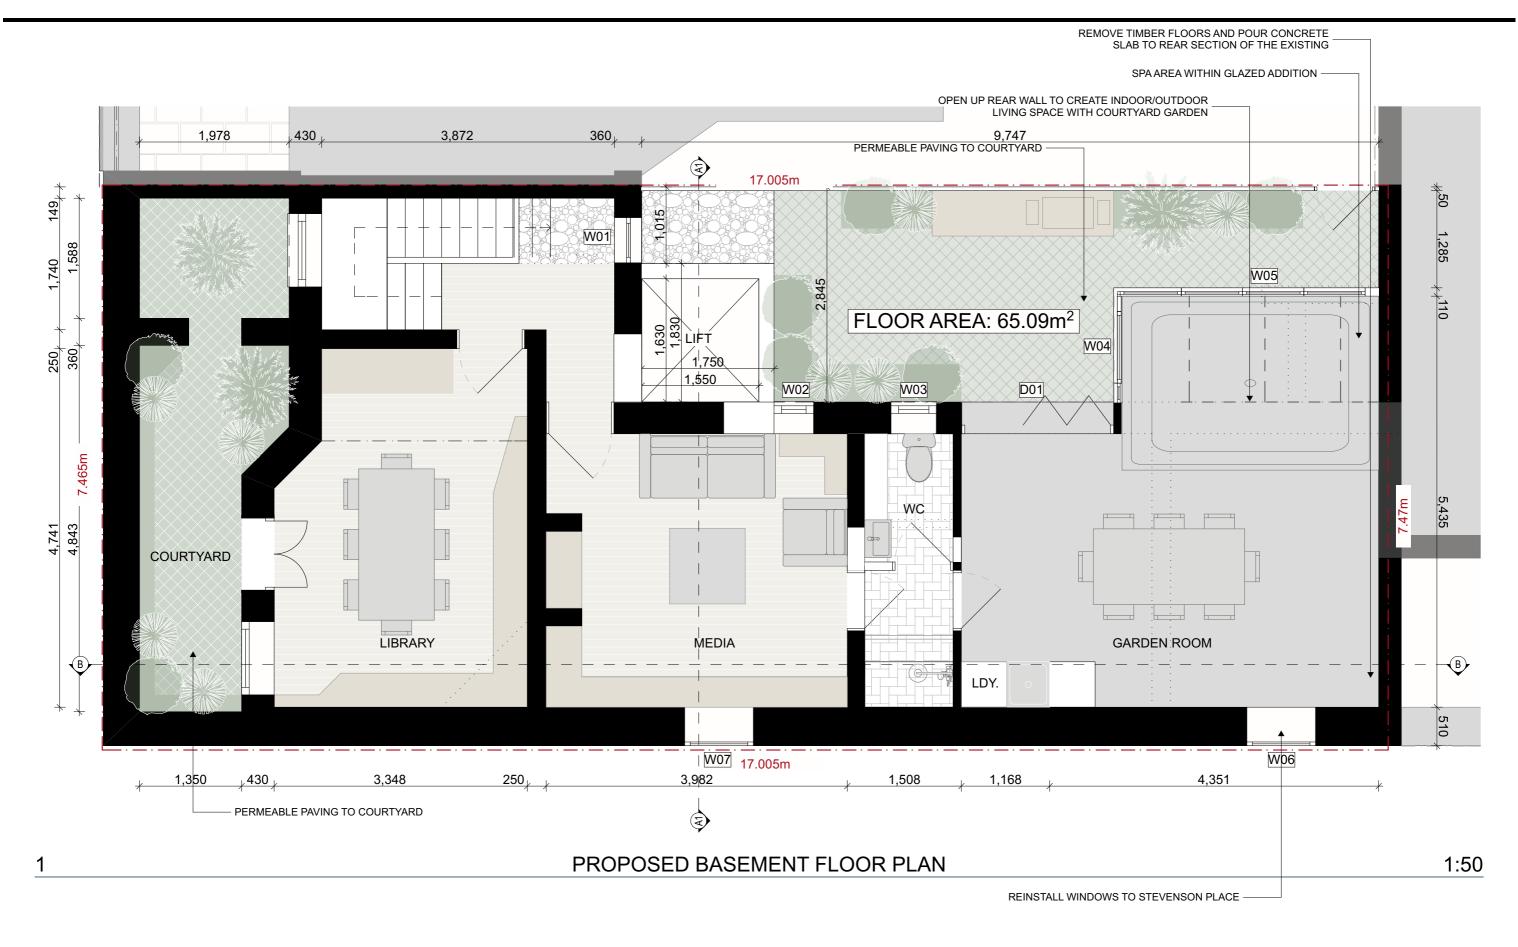



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Project Number: 17008

Aterations and Additions at 2 Parnell Place, Newcastle East 2300 Lot 5 / DP13965

Proprietor:Peter and Gail Cornish

Drawing:

Title: Proposed Basement Floor Plan

Scale: 1:50 @ A3


Status: Development Application
Drawn Date: Monday, 7 May 2018

Drawn Date: Monday, 7 May 2018
Plot Date: Wednesday, 13 March 2019



Drawing No: DA06
Drawn By: JP



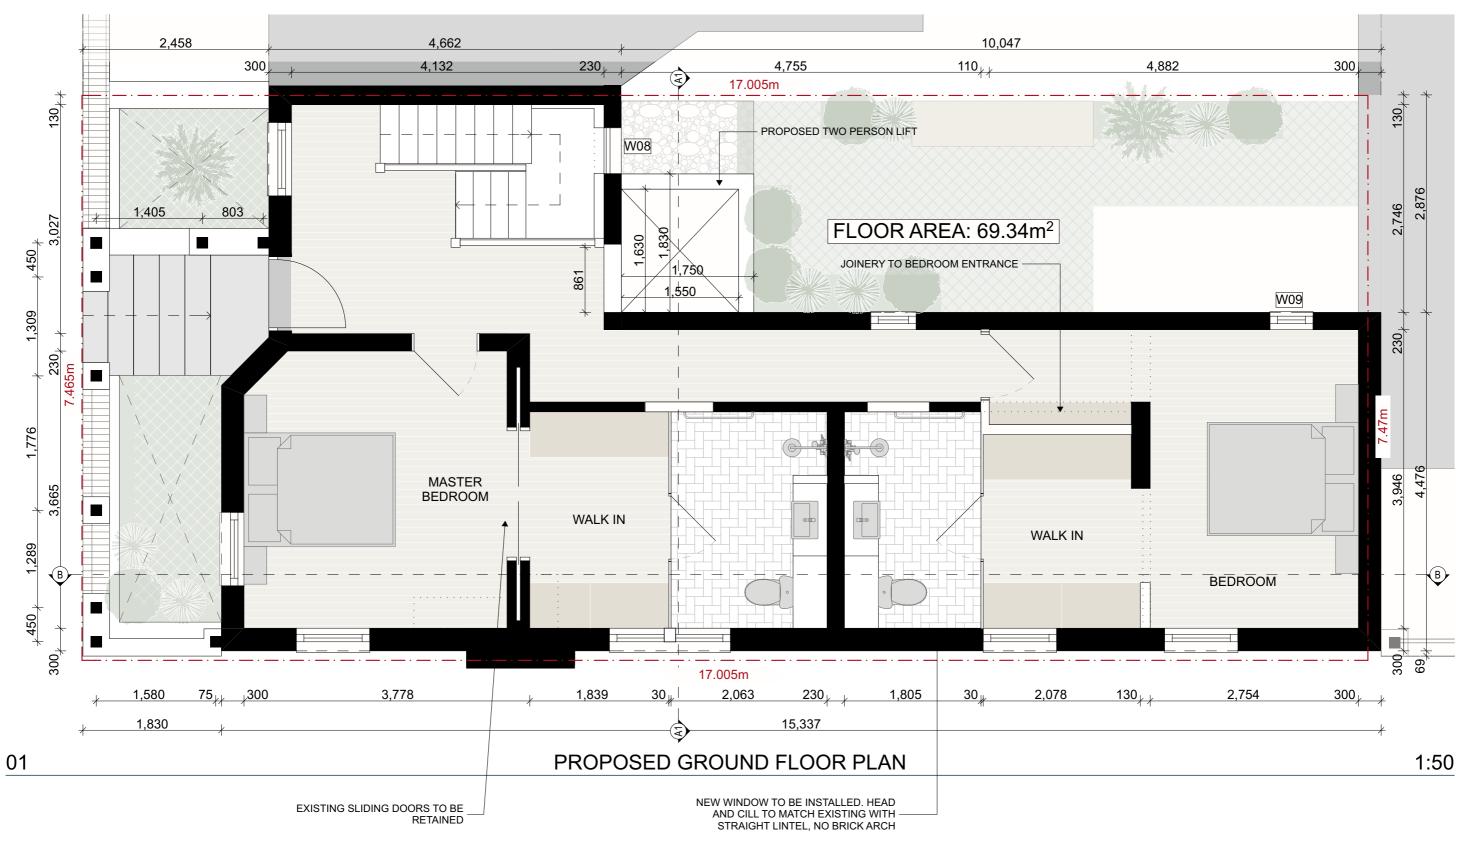



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Project Number: 17008

Aterations and Additions at 2 Parnell Place, Newcastle East 2300 Lot 5 / DP13965

Proprietor:

Peter and Gail Cornish

Drawing:

Proposed Ground Floor Plan Title:

1:50 @ A3 Scale:


Development Application Status: Drawn Date: Monday, 7 May 2018

Plot Date: Wednesday, 13 March 2019

Drawing No: DA07 Drawn By: JP

Bar Scale:



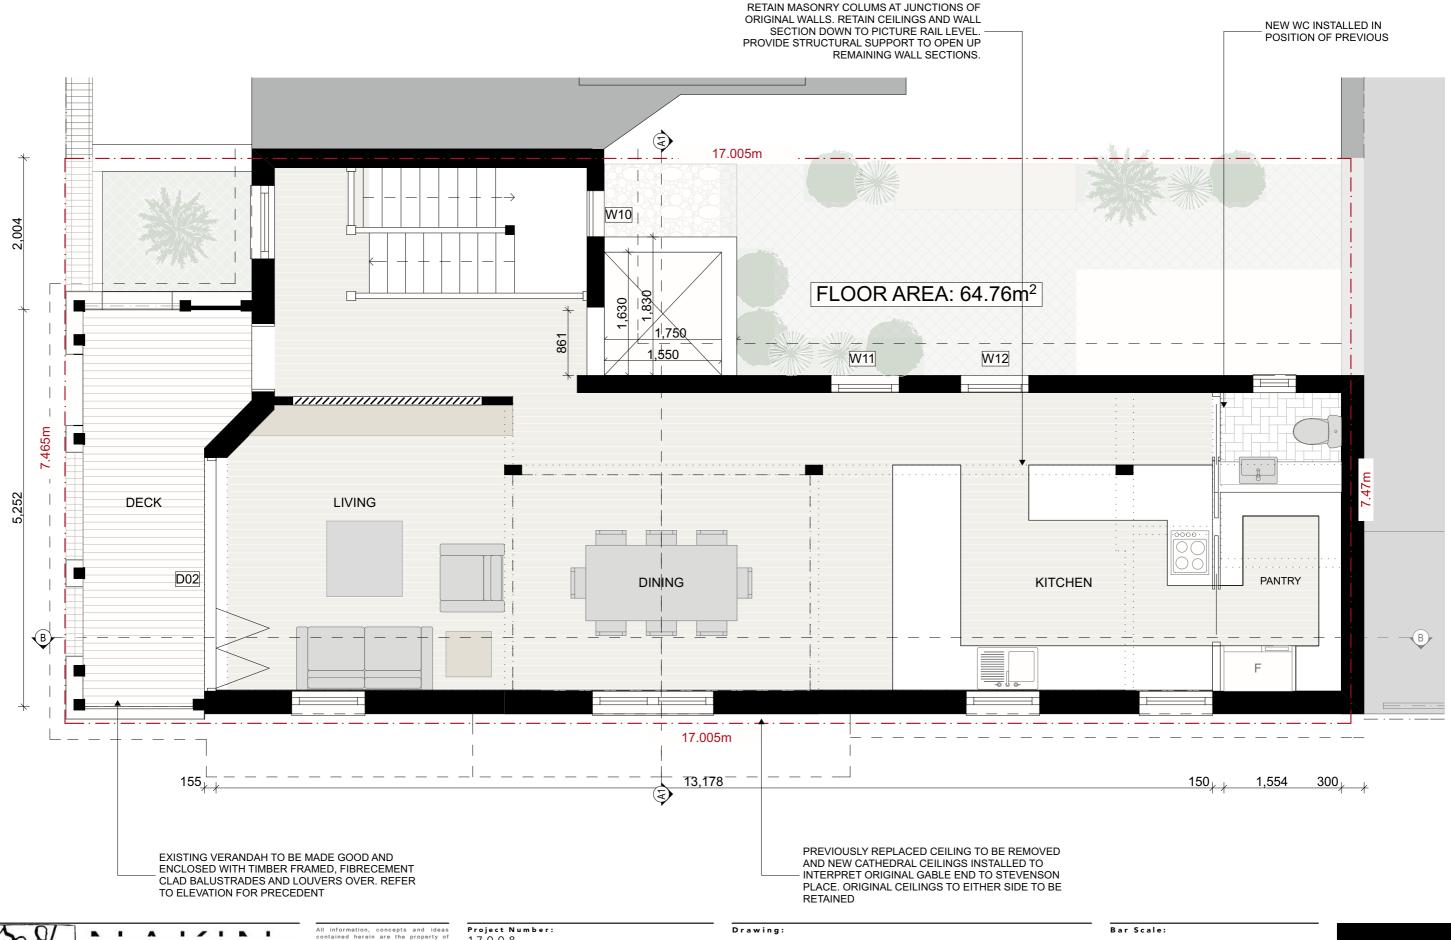



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17008

Aterations and Additions at 2 Parnell Place, Newcastle East 2300 Lot 5 / DP13965


Proprietor: Peter and Gail Cornish


Title: Proposed First Floor Plan

1:50 @ A3 Scale:

Development Application Status: Drawn Date: Monday, 7 May 2018 Plot Date: Wednesday, 13 March 2019

Drawing No: DA08 Drawn By: JP

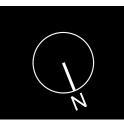

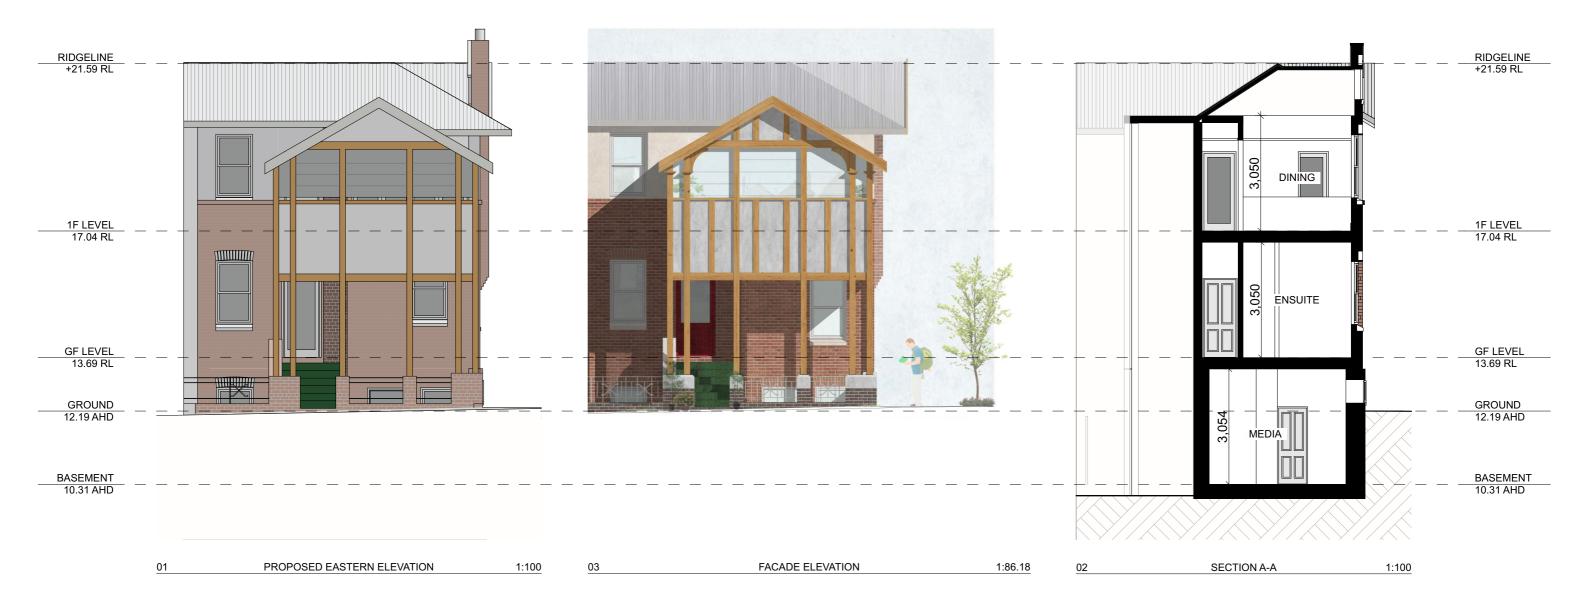



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Project Number: 17008

Project Name:

Aterations and Additions at 2 Parnell Place, Newcastle East 2300 Lot 5 / DP13965

Proprietor:

Peter and Gail Cornish

Drawing:

Title: Proposed Elevation and Section

Scale: 1:100 @ A3

Status: Development Application
Drawn Date: Monday, 7 May 2018
Plot Date: Wednesday, 13 March 2019

Drawing No: DA09 Drawn By: JP

Bar Scale:





3D PERSPECTIVE VIEWS - STREET CORNER

3D PERSPECTIVE VIEWS - RECONSTRUCTED PARAPET GABLE

3D PERSPECTIVE VIEW - REAR COURTYARD



PRECEDENT IMAGES

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Revision: D 13.03.19

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Project Number: 17008

Aterations and Additions at 2 Parnell Place, Newcastle East 2300

Lot 5 / DP13965

Proprietor: Peter and Gail Cornish

Drawing:

Proposed Elevations Title:


1:100 @ A3 Scale:

Development Application Status:

Drawn Date: Monday, 7 May 2018 Plot Date: Wednesday, 13 March 2019



Drawing No: DA 10 Drawn By: JP

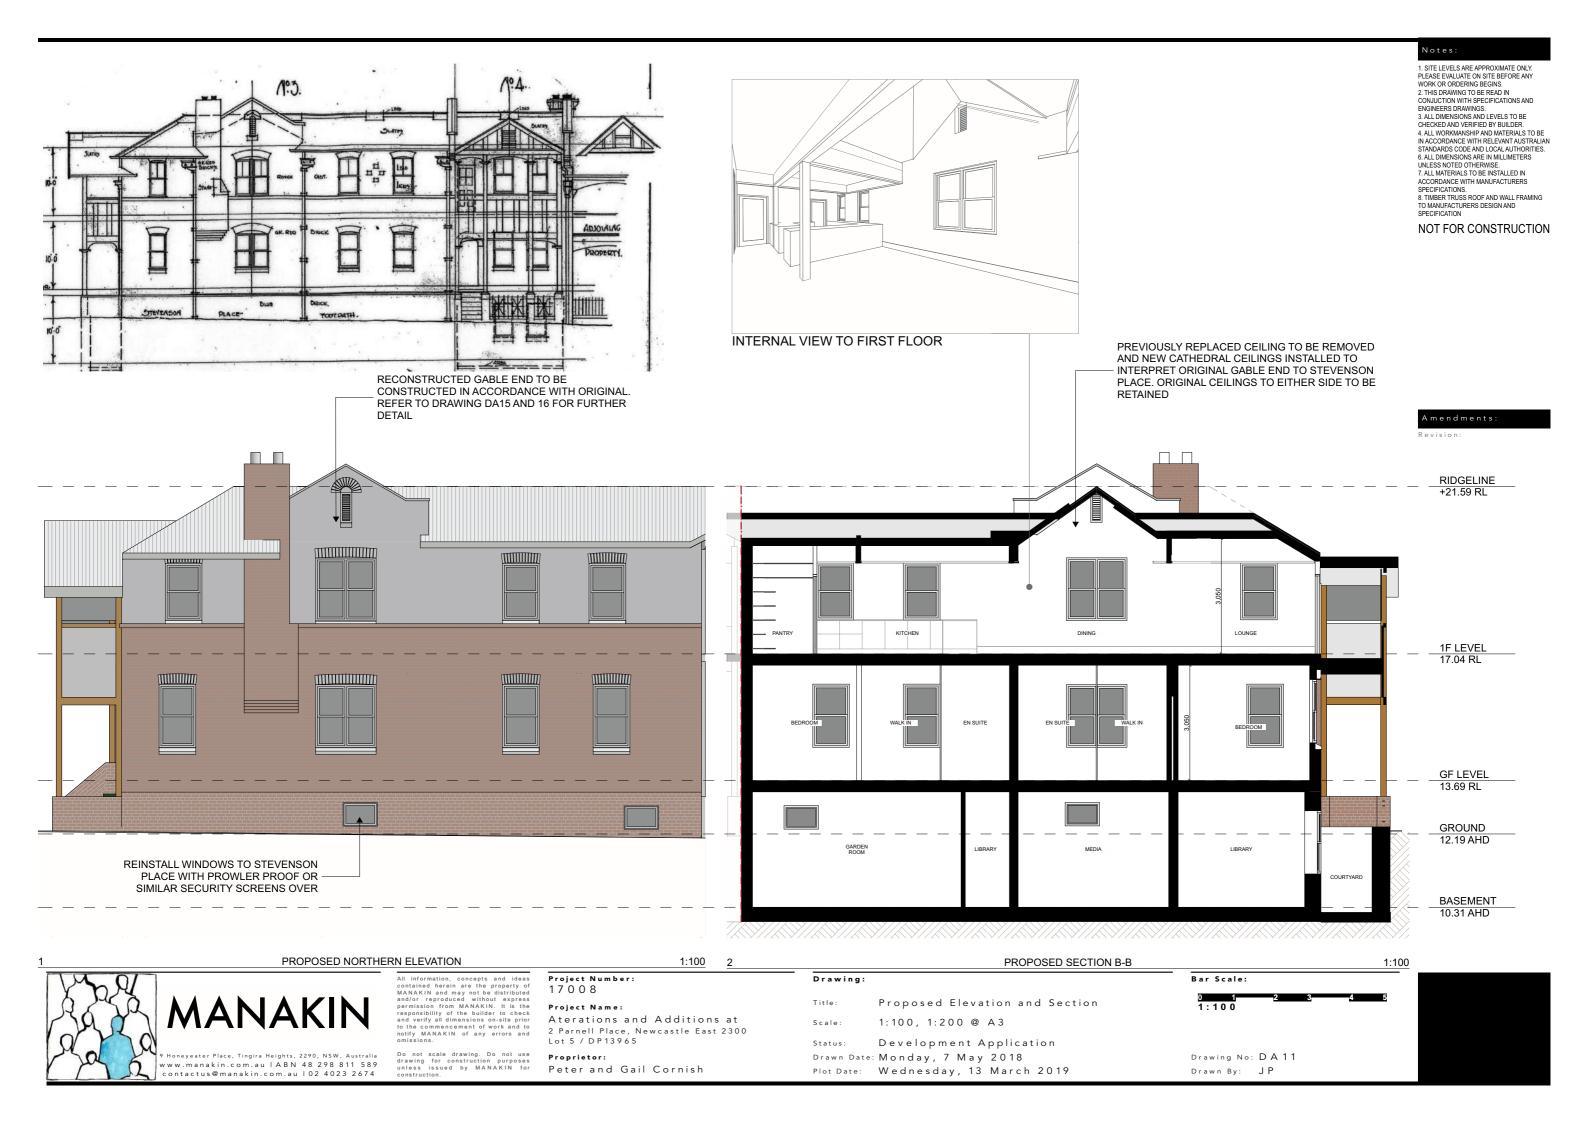








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Project Number: 17008

Project Name:

Aterations and Additions at 2 Parnell Place, Newcastle East 2300 Lot 5 / DP13965

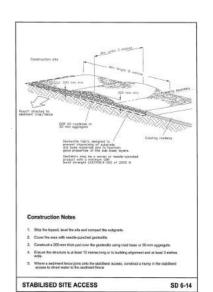Proprietor:

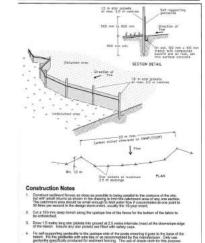Peter and Gail Cornish

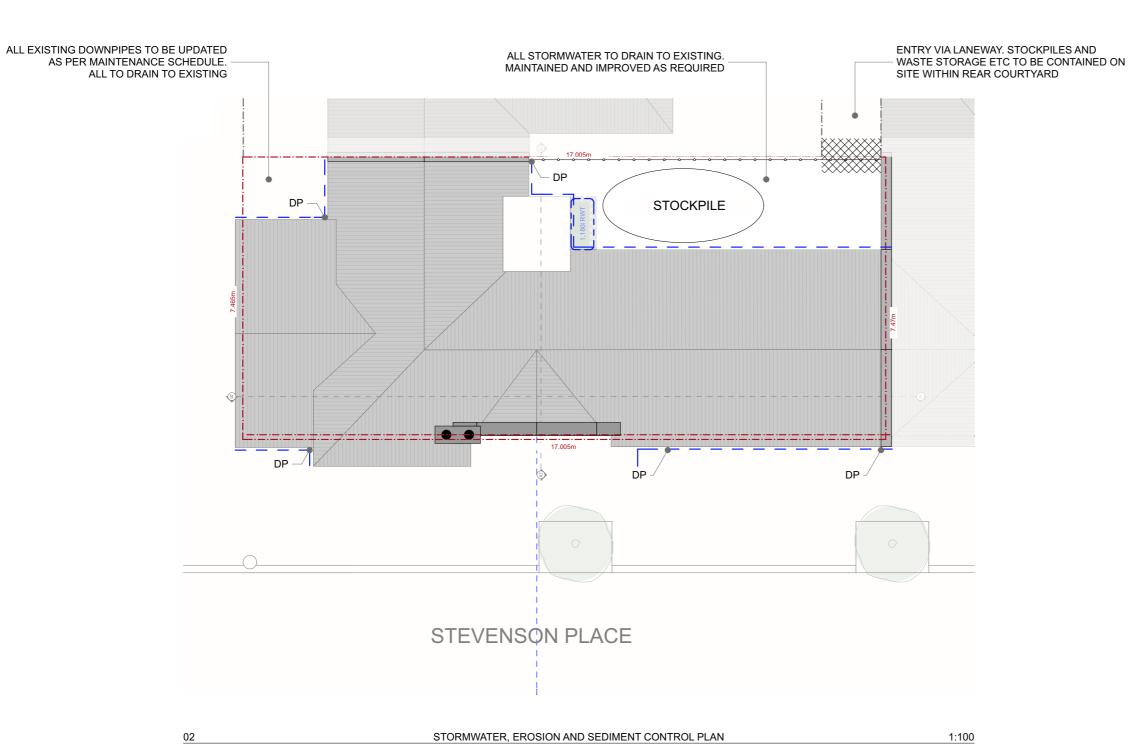Drawing:

Title: Erosion and Sediment Control

Scale: 1:1.00, 1:100 @ A3

Status: Development Application
Drawn Date: Monday, 7 May 2018

Plot Date: Wednesday, 13 March 2019

Drawn

Drawn

Bar Scale:

0 1 2 3 4 5 6 7 3 9 1:200

Drawing No: DA 12 Drawn By: JP



SD 6-8

Building Sustainability Index www.basix.nsw.gov.au

Alterations and Additions

Certificate number: A318931_02

This certificate confirms that the proposed development will meet the NSW government's requirements for sustainability, if it is built in accordance with the commitments set out below. Terms used in this certificate, or in the commitments, have the meaning given by the document entitled "BASIX Alterations and Additions Definitions" dated 06/10/2017 published by the Department. This document is available at www.basix.nsw.gov.au

This certificate is a revision of certificate number A318931 lodged with the consent authority or certifier on 13 Aug 2018 with application 2018/00851.

It is the responsibility of the applicant to verify with the consent authority that the original, or any revised cartificate, complies with the requirements of Sch 1 Cl 2A, 4A or 6A of the Environmental Planning and Assessment Regulation 2000.

Secretary
Date of issue: Wednesday, 13, March 2019
To be valid, this certificate must be lodged within 3 months of the date of issue.

NSW Planning & Environment

Project name	2 Parnell Place_02
Street address	2 Parnell Place Newcastle East 2300
Local Government Area	Newcastle City Council
Plan type and number	Deposited Plan 13965
Lot number	5
Section number	0
Project type	
Dwelling type	Attached dwelling house
Type of alteration and addition	My renovation work is valued at \$50,000 or more and includes a pool (and/or spa).

Certificate Prepared by (please complete before submitting	ng to Council or PCA)
Name / Company Name: Manakin	
ABN (if applicable): 48298811589	

Pool and Spa	Show on DA Plans	Show on CC/CDC Plans & specs	Certifier Check
Rainwater tank			
The applicant must install a rainwater tank of at least 839 litres on the site. This rainwater tank must meet, and be installed in accordance with, the requirements of all applicable regulatory authorities.	1	~	1
The applicant must configure the rainwater tank to collect rainwater runoff from at least 107.32 square metres of roof area.		~	~
The applicant must connect the rainwater tank to a tap located within 10 metres of the edge of the pool.		~	~
Indoor swimming pool			
The swimming pool must be indoors.	1	V	1
The swimming pool must not have a capacity greater than 8 kilolitres.	1	1	~
The swimming pool must have a pool cover.		1	1
The applicant must install a pool pump timer for the swimming pool.		1	~
The applicant must install the following heating system for the swimming pool that is part of this development: electric heat pump.		1	1

Fixtures and systems	Show on DA Plans	Show on CC/CDC Plans & specs	Certifier Check
Hot water			
The applicant must install the following hot water system in the development: gas instantaneous.	1	~	1
Lighting			
The applicant must ensure a minimum of 40% of new or altered light fixtures are fitted with fluorescent, compact fluorescent, or light-emitting-diode (LED) lamps.		~	~
Fixtures			
The applicant must ensure new or altered showerheads have a flow rate no greater than 9 litres per minute or a 3 star water rating.		1	1
The applicant must ensure new or altered toilets have a flow rate no greater than 4 litres per average flush or a minimum 3 star water rating.		1	1
The applicant must ensure new or altered taps have a flow rate no greater than 9 litres per minute or minimum 3 star water rating.		1	

The applicant must ensure new or altered taps		1	*		
Construction			Show on DA Plans	Show on CC/CDC Plans & specs	Certifier Check
nsulation requirements					
	d construction (floor(s), walls, and ceilings/roofs) ation is not required where the area of new constru where insulation already exists.		V	V	V
Construction	Additional insulation required (R-value)	Other specifications			
concrete slab on ground floor.	nil				
suspended floor with open subfloor: framed (R0.7).	R0.8 (down) (or R1.50 including construction)				
external wall: framed (weatherboard, fibro, metal clad)	R1.30 (or R1.70 including construction)				
	ceiling: R3.00 (up), roof: foil/sarking	medium (solar absorptance 0.475 - 0.70)			
flat ceiling, pitched roof	ceiling: ris.ou (up), root: loll/sarking	modium (solai absorptance 0.475 0.70)			

Glazing requ	irements						Show on DA Plans	Show on CC/CDC Plans & specs	Certifier Check
Windows and	glazed do	ors							
					hading devices, in accordar reach window and glazed of	nce with the specifications listed in the table below. door.	V	~	~
The following re	equirements i	nust also	be satisfi	ed in relation	n to each window and glaze	d door:		1	1
have a U-value	and a Solar	Heat Gair	Coefficie	ent (SHGC)		r or toned glass may either match the description, or, the table below. Total system U-values and SHGCs anditions.		1	~
					f each eave, pergola, veran than 2400 mm above the si	dah, balcony or awning must be no more than 500 mm	1	1	~
For projections least that show			ne ratio o	f the projecti	on from the wall to the heigh	nt above the window or glazed door sill must be at	~	~	~
Pergolas with p	olycarbonate	roof or s	imilar tran	slucent mat	erial must have a shading o	pefficient of less than 0.35.		1	1
					e window or glazed door ab ens must not be more than	ove which they are situated, unless the pergola also 50 mm.		1	~
Pergolas with a must overlap in		iding may	have ad	justable blad	es or removable shade clot	h (not less than 80% shading ratio). Adjustable blades		~	~
Overshadowing specified in the					nt and distance from the cer	ntre and the base of the window and glazed door, as	~	V	~
Windows an	d glazed o	loors g	lazing r	equireme	nts				
Window / door	Orientation		Oversha	adowing	Shading device	Frame and glass type			
no.		glass inc. frame (m2)	Height (m)	Distance (m)					
W1	W	1.44	11.4	4.2	none	standard aluminium, single clear, (or U-value: 7.63, SHGC: 0.75)			
W2	S	0.87	11.4	3.7	none	standard aluminium, single clear, (or U-value: 7.63, SHGC: 0.75)			

Glazing requ	irements						Show on DA Plans	Show on CC/CDC Plans & specs	Certifie Check
Window / door no.	Orientation	Area of glass inc. frame (m2)	Oversha Height (m)	adowing Distance (m)	Sheding device	Frame and glass type			
W3	S	0.9	11.4	3.7	none	standard aluminium, single clear, (or U-value: 7.63, SHGC: 0.75)			
W4	E	3.36	11.4	4.5	none	standard aluminium, single clear, (or U-value: 7.63, SHGC: 0.75)			
W5	S	8.16	0	0	none	standard aluminium, single clear, (or U-value: 7.63, SHGC: 0.75)			
W6	N	0.54	0	0	projection/height above sill ratio >=0.23	standard aluminium, single clear, (or U-value: 7.63, SHGC: 0.75)			
W7	N	0.54	0	0	projection/height above sill ratio >=0.23	standard aluminium, single clear, (or U-value: 7.63, SHGC: 0.75)			
W8	W	1.26	7	4.2	none	standard aluminium, single clear, (or U-value: 7.63, SHGC: 0.75)			
W9	S	0.78	0	0	none	standard aluminium, single clear, (or U-value: 7.63, SHGC: 0.75)			
W10	W	2.4	4.4	4.2	eave/verandah/pergola/balcony >=450 mm	standard aluminium, single clear, (or U-value: 7.63, SHGC: 0.75)			
W11	S	1.89	0	0	eave/verandah/pergola/balcony >=450 mm	standard aluminium, single clear, (or U-value: 7.63, SHGC: 0.75)			
W12	s	1.89	0	0	eave/verandah/pergola/balcony >=450 mm	standard aluminium, single clear, (or U-value: 7.63, SHGC: 0.75)			
D1	S	4.4	0	0	none	standard aluminium, single clear, (or U-value: 7.63, SHGC: 0.75)			
D2	E	6.51	0	0	pergola (adjustable shade) >=900 mm	standard aluminium, single clear, (or U-value: 7.63, SHGC: 0.75)			

Glazing requ	Show on DA Plans	Show on CC/CDC Plans & specs	Certifie Check			
The following re		be satisfied in relation to each	ow, in accordance with the specifications listed in the table. glazed roof:	~	V	√ √
Glazed roof number	Area of glazing (m2)	Shading device	Glass type			
G1	5.2	no shading	improved aluminium, single pyrolytic low-e, (U-value: 4.48, SHGC: 0.46)			

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6. ALL DIMENSIONS ARE IN MILLIMETERS UNLESS NOTED OTHERWISE.

7. ALL MATERIALS TO BE INSTALLED IN ACCORDANCE WITH MANUFACTURERS SPECIFICATIONS.

SPECIFICATIONS.
8. TIMBER TRUSS ROOF AND WALL FRAMING TO MANUFACTURERS DESIGN AND SPECIFICATION

NOT FOR CONSTRUCTION

Revision: D 13.03.19



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Project Number: 17008

Aterations and Additions at 2 Parnell Place, Newcastle East 2300 Lot 5 / DP13965

Proprietor:

Peter and Gail Cornish

Drawing:

BASIX Requirements Title:

@ A3 Scale:

Development Application Status:

Drawn Date: Wednesday, 13 March 2019 Plot Date: Wednesday, 13 March 2019 Bar Scale:

Drawing No: DA14 Drawn By: JP



1. SHOWS VALLEY RAFTERS FOR A TRANSVERSE ROOF FORM

2. SHOWS TOP OF BRICKWORK ABOVE THIS SECTION OF EXTERNAL WALL. NO WALL PLATE IS PRESENT IN THIS SECTION AS IT IS IN OTHERS


6. REPLACED CEILING WITHIN
AFFECTED ROOM. PROVIDING
EVIDENCE THAT THIS ROOM
HAD BEEN DAMAGED AND
REPAIRED IN THE PAST

5. DECORATIVE CEILING IN ADJACENT HALLWAY







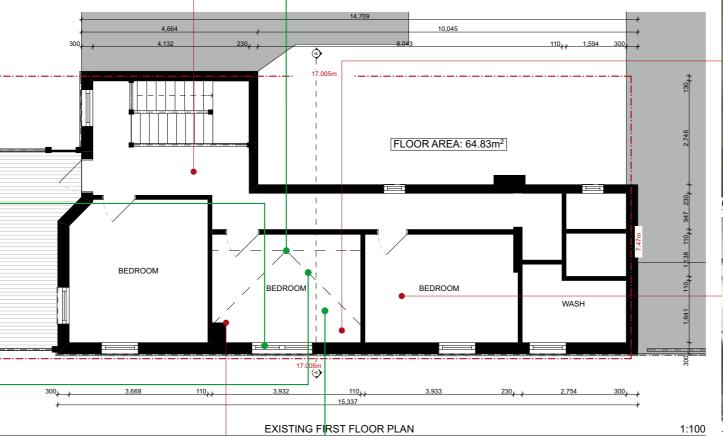



Notes

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 ALL WORKMANSHIP AND MATERIALS TO BE

3. ALL DIMENSIONS AND LEVELS 10 DE CHECKED AND VERIFIED BY BUILDER.

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8. TIMBER TRUSS ROOF AND WALL FRAMING

TO MANUFACTURERS DESIGN AND SPECIFICATION

NOT FOR CONSTRUCTION

Revision: D 13.03.19



4. SHOWS MIXED TIMBER TYPES. THE DARKER TIMBER TO THE LEFT OF THE IMAGE IS OREGON AND APPEARS TO HAVE BEEN REUSED (UPSIDE DOWN) FROM PART OF THE ORIGINAL ROOF STRUCTURE.

THE LIGHTER TIMBER IS A HARDWOOD THAT DOESN'T MATCH THE REMAINING ROOF TIMBERS AND LOOKS TO HAVE BEEN INSTALLED AS PART OF REPAIR WORK.

ALSO VISIBLE NEAR THE WALL JUNCTION IS THE END OF A RAFTER TAIL THAT IS SEPARATE FROM THE RAFTER ITSELF, THIS DIFFERS FROM THE REMAINING ORIGINAL ROOFING

7. DECORATIVE CEILING IN ADJACENT BEDROOM SPACE

8. REPLACED CEILING WITHIN AFFECTED ROOM. PROVIDING EVIDENCE THAT THIS ROOM HAD BEEN DAMAGED AND REPAIRED IN THE PAST





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3. SHOWS VALLEY RAFTER

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Aterations and Additions at 2 Parnell Place, Newcastle East 2300 Lot 5 / DP13965

Proprietor:

Peter and Gail Cornish

Drawing:

Title: Stevenson Place Gable Reconstruction

Scale: 1:100 @ A3

Status: Development Application
Drawn Date: Tuesday, 18 February 2019
Plot Date: Wednesday, 13 March 2019


Bar Scale:

Drawing No: D A 15
Drawn By: J P


1. SHOWS VALLEY RAFTERS FOR A TRANSVERSE ROOF FORM.

2. SHOWS TOP OF BRICKWORK ABOVE THIS SECTION OF EXTERNAL WALL. NO WALL PLATE IS PRESENT IN THIS SECTION AS IT IS IN OTHERS

5 / 8. SHOWS DETAIL VIEW OF IMAGE 6 / 7. RAFTER TAILS OVER THE REPAIRED SECTION OF ROOF ARE CLEARLY DIFFERENT. THEY ARE WIDER AND HAVE A

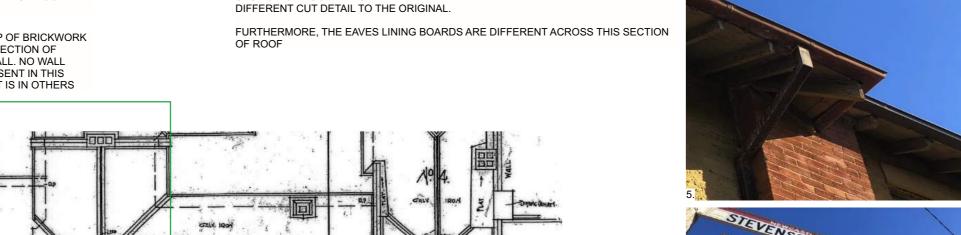




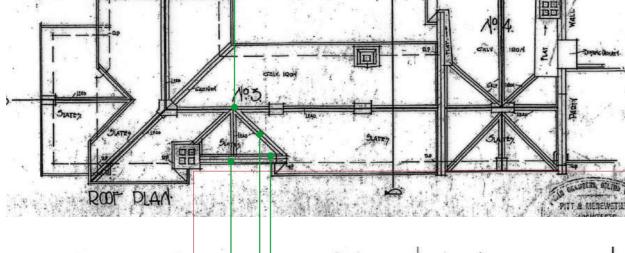







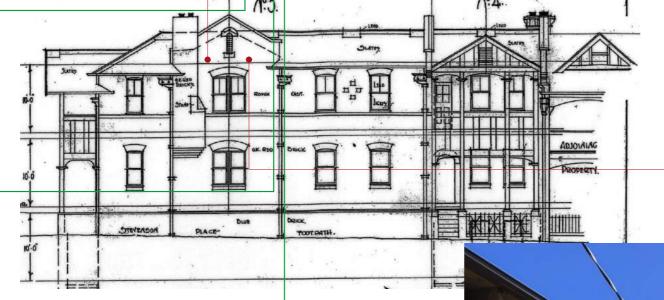

4. SHOWS MIXED TIMBER TYPES. THE DARKER TIMBER TO THE LEFT OF THE IMAGE IS OREGON AND APPEARS TO HAVE BEEN REUSED (UPSIDE DOWN) FROM PART OF THE ORIGINAL ROOF STRUCTURE.

THE LIGHTER TIMBER IS A HARDWOOD THAT DOESN'T MATCH THE REMAINING ROOF TIMBERS AND LOOKS TO HAVE BEEN INSTALLED AS PART OF REPAIR WORK.

ALSO VISIBLE NEAR THE WALL JUNCTION IS THE END OF A RAFTER TAIL THAT IS SEPARATE FROM THE RAFTER ITSELF, THIS DIFFERS FROM THE REMAINING ORIGINAL ROOFING



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3. SHOWS VALLEY RAFTER

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Project Number:

2 Parnell Place, Newcastle East 2300 Lot 5 / DP13965

Proprietor:

Peter and Gail Cornish



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SPECIFICATIONS. 8 TIMBER TRUSS ROOF AND WALL FRAMING TO MANUFACTURERS DESIGN AND SPECIFICATION

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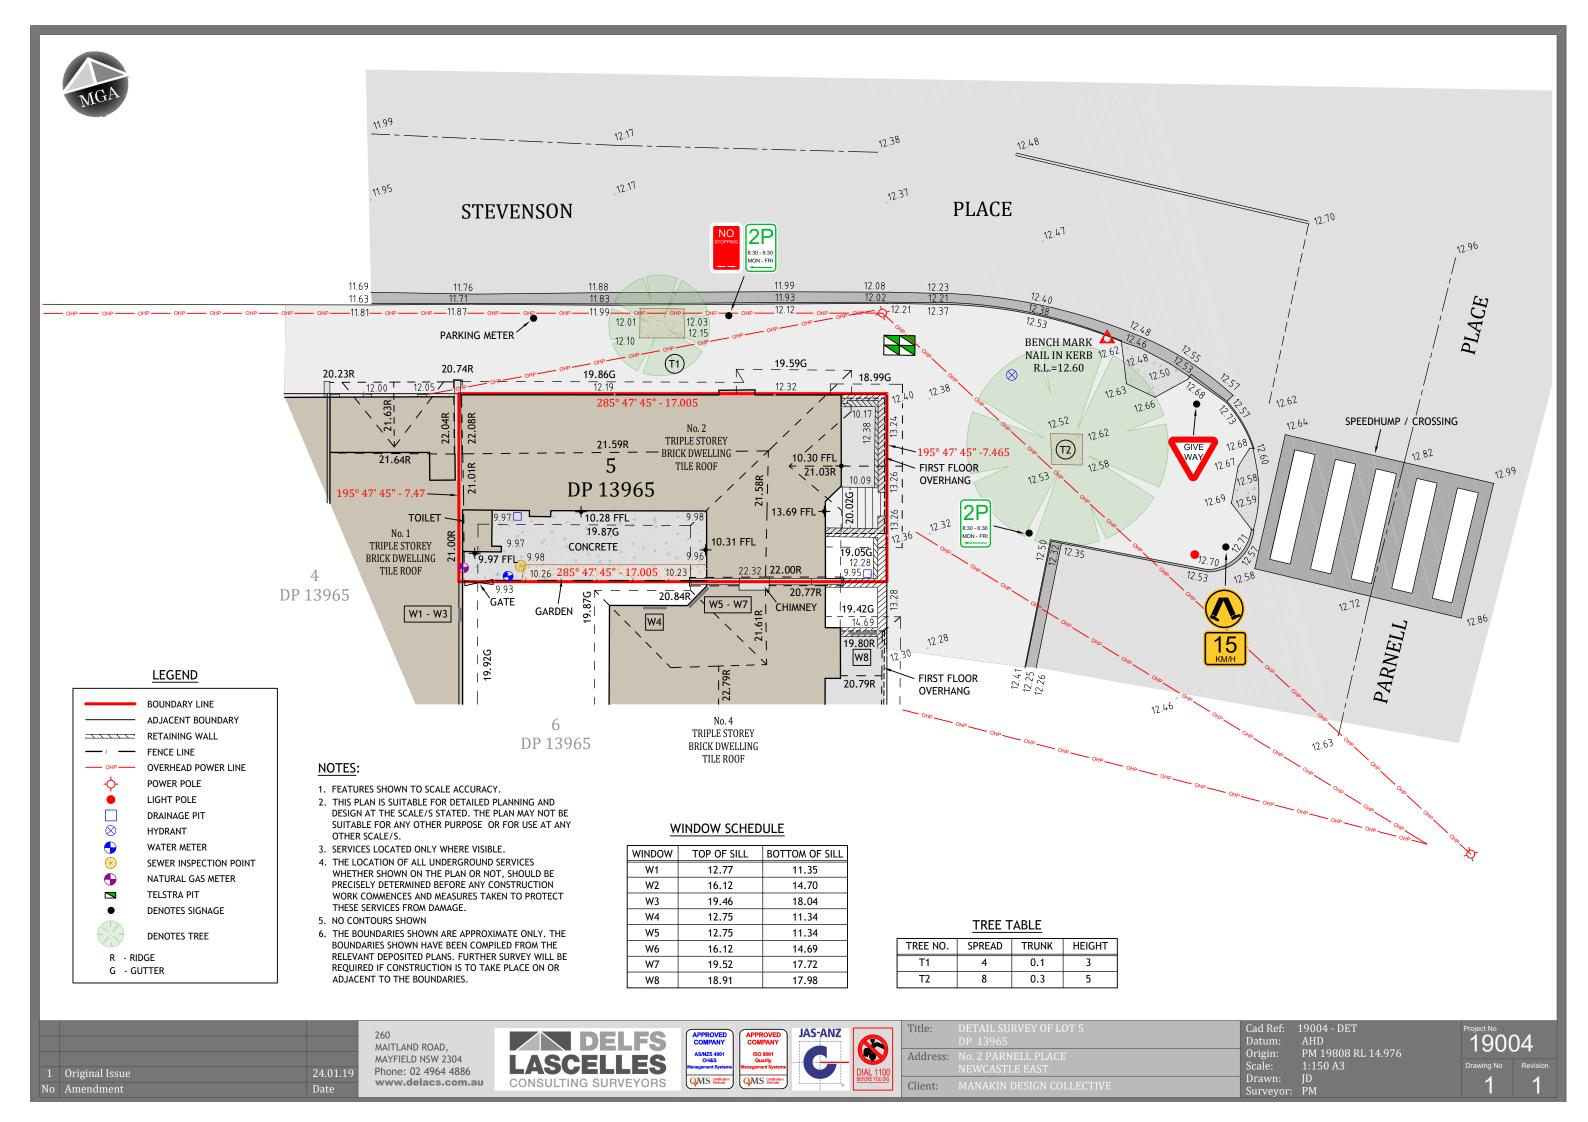
Drawing: 17008 Title: Stevenson Place Gable Reconstruction Aterations and Additions at Scale:

> Development Application Status: Drawn Date: Tuesday, 18 February 2019 Plot Date: Wednesday, 13 March 2019

Drawing No: DA 16 Drawn By: JP

Bar Scale:





DEVELOPMENT APPLICATIONS COMMITTEE MEETING

18 June 2019

ATTACHMENTS DISTRIBUTED UNDER SEPARATE COVER

REPORTS BY COUNCIL OFFICERS

Attachment A - Plans DA2016/00982.01 - 70 & 72 Blue Gum Road

Jesmond

Changes to floor plan layout, additional storey with

additional units

DISTRIBUTED UNDER SEPARATE COVER

Proposed Residential Apartments at

70-72 Blue Gum Road Jesmond NSW 2299

Car Pa	arkir	ng			
Units	s	Residents	Visitors	Staff	Total
A =	16	16	3	1	20
B =	18	18	4	-	22
C =	8	8	2	-	10
Total:	42			Spaces:	52

5,153.70
0,100.70
1,462.06
1,477.18
848.90
3,788.14
0.74
3
3
36 42
42
52
982.49
19.06%
919.63
637.45
568.54
750.68
2876.3 55.81%

Drawing No:

A0.02

A1.01

A1.02

A1.03

A1.04

A1.05

A1.06

A1.07

A1.08

A1.09

A2.01

A3.01

A7.01

A7.02

A7.03

A7.04

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Cover Sheet

Site Location Plan

Site Analysis Plan

Ground Floor Plan - Block A

Level 1 Floor Plan - Block A

Level 2 Floor Plan - Block A

Level 3 Roof Plan - Block A

Roof Plan - Blocks B + C

Elevations

Sections

Ground Floor Plan - Blocks B + C

Level 1 Floor Plan - Blocks B + C

Level 2 Floor Plan - Blocks B + C

Level 3 Floor Plan - Blocks B + C

Shadow Diagrams - June 21 0900

Shadow Diagrams - June 21 1200

Shadow Diagrams - June 21 1300

Shadow Diagrams - June 21 1400

Shadow Diagrams - June 21 1500

Perspective Views

Perspective Views

Typical Floor Plan - Block A Solar Access Dia...

Typical Floor Plan - Blocks B + C Solar Acces...

Drawing Sheet Index

General Plans

Floor Plans

Elevations

Sections


Solar and Shadow Studies

3D Representation

Flood Zone Fill Areas						
Zone Name	Measured Area					
Block A Ground	98.82					
Block B Ground	67.85					
Block C Basement	565.71					
Ramps	160.11					
	892.49 m					

	Gross Floor Area	S
Building Name	Floor	Measured Area
Block A		
	Ground Level	9.37
	Level 1	719.87
	Level 2	732.82
		1,462.06 m ²
Block B		
	Ground Level	11.92
	Level 1	510.38
	Level 2	516.50
	Level 3	438.38
		1,477.18 m ²
Block C		
	Ground Level	6.31
	Level 1	422.68
	Level 2	419.91
		848.90 m ²
		3,788.14 m²

Max FSR = 5153.70 * 0.9 = 4,638.33m²

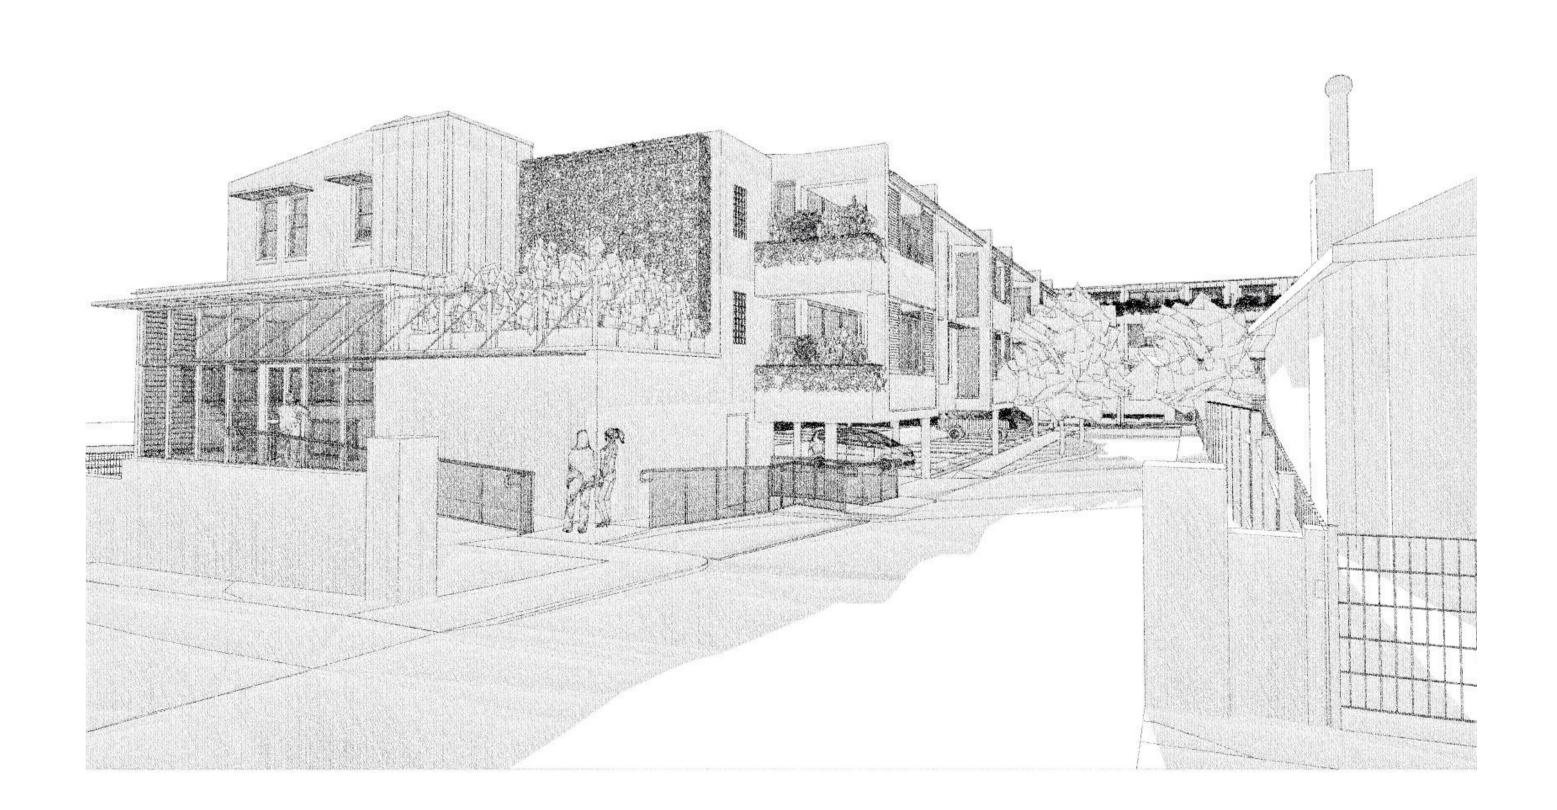


Rev	Description	Date
Α	Issued for Development Application	1/08/2016
В	UDCG UPDATED PLANS	2/11/2016
С	REVISED DA PLANS	1/06/2017
D	UPDATED DA PLANS	17/07/2017
E	REVISED DA ISSUE	5/10/2017
F	SECTION 96 SUBMISSION	28/11/2017
G	REVISED DA SUBMISSION	3/12/2018



ACN 077 876 129

	PROJECT DA Submission Residential Apartments At 70-72 Blue Gum Road		
OCEANIA CLARKE TY LIMITED Architecture and Interiors	Jesmond NSW 2299		
sked Bag 3005 nandale NSW 2038	FOR		

General Plans Cover Sheet SCALE: 1:1 on A1 167 DATE: **3/12/2018** GHT Holdings Pty Ltd PO Box 522 Maitland NSW 2320 DRAWN: GB A0.01-G

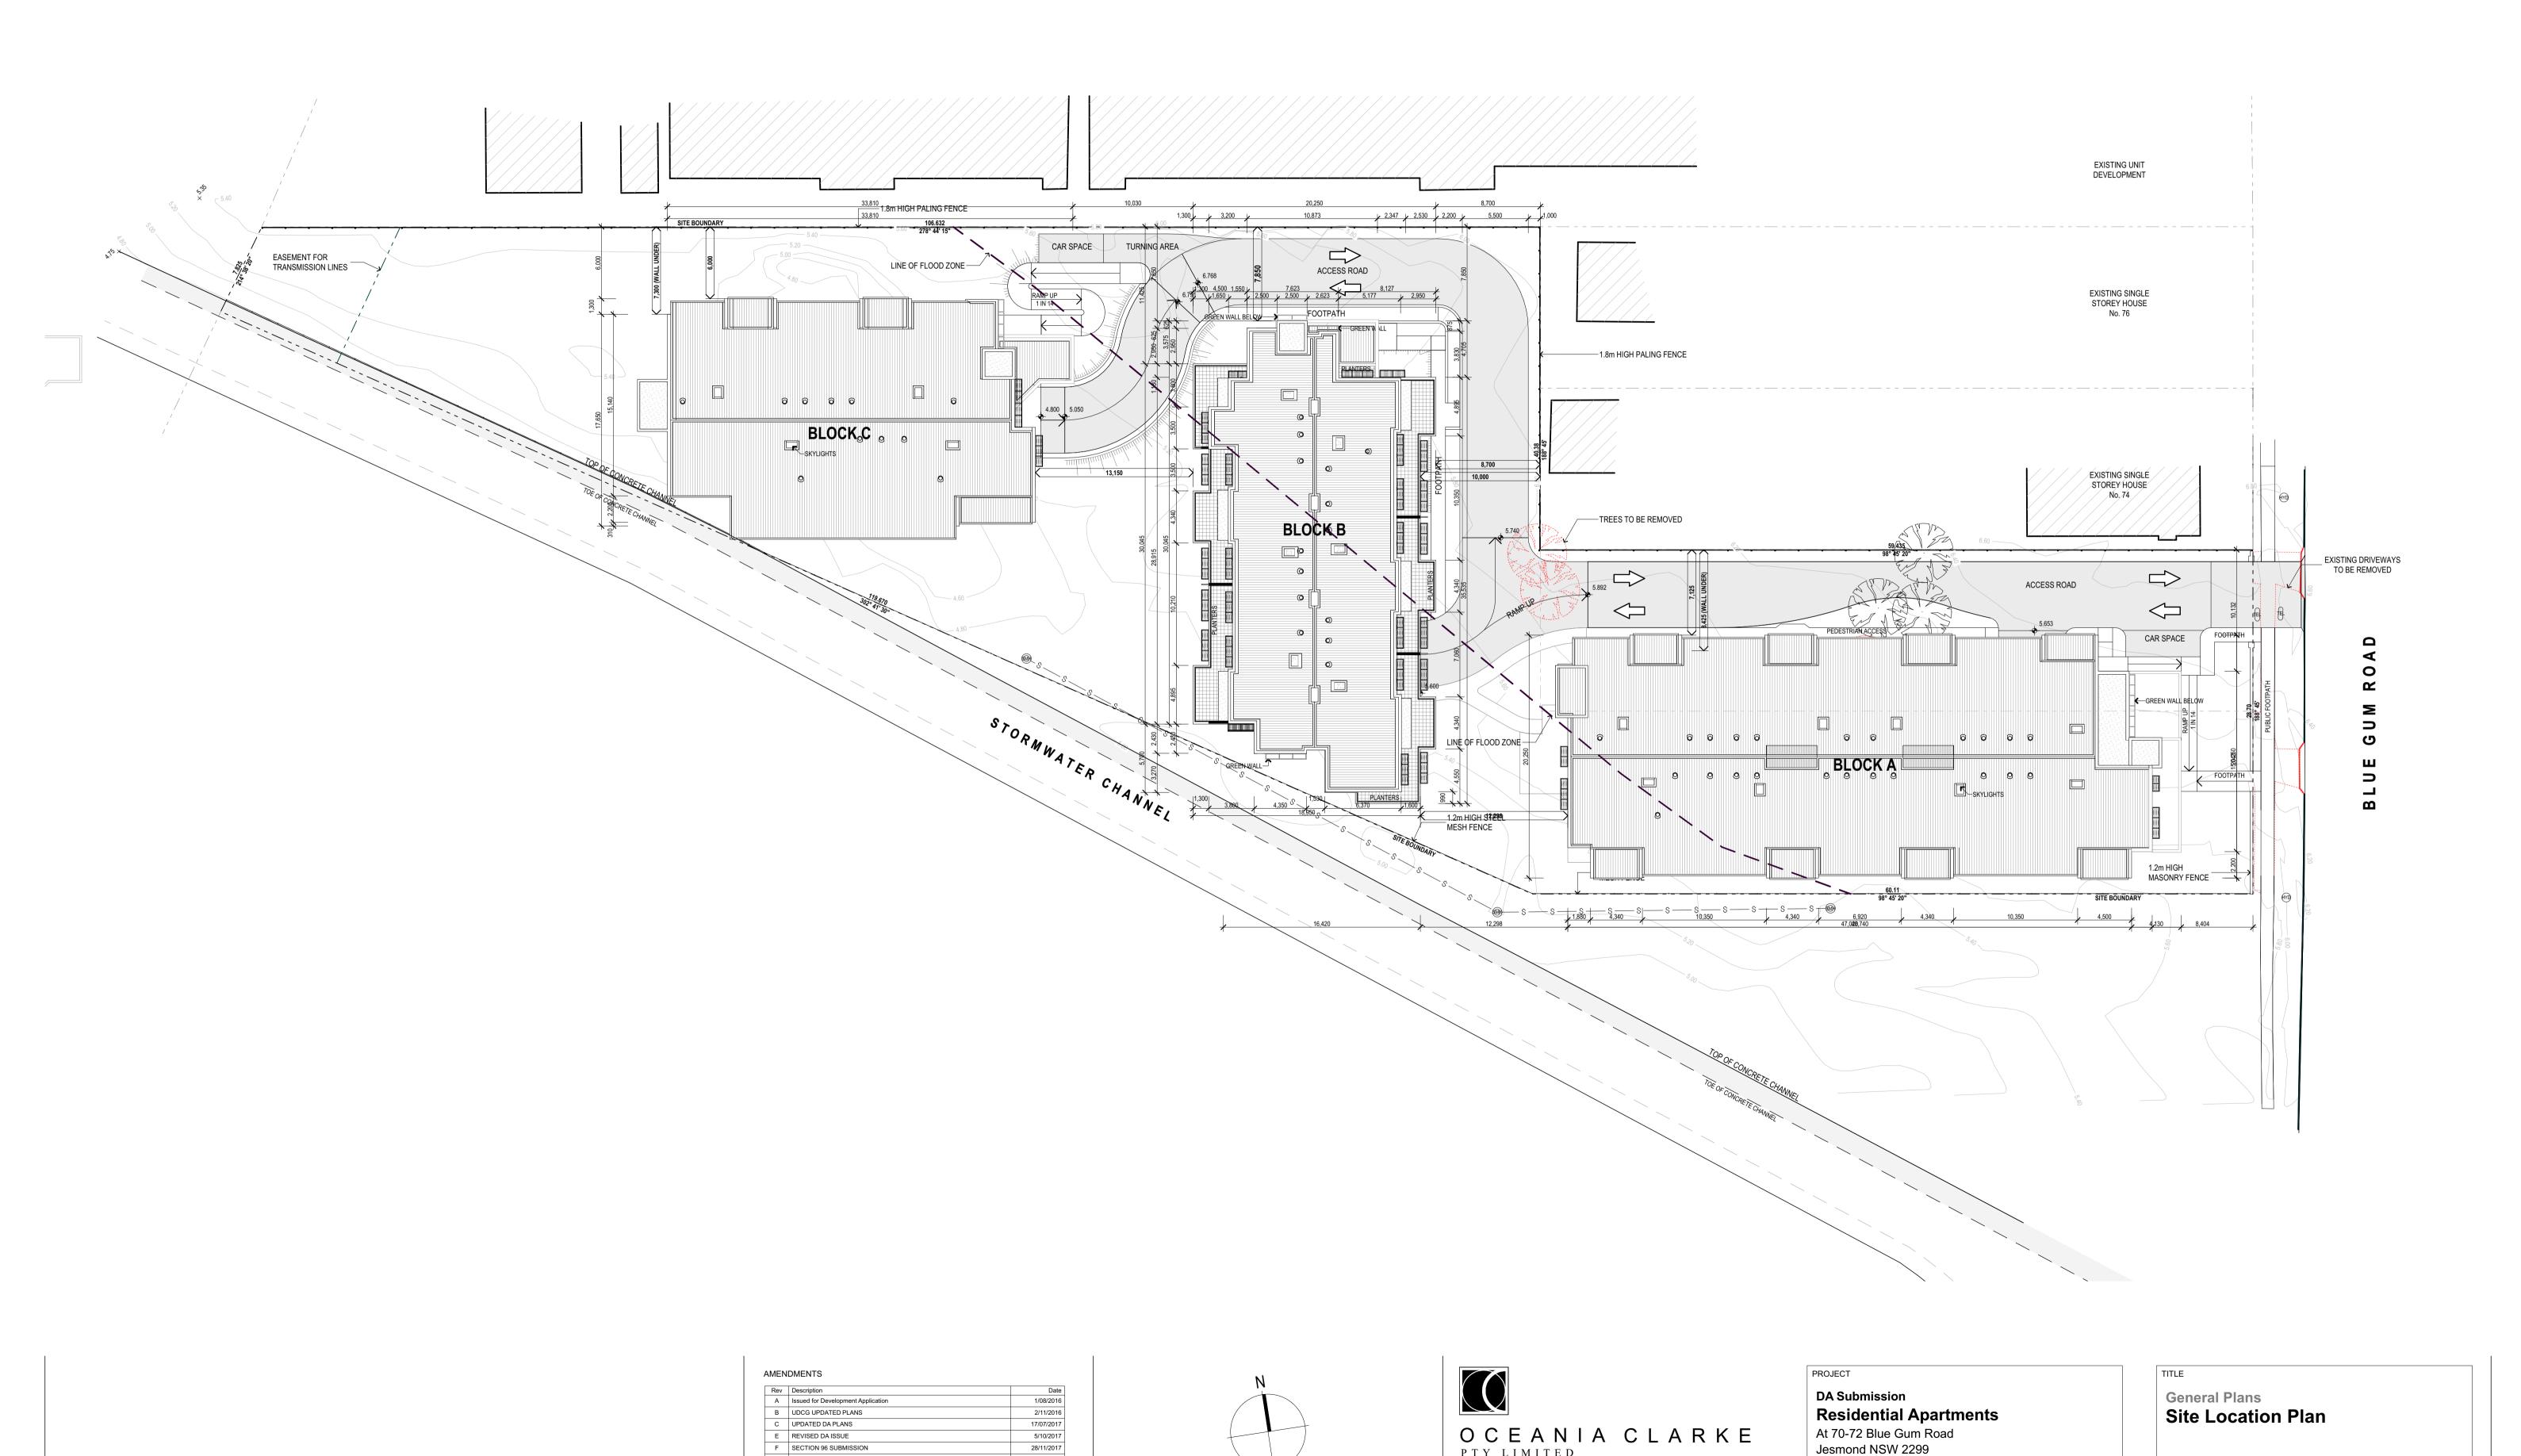

0 2.5 5 10 Scale 1:250 METRES

B UDCG UPDATED PLANS C UPDATED DA PLANS

F SECTION 96 SUBMISSION

G REVISED DA SUBMISSION

3/12/2018

E REVISED DA ISSUE

Site Location Plan

SCALE: 1:250 on A1

DATE: **3/12/2018**

DRAWN: GB

PROJECT

DRAWING No.

167

A0.02-G

Residential Apartments

At 70-72 Blue Gum Road

GHT Holdings Pty Ltd PO Box 522 Maitland NSW 2320

Jesmond NSW 2299


OCEANIA CLARKE


Architecture and Interiors


Locked Bag 3005 Annandale NSW 2038 Tel 9557 6005 Fax 9557 6009


oceaniaclarke@bigpond.com


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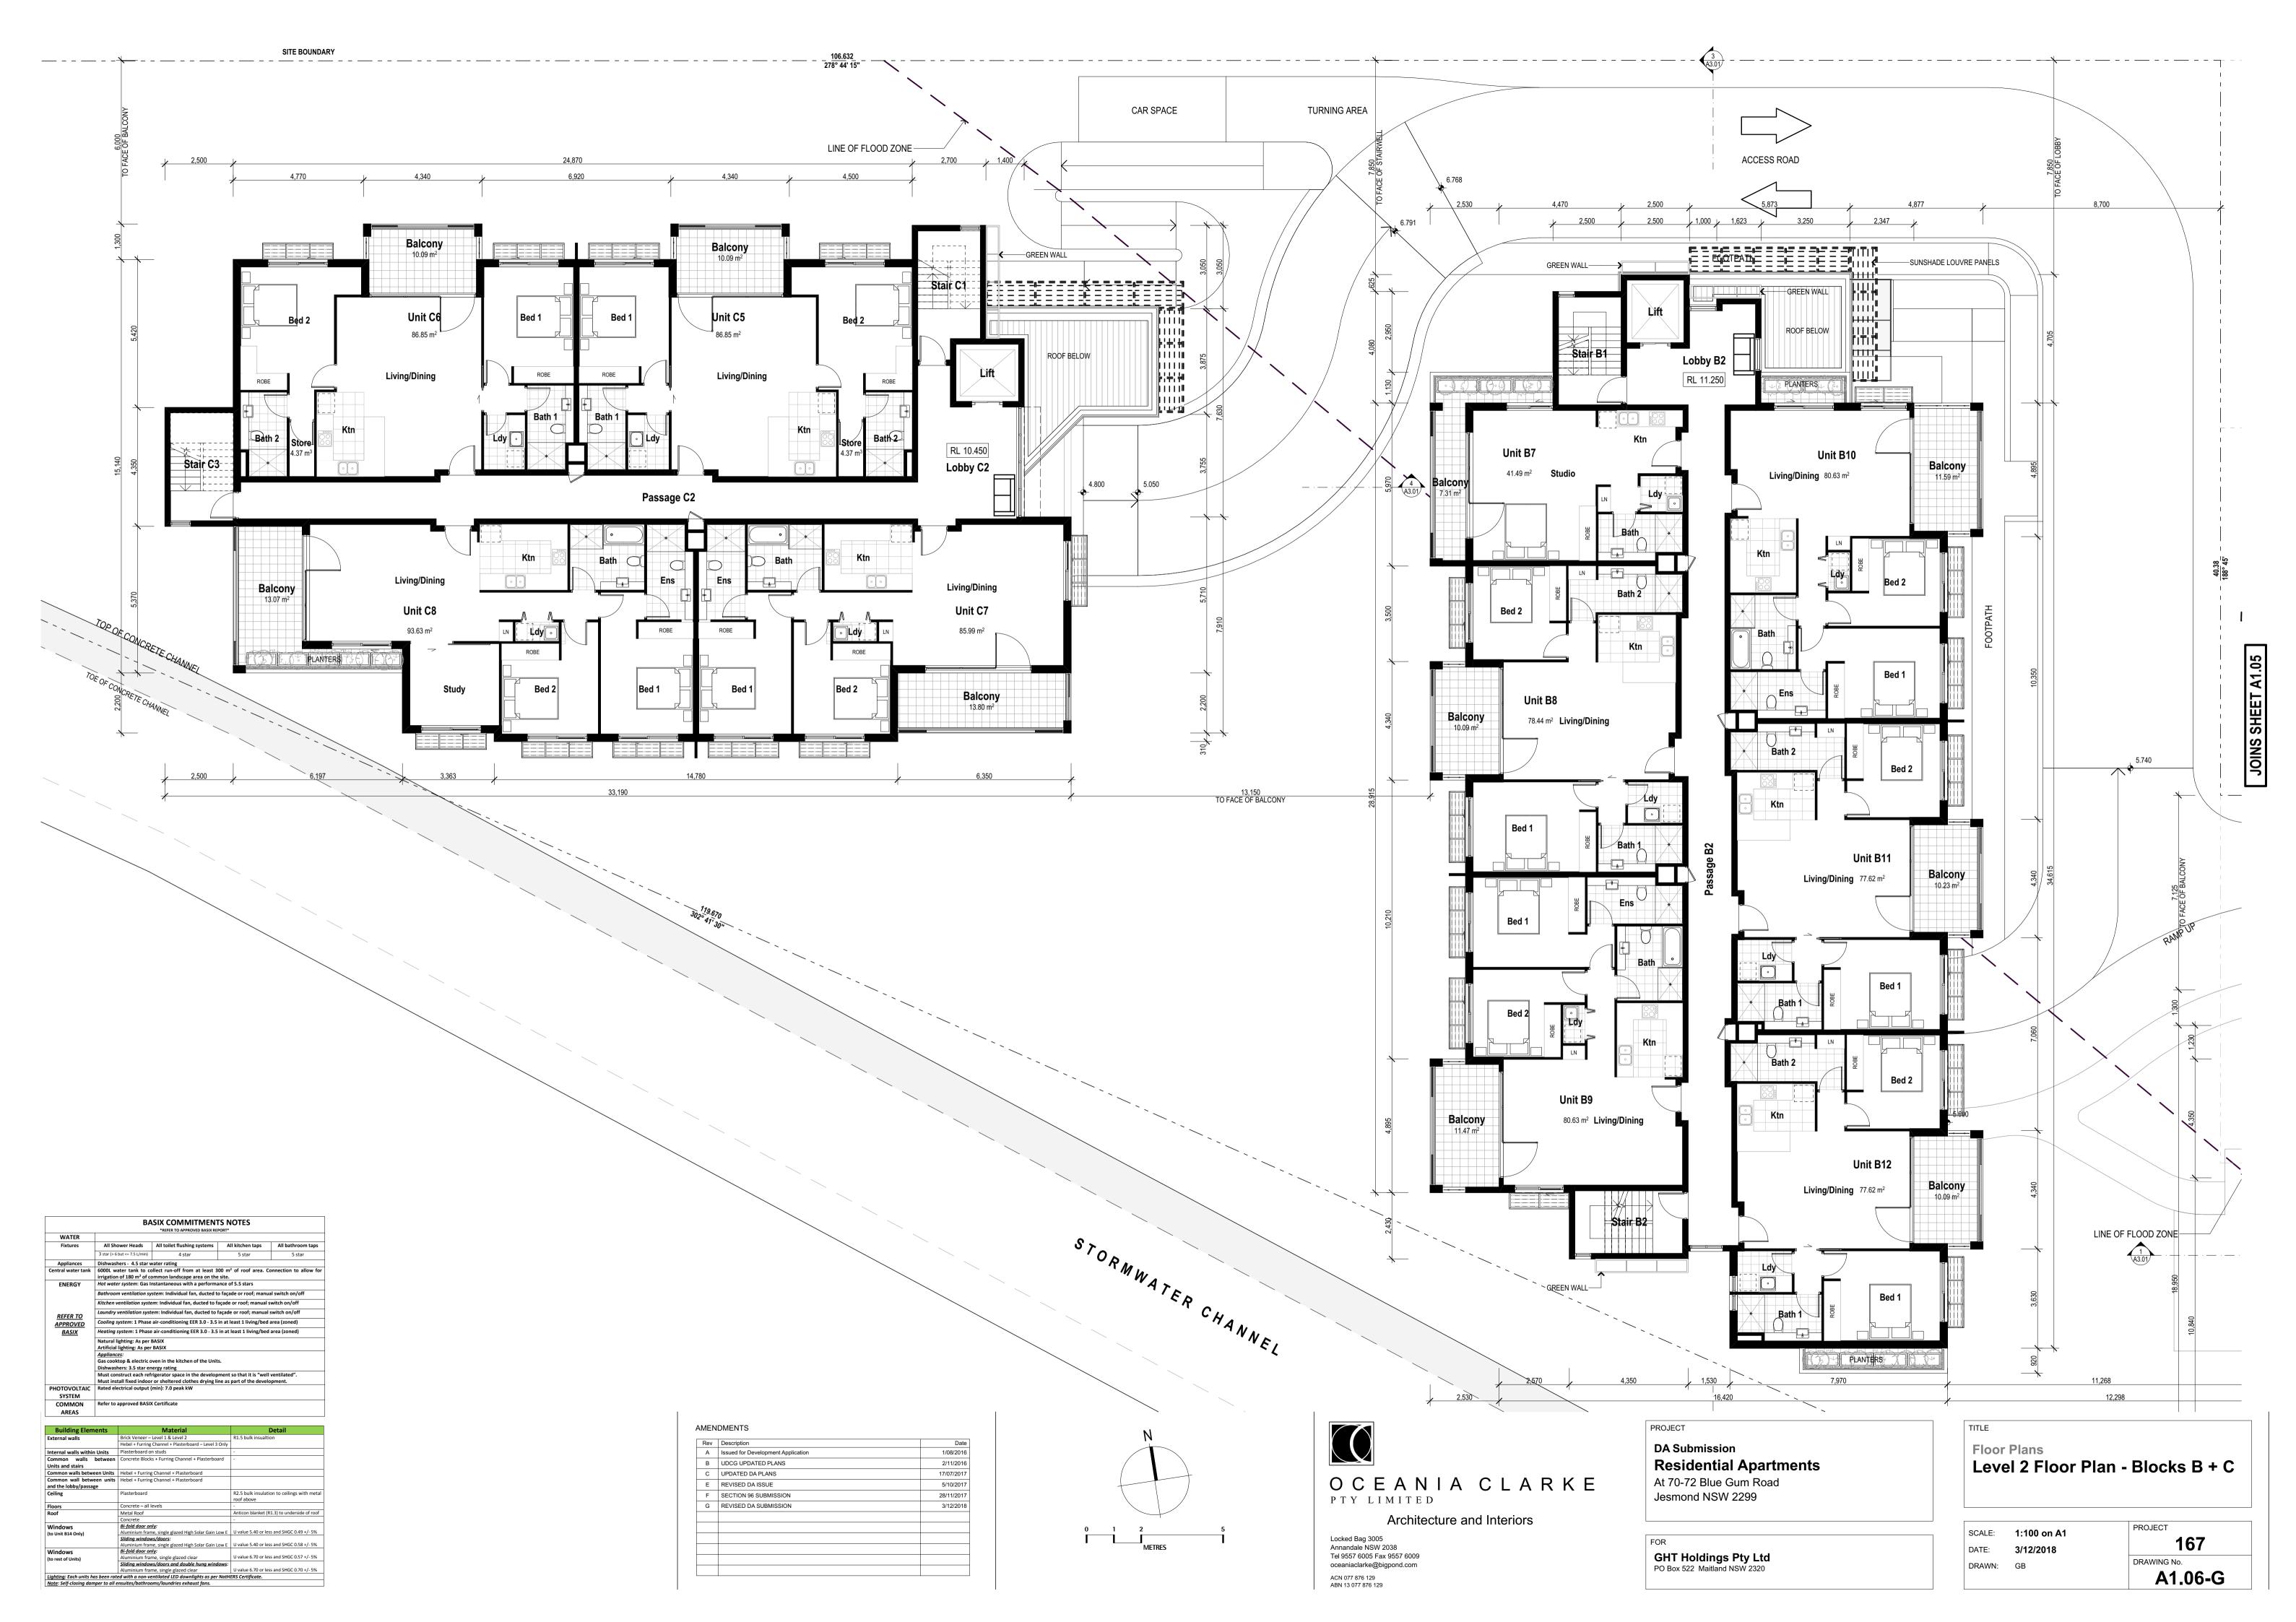


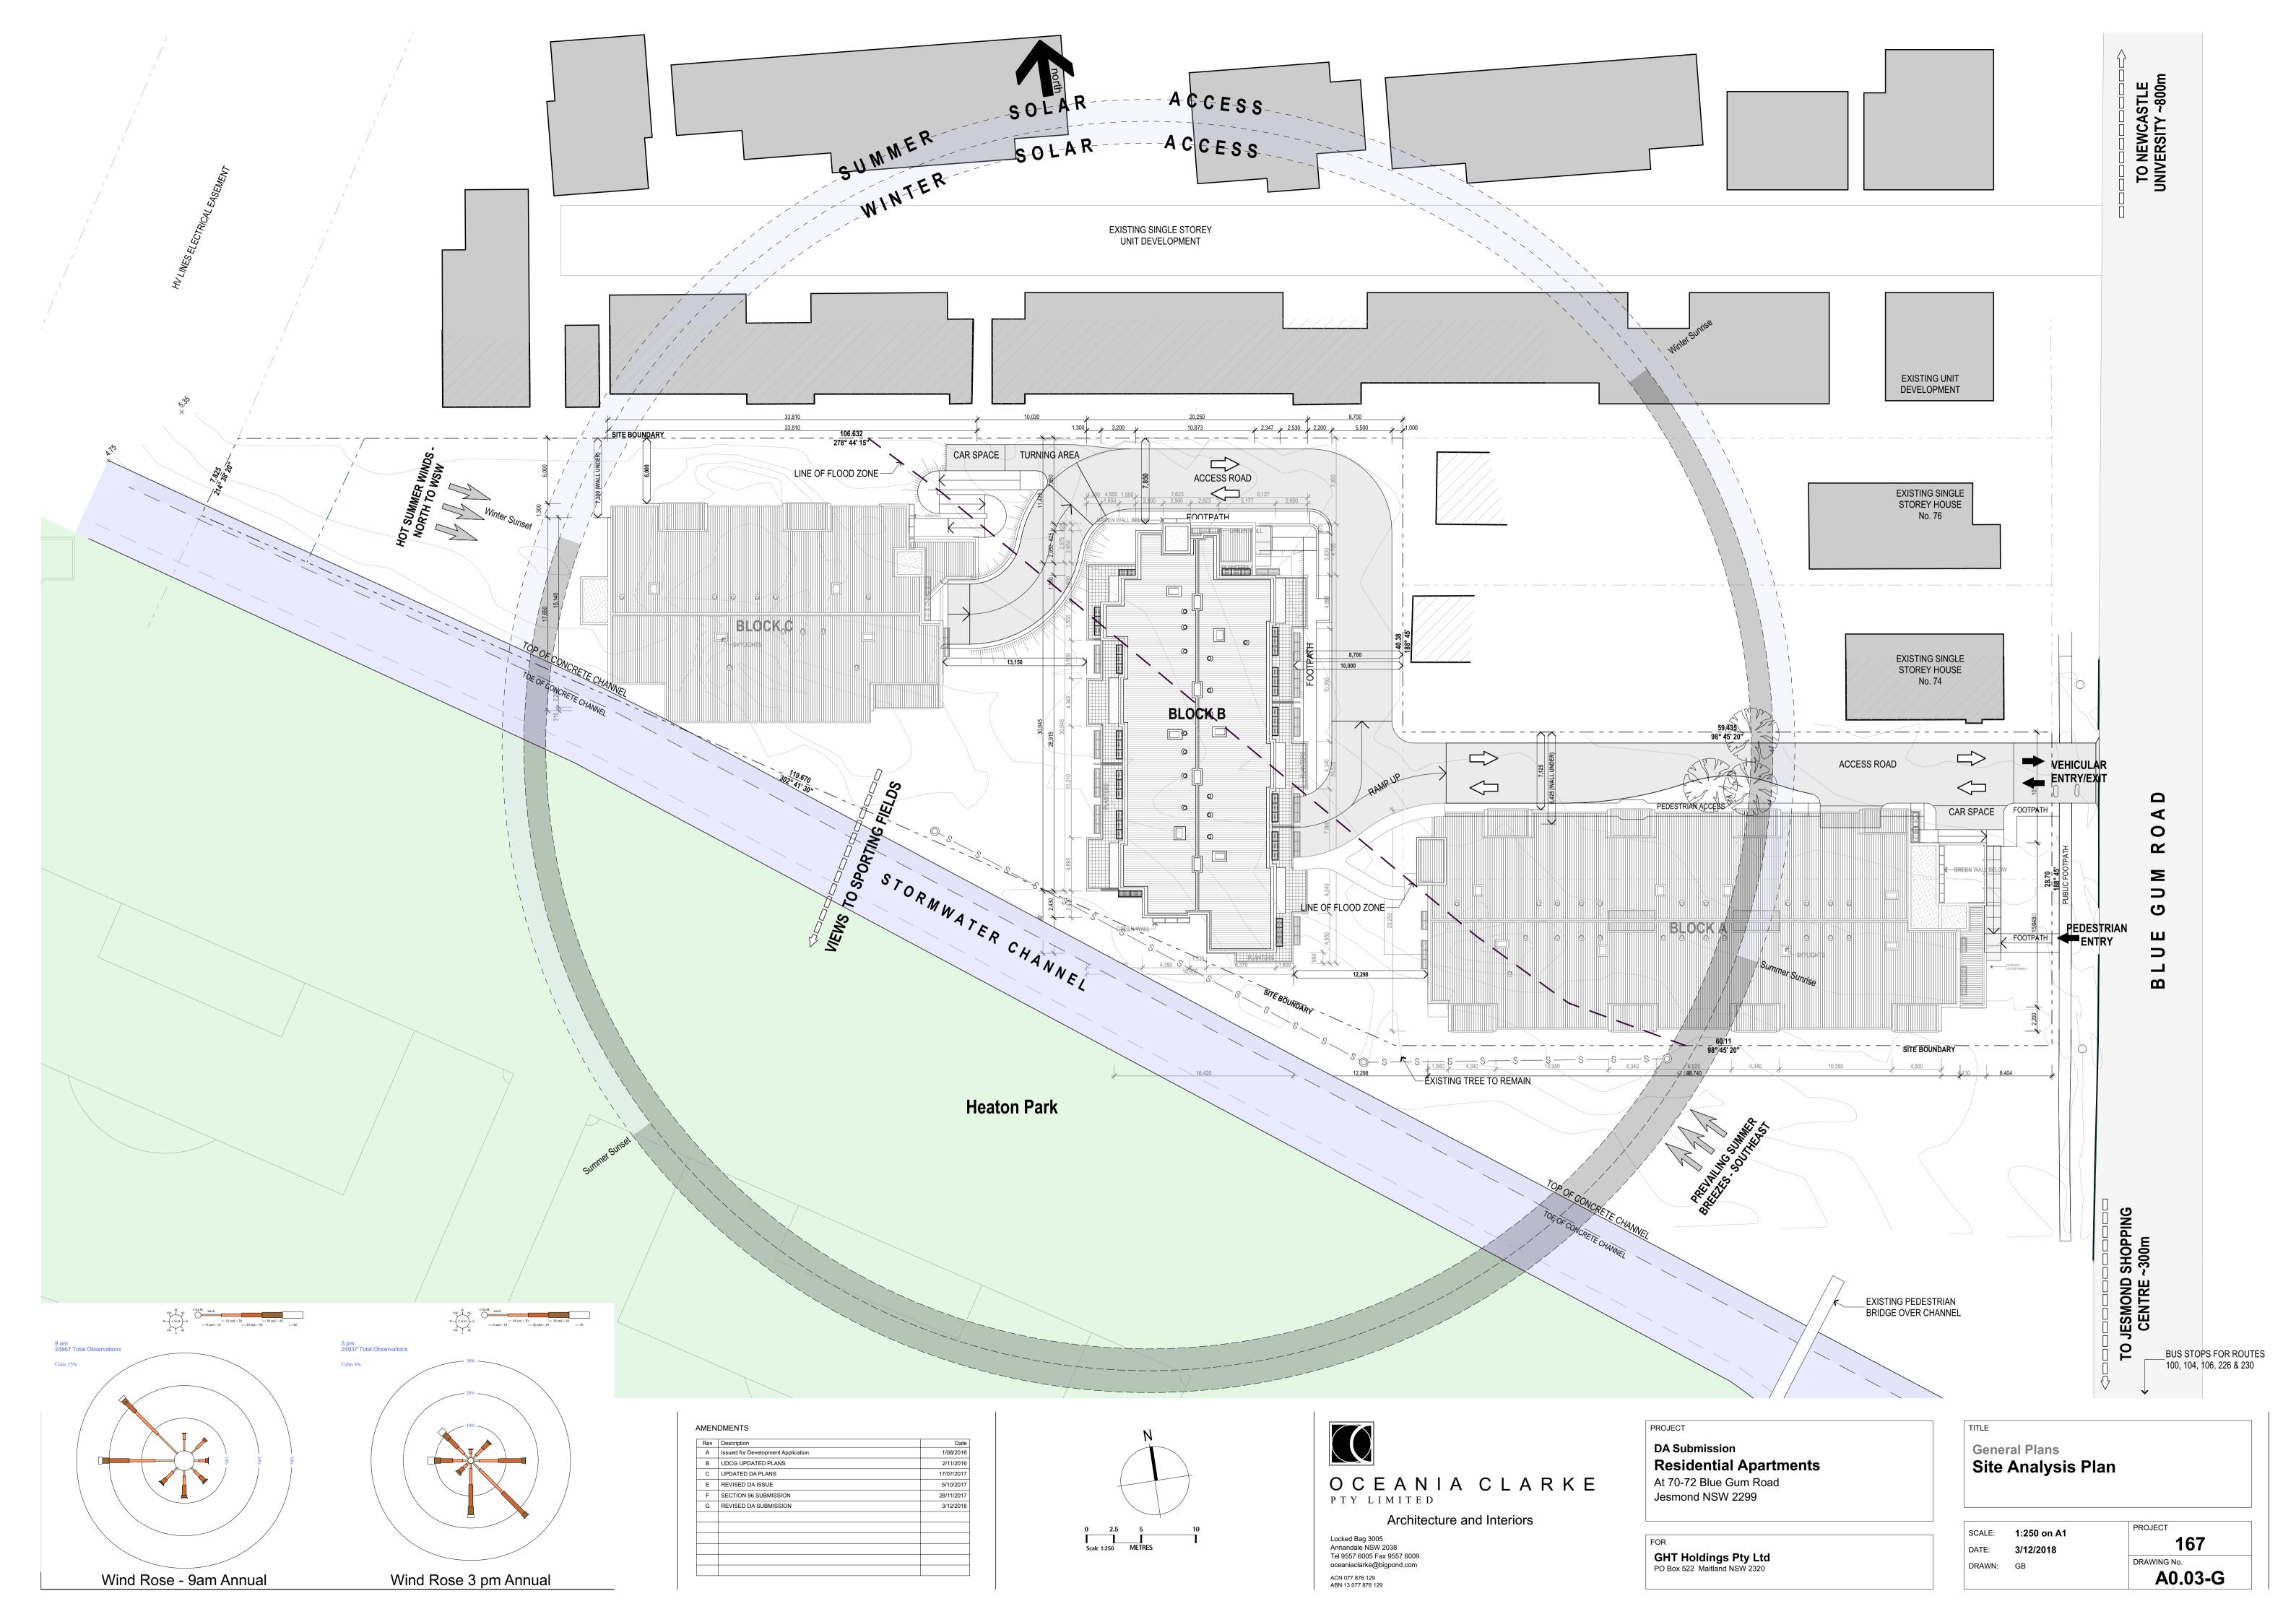


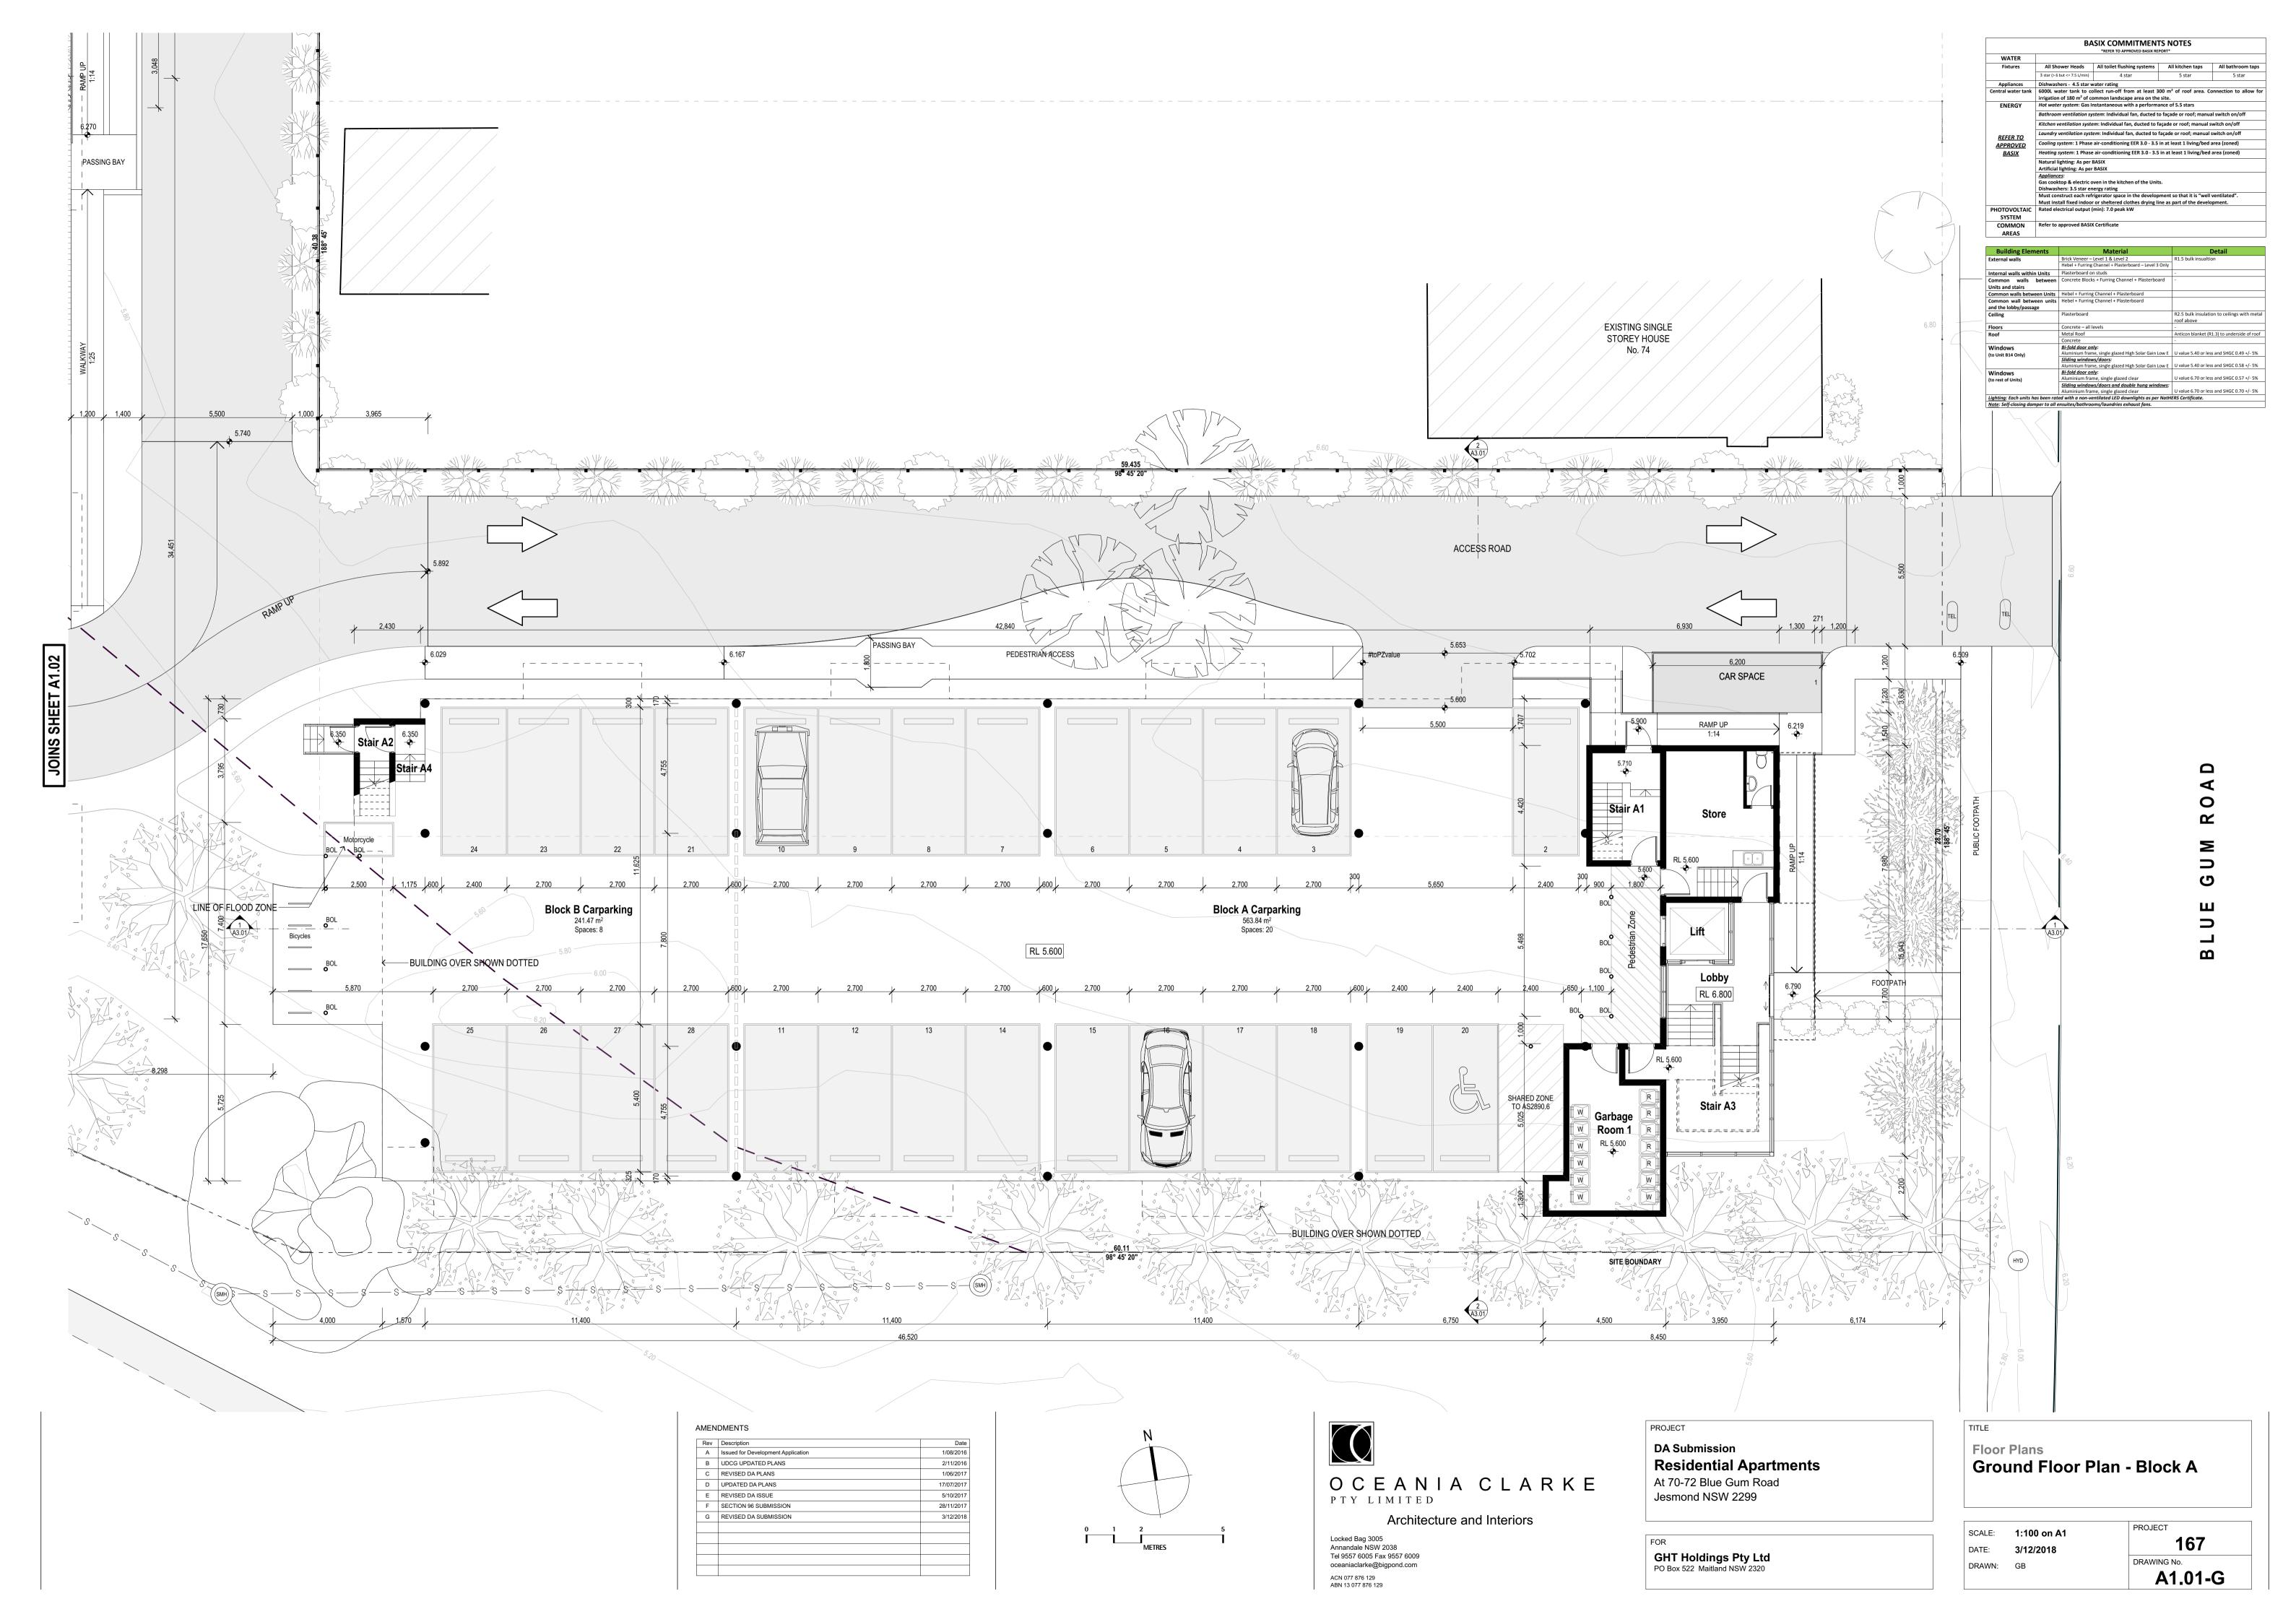


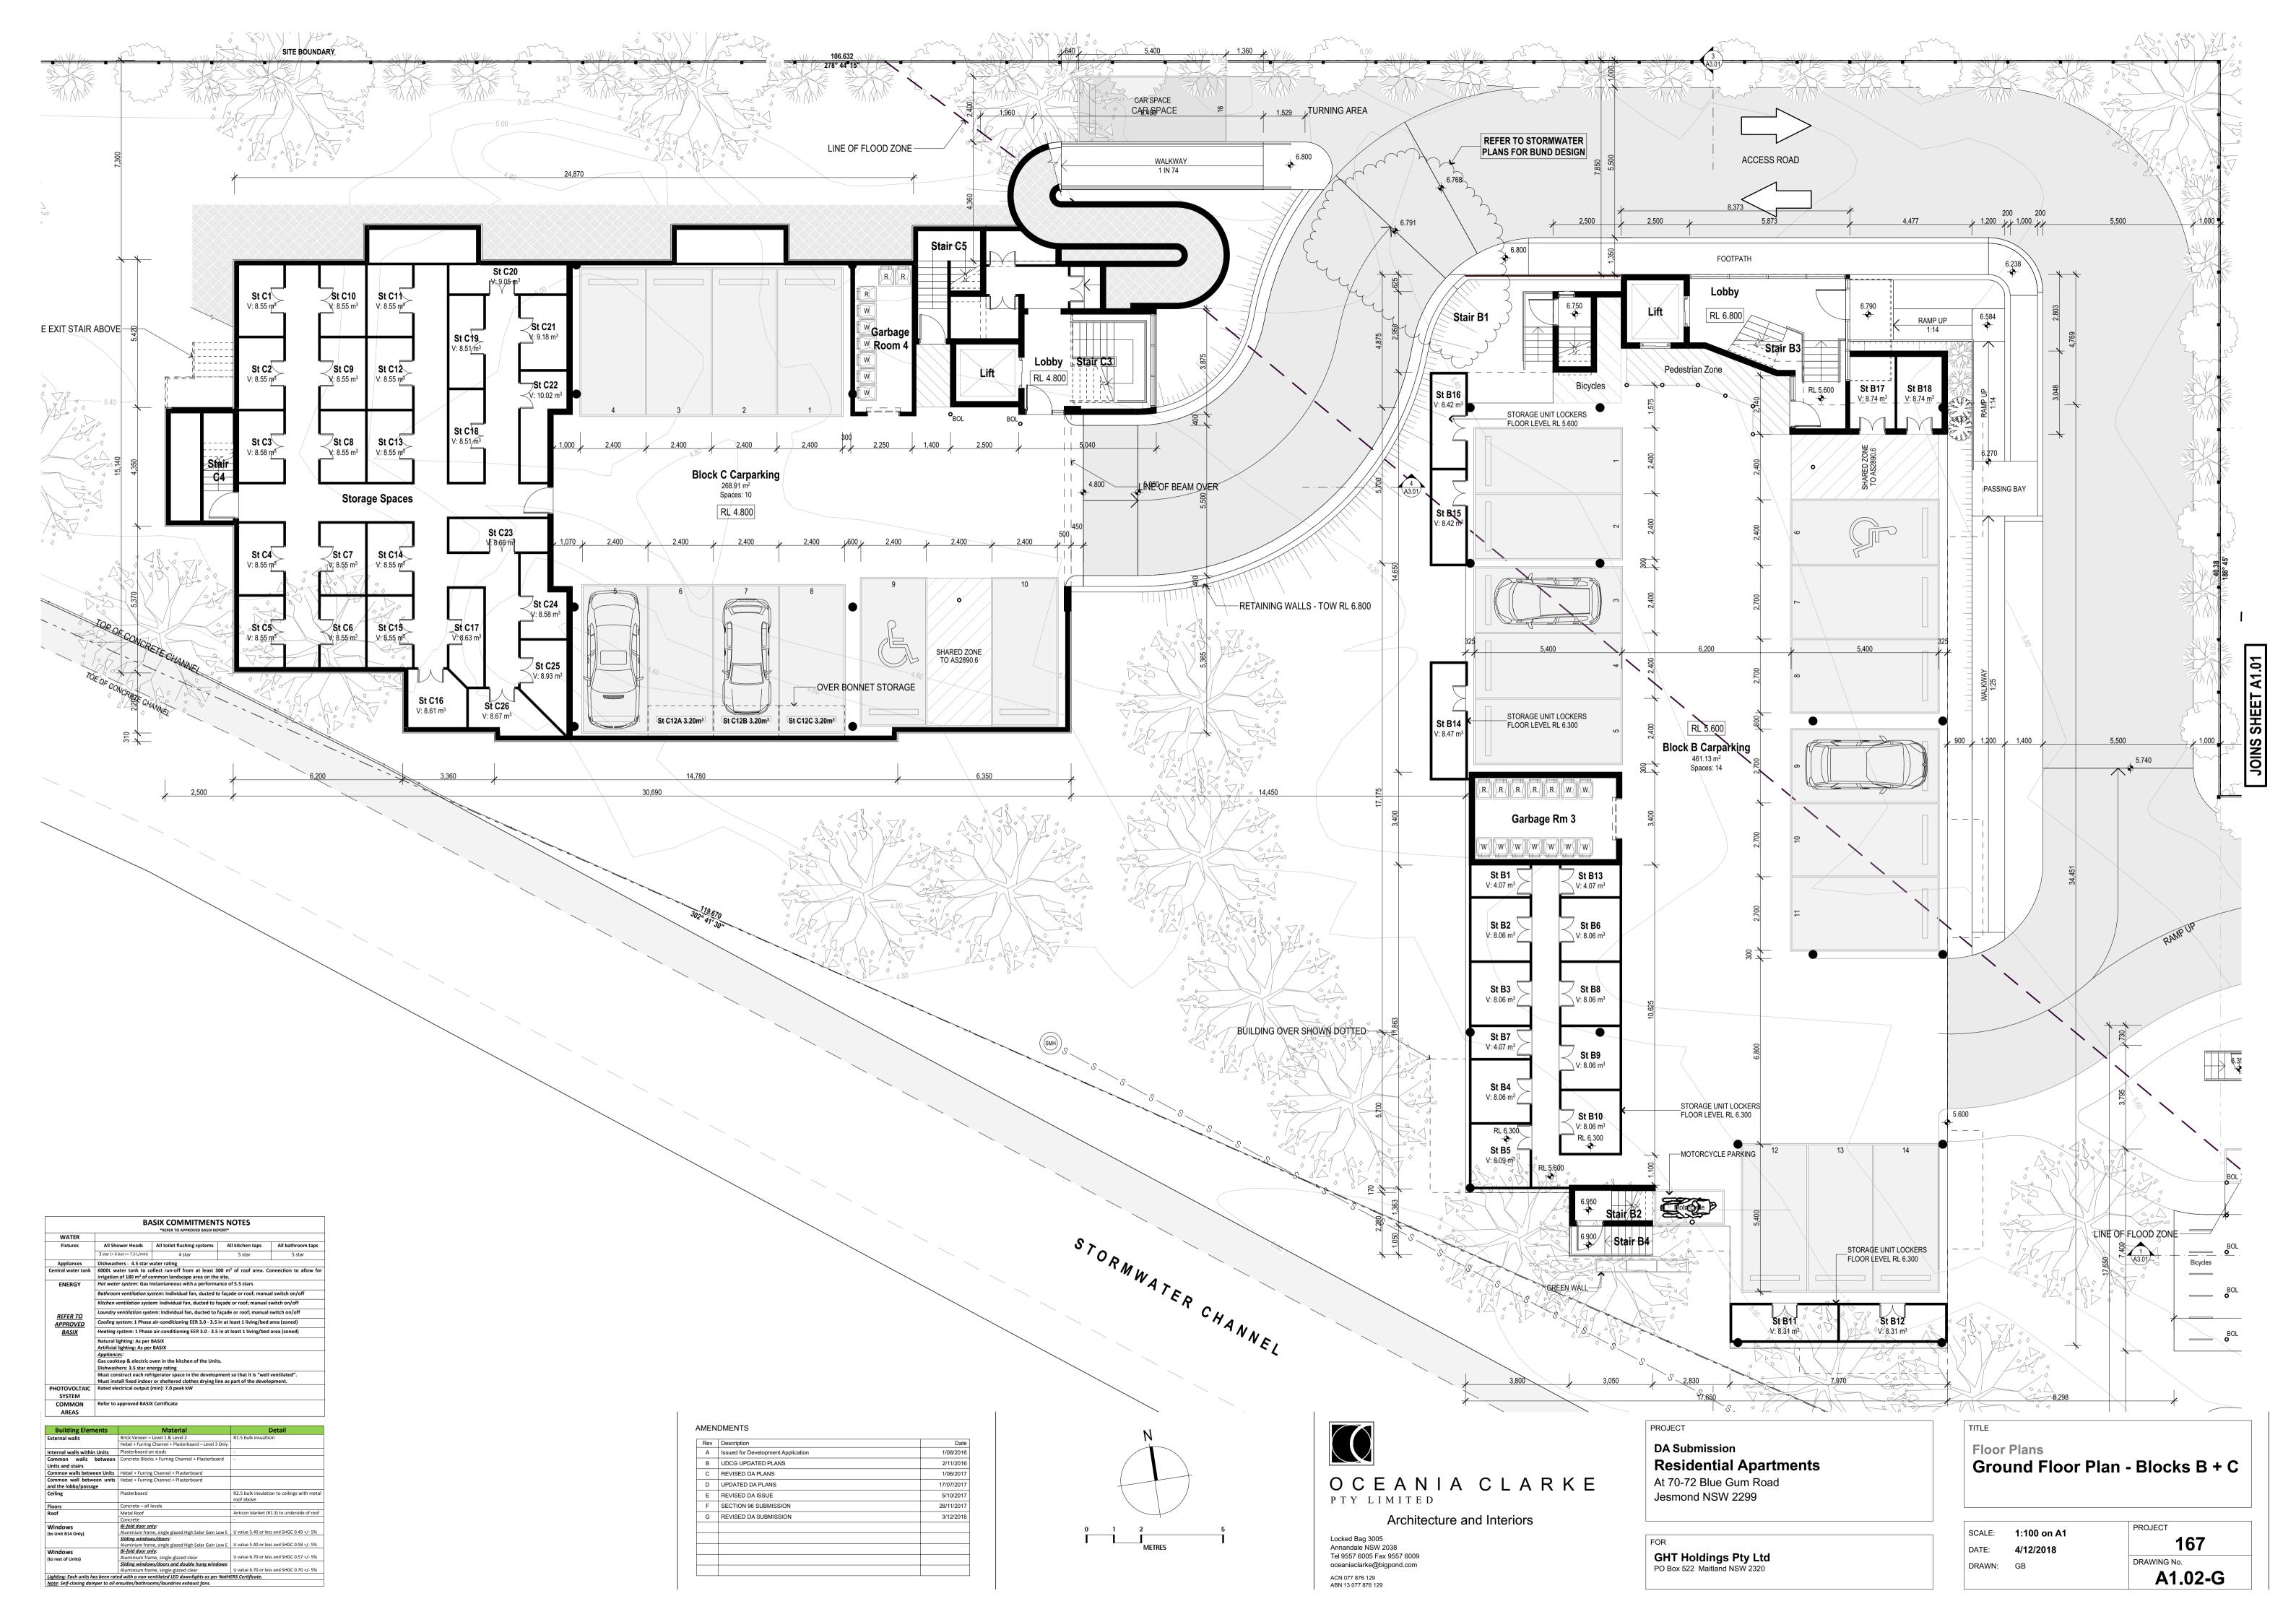


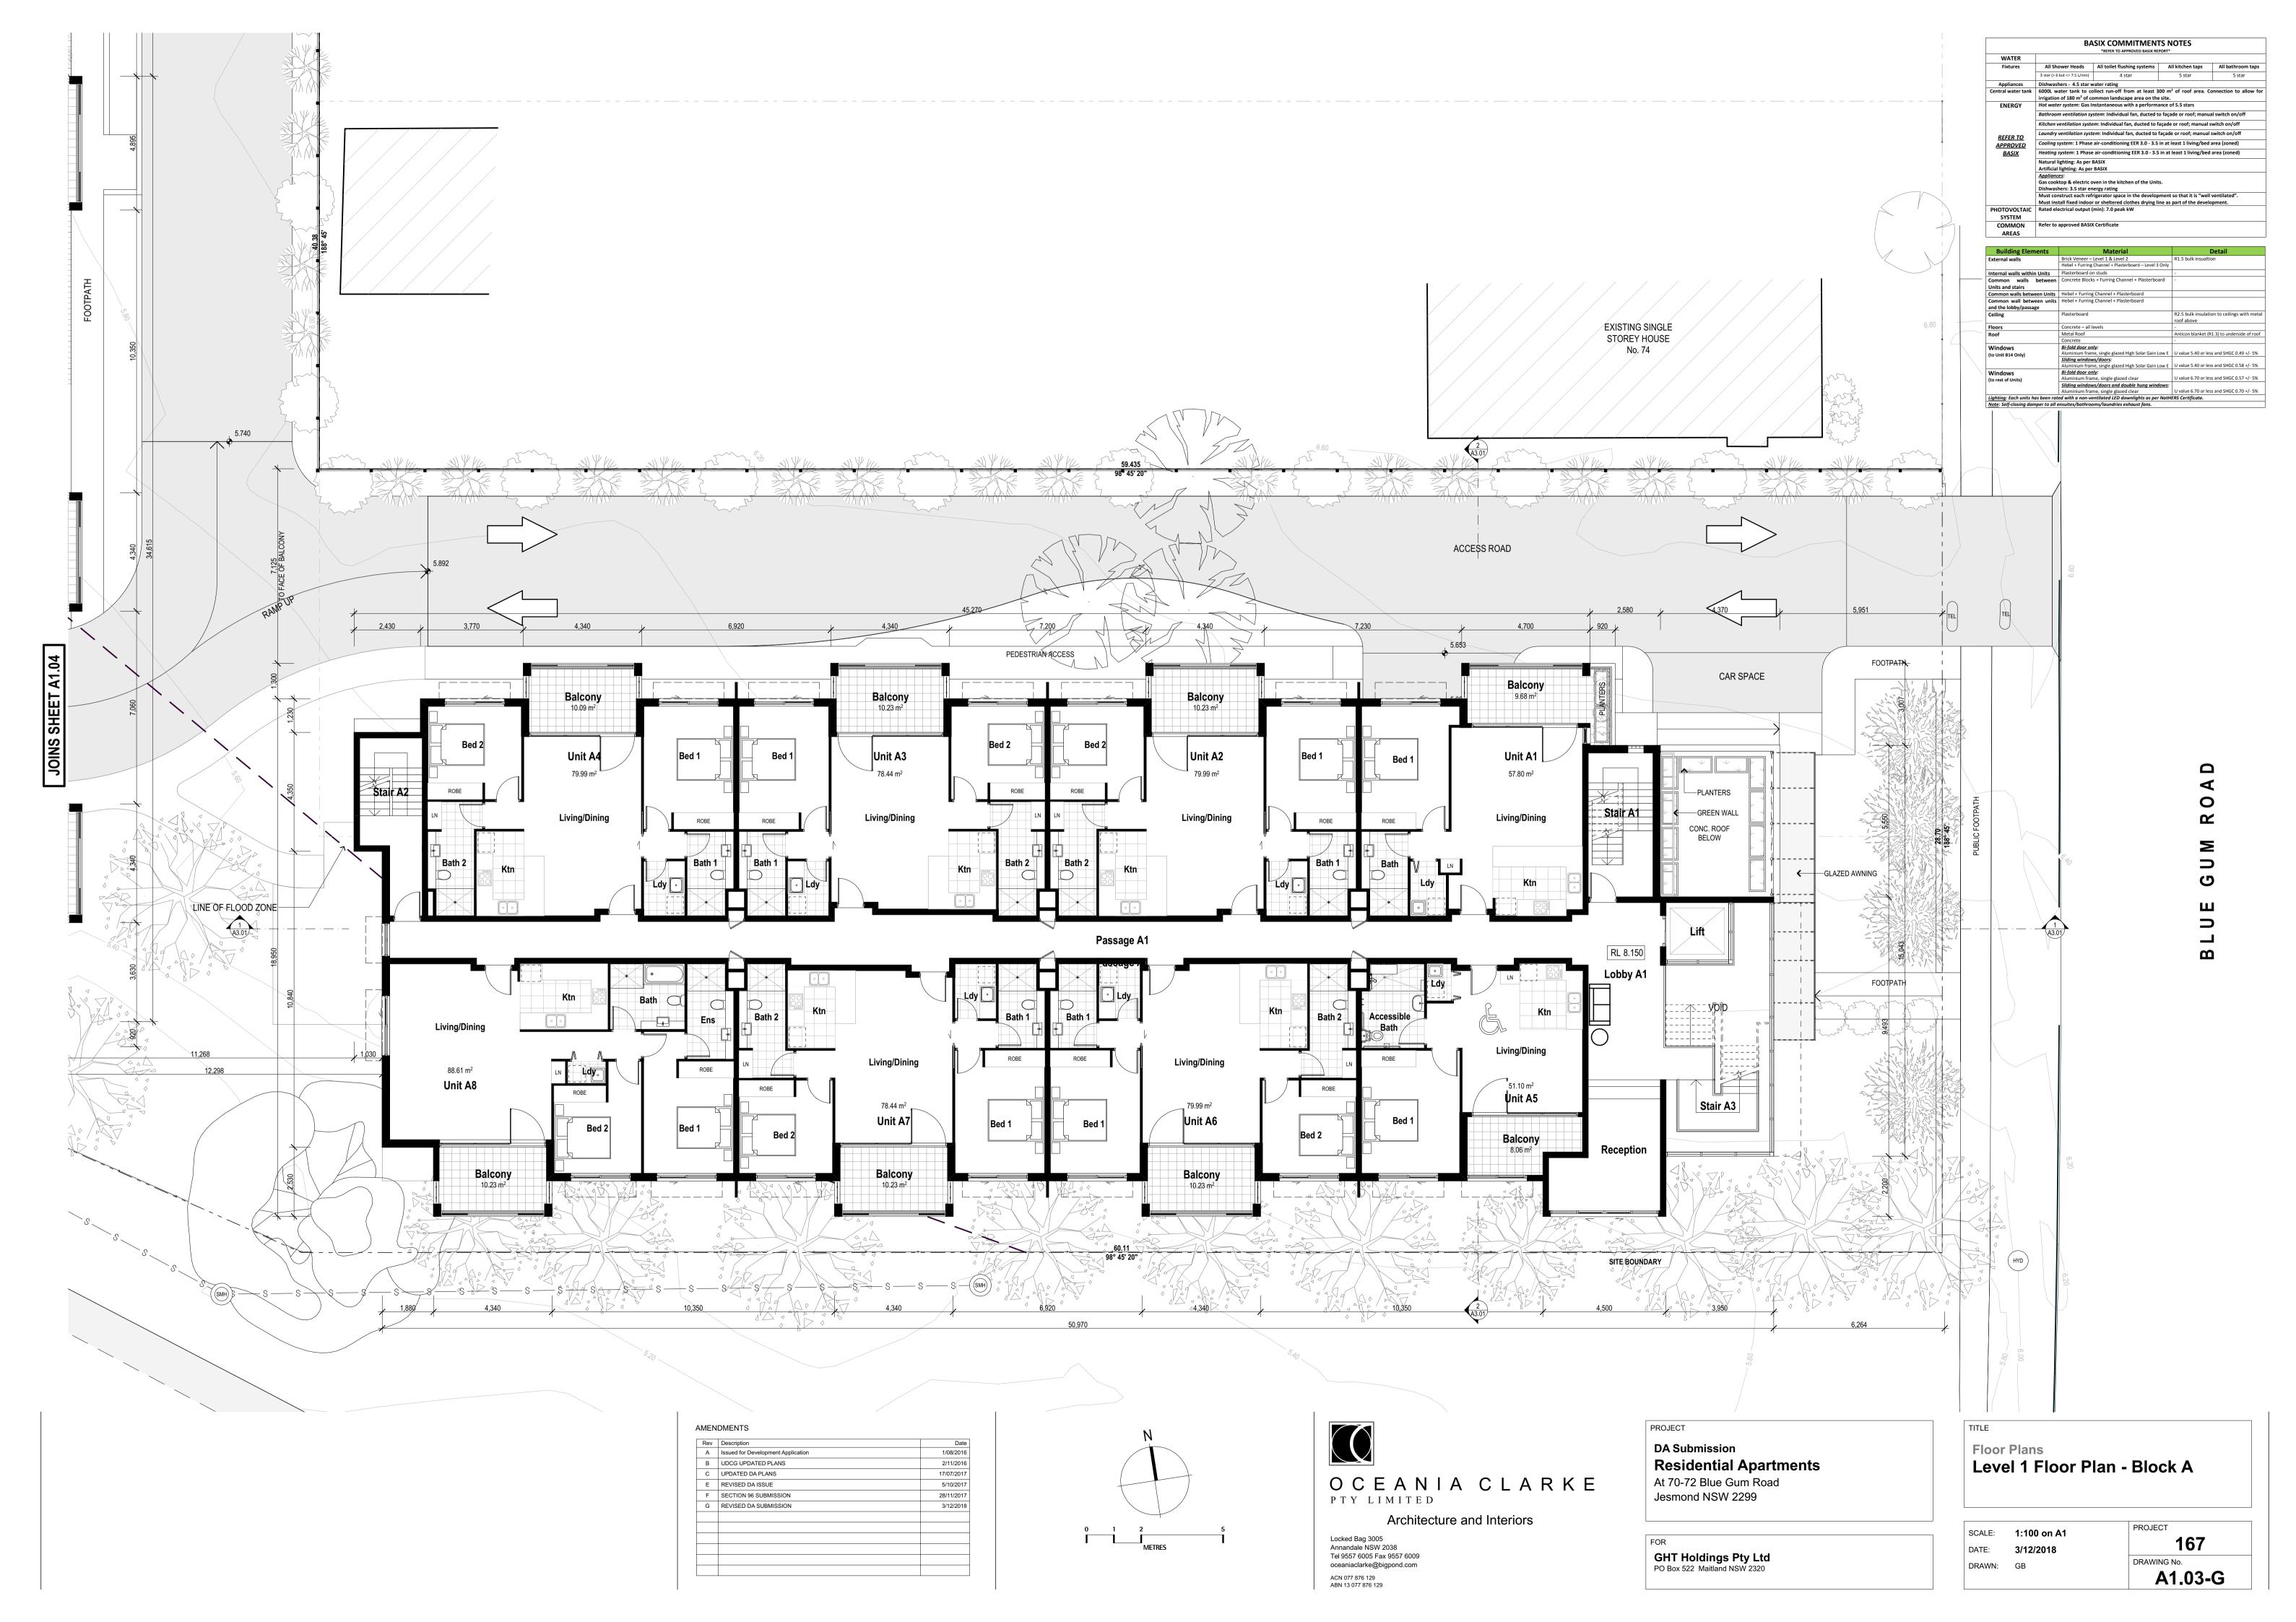

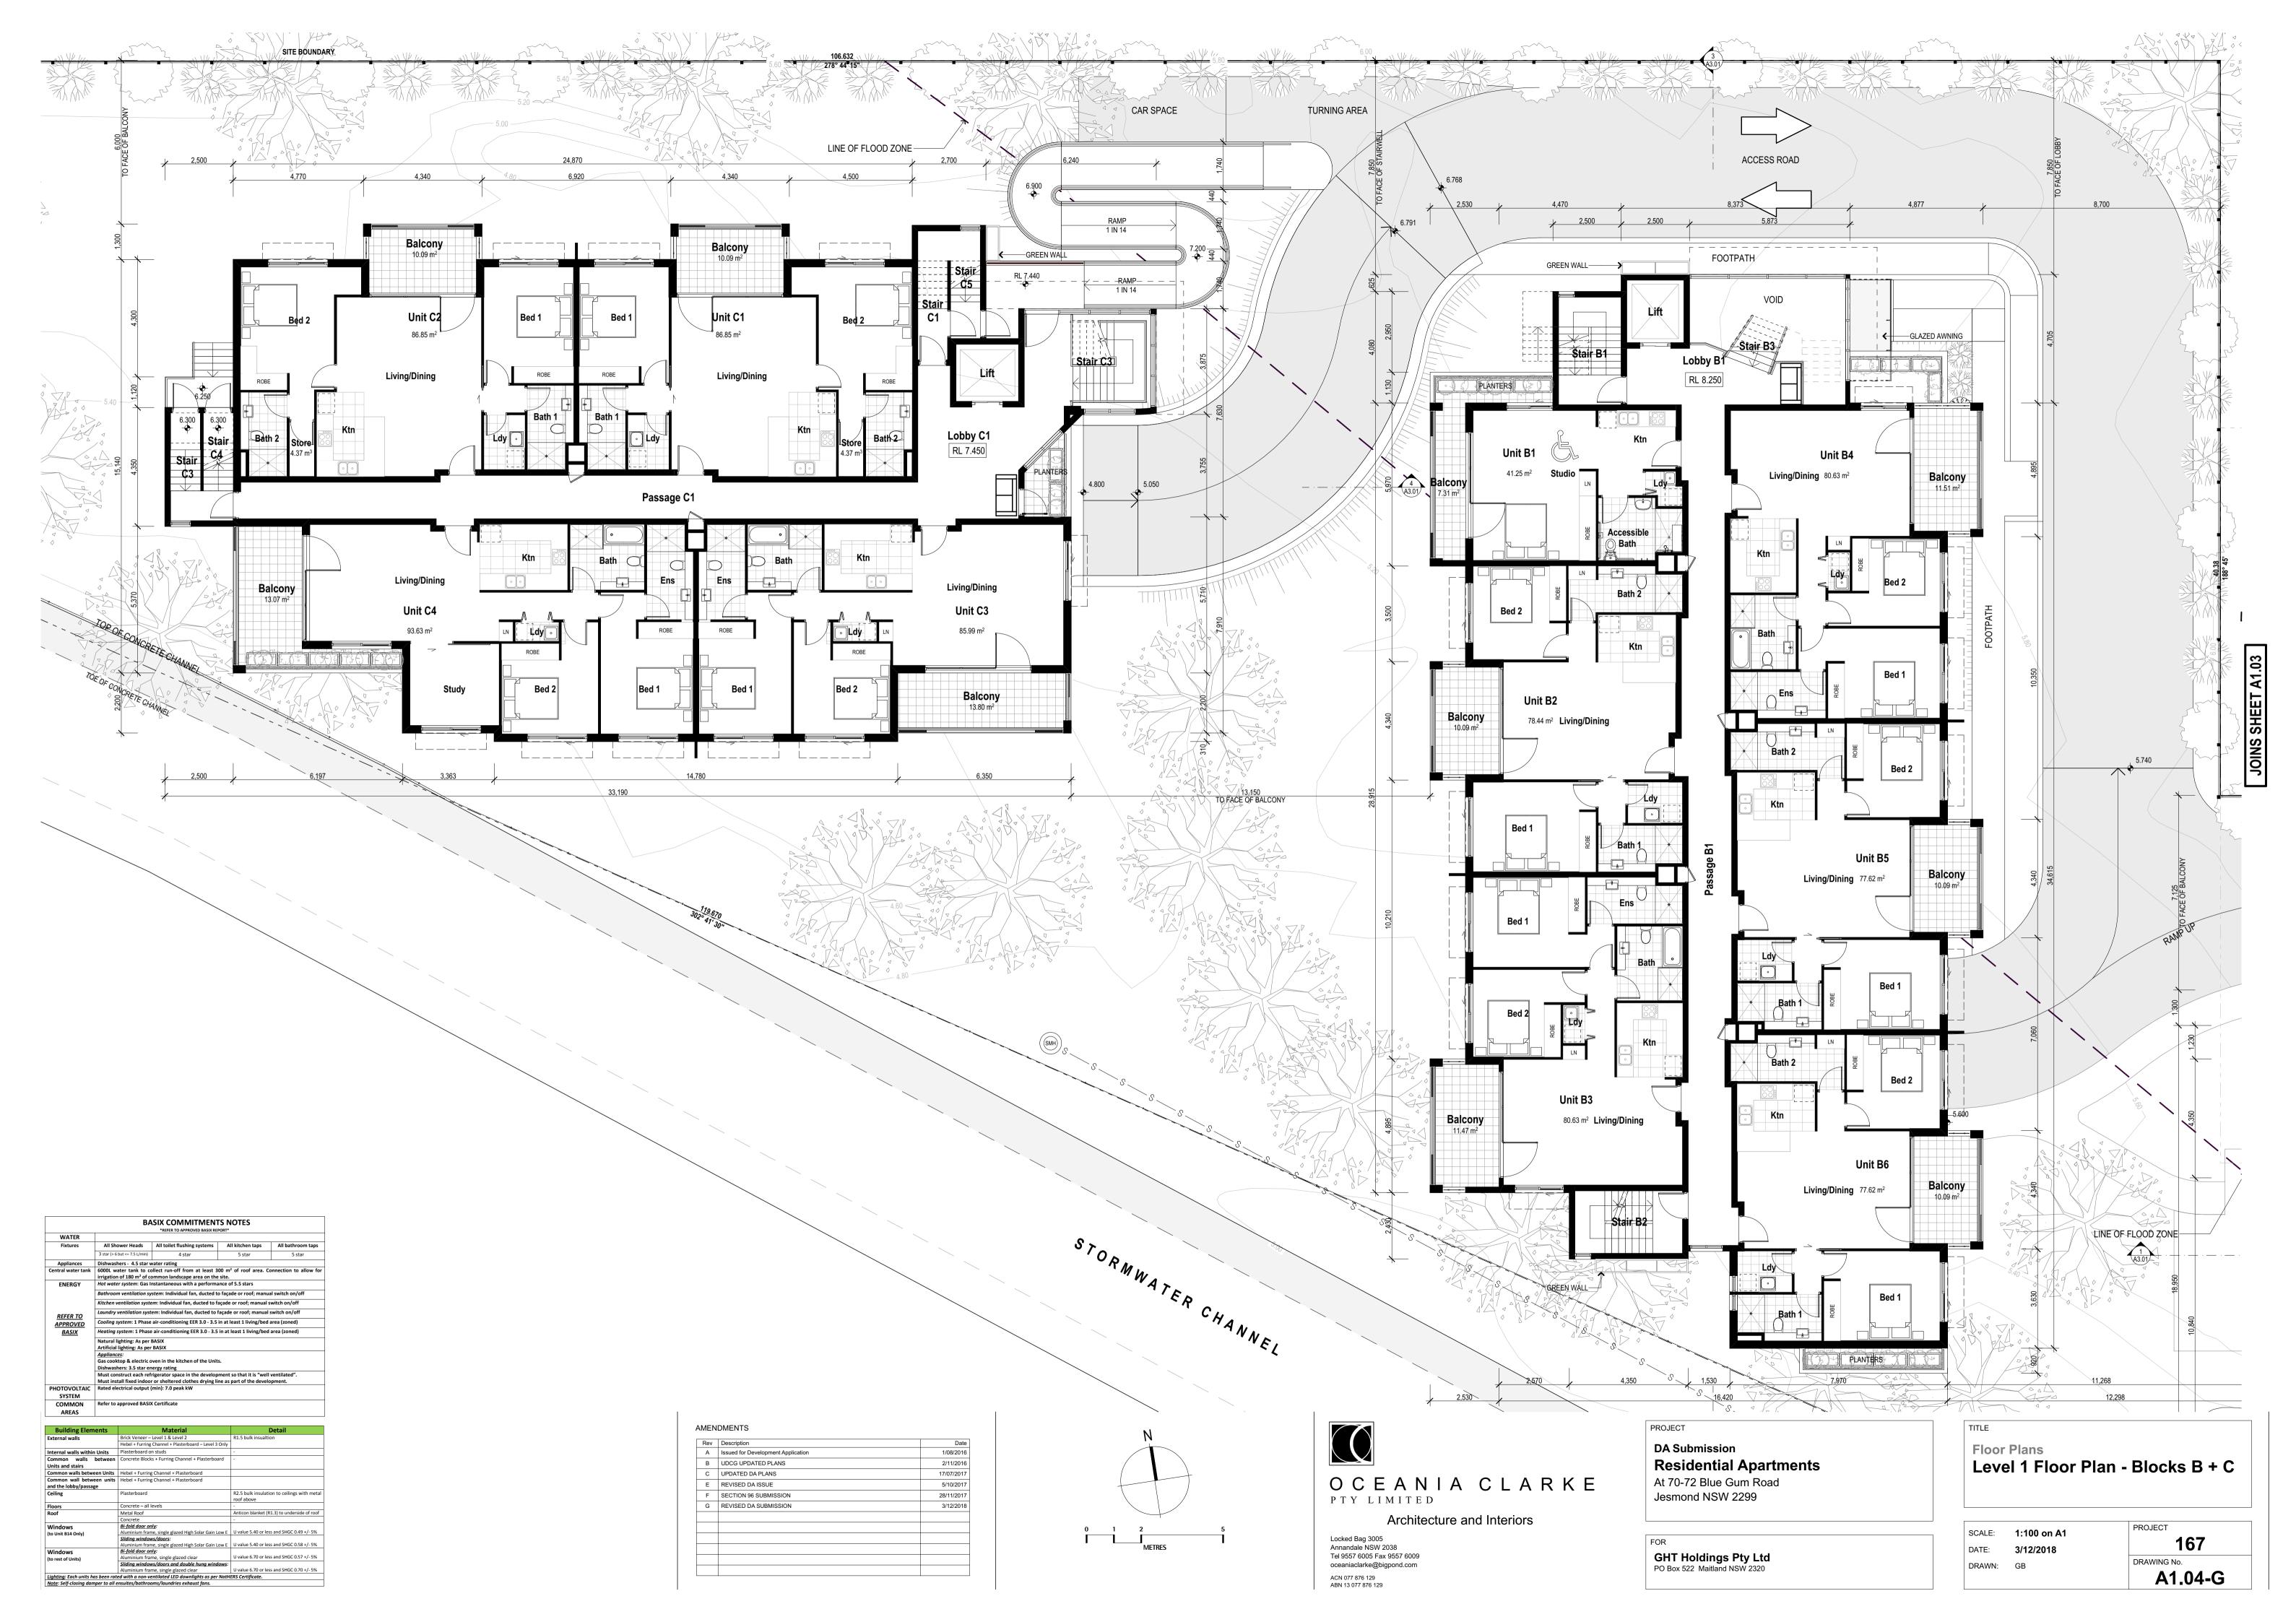

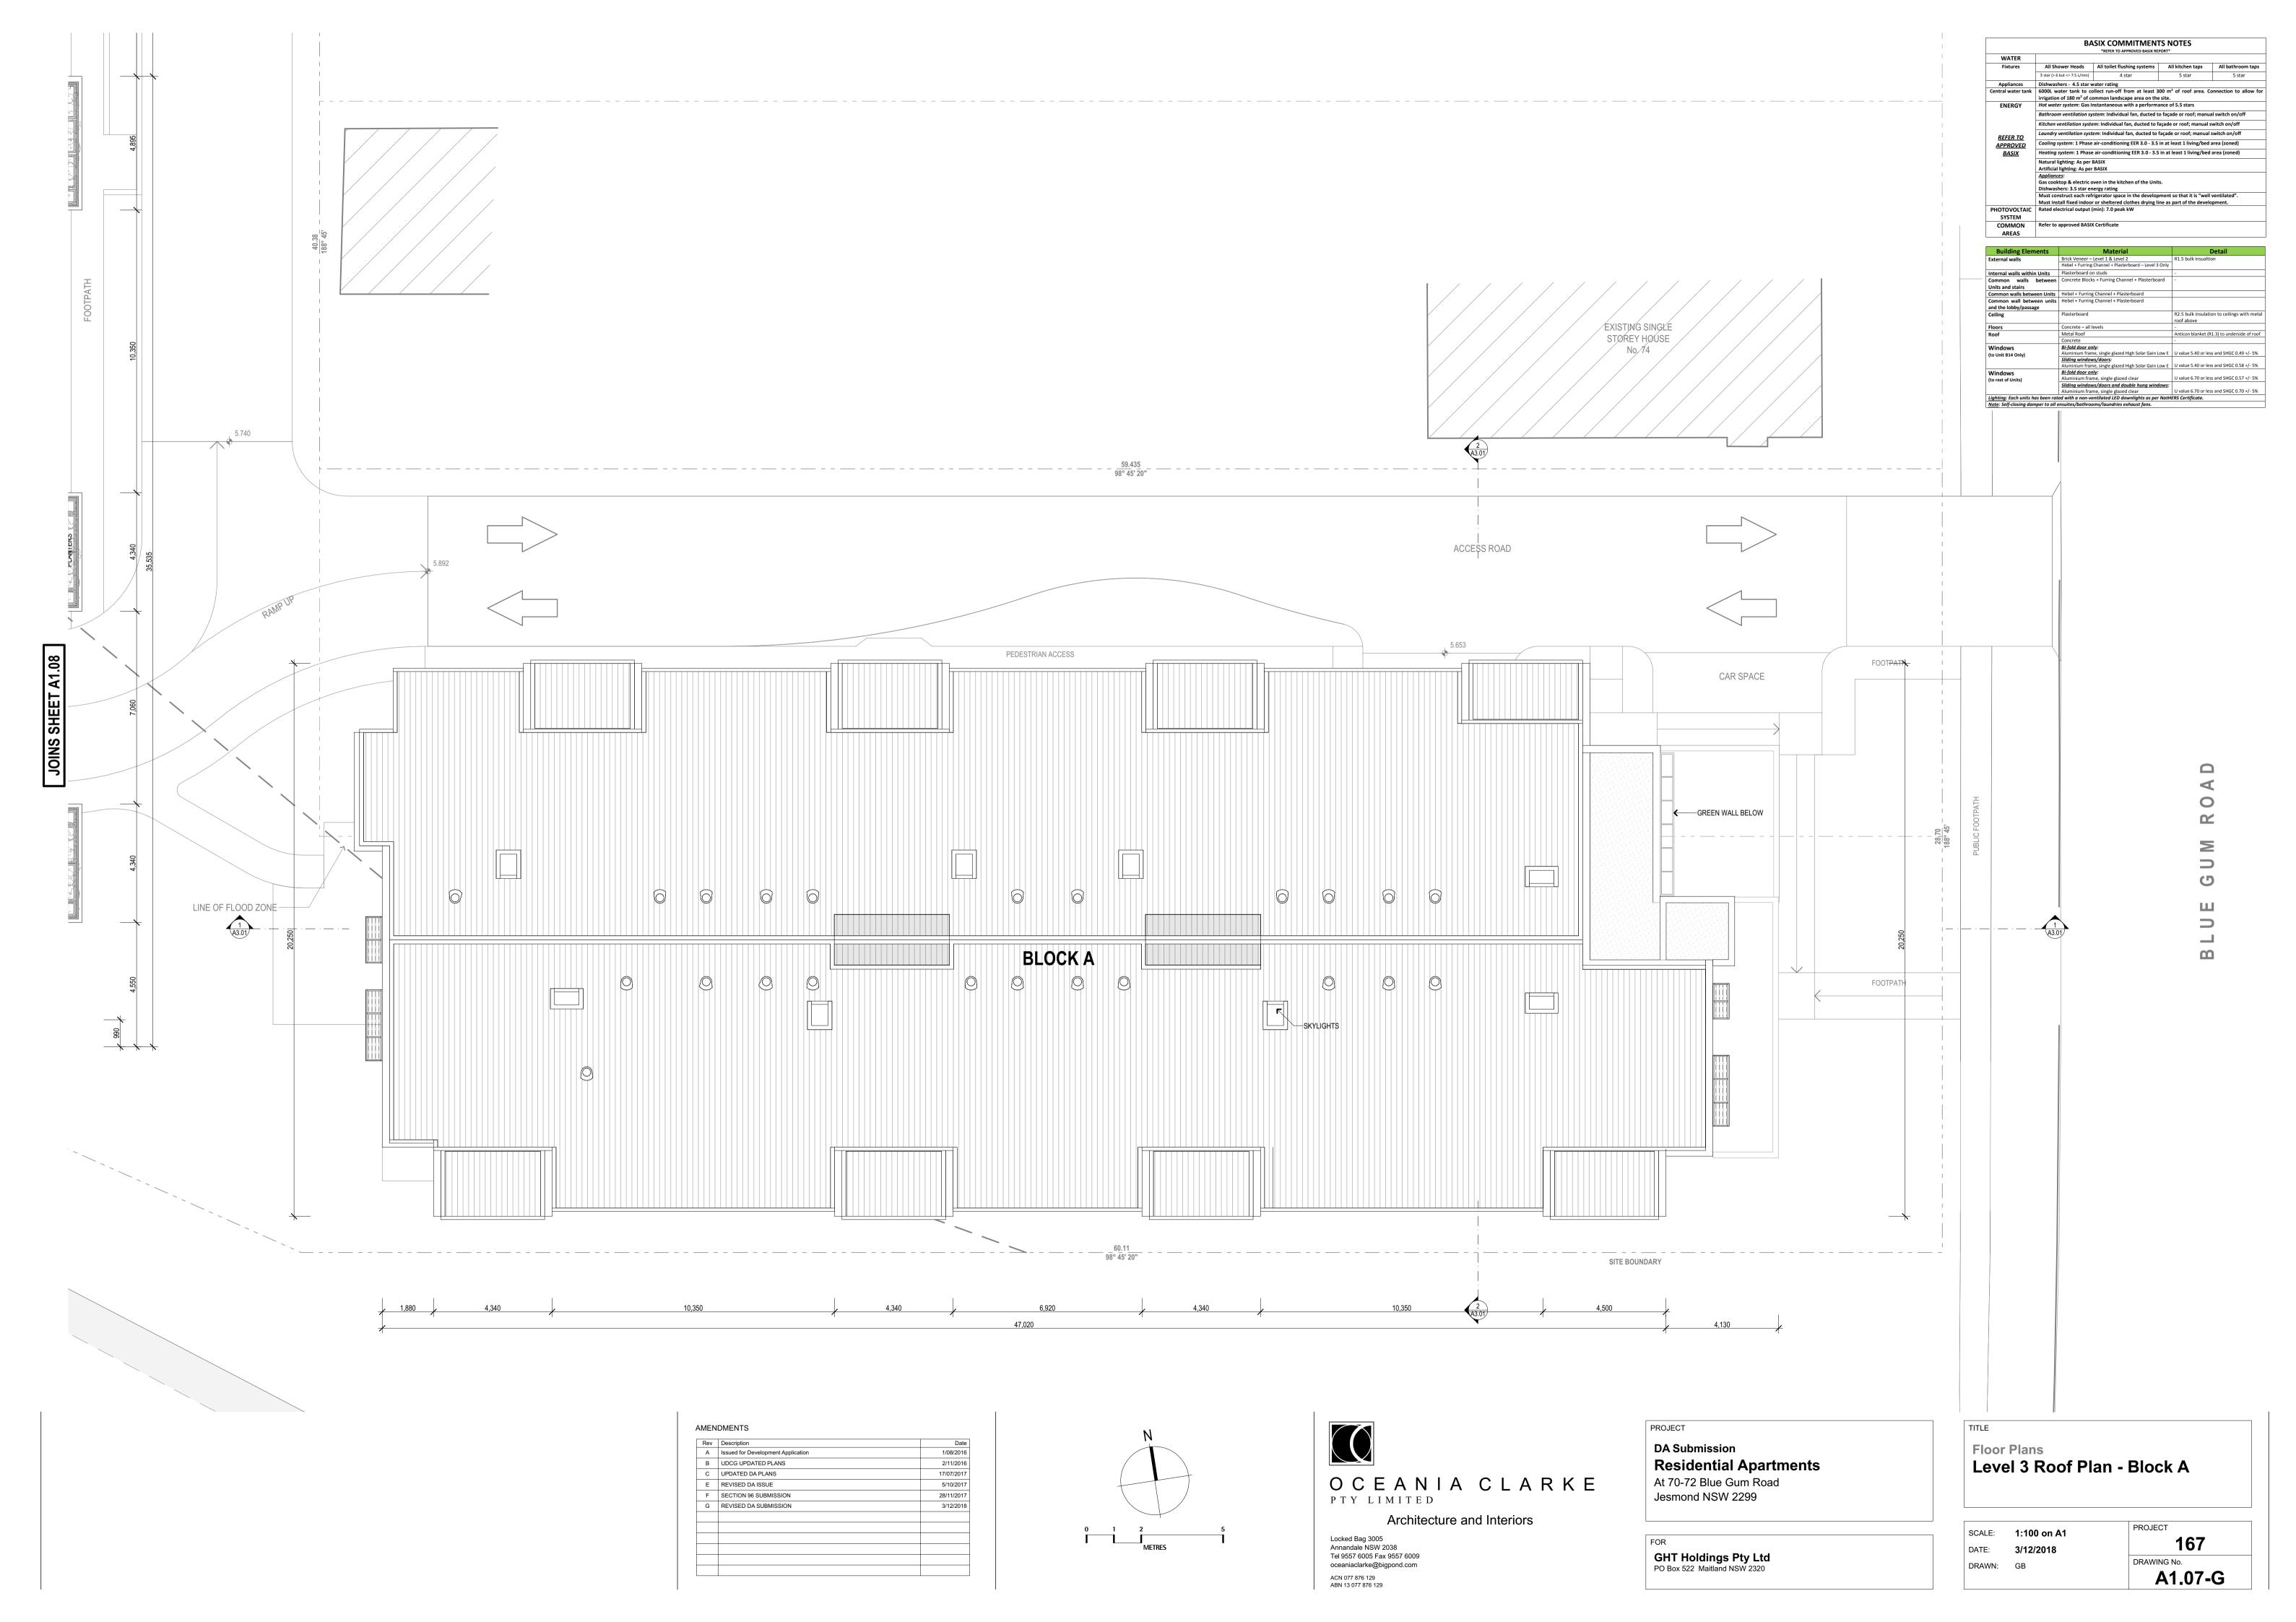

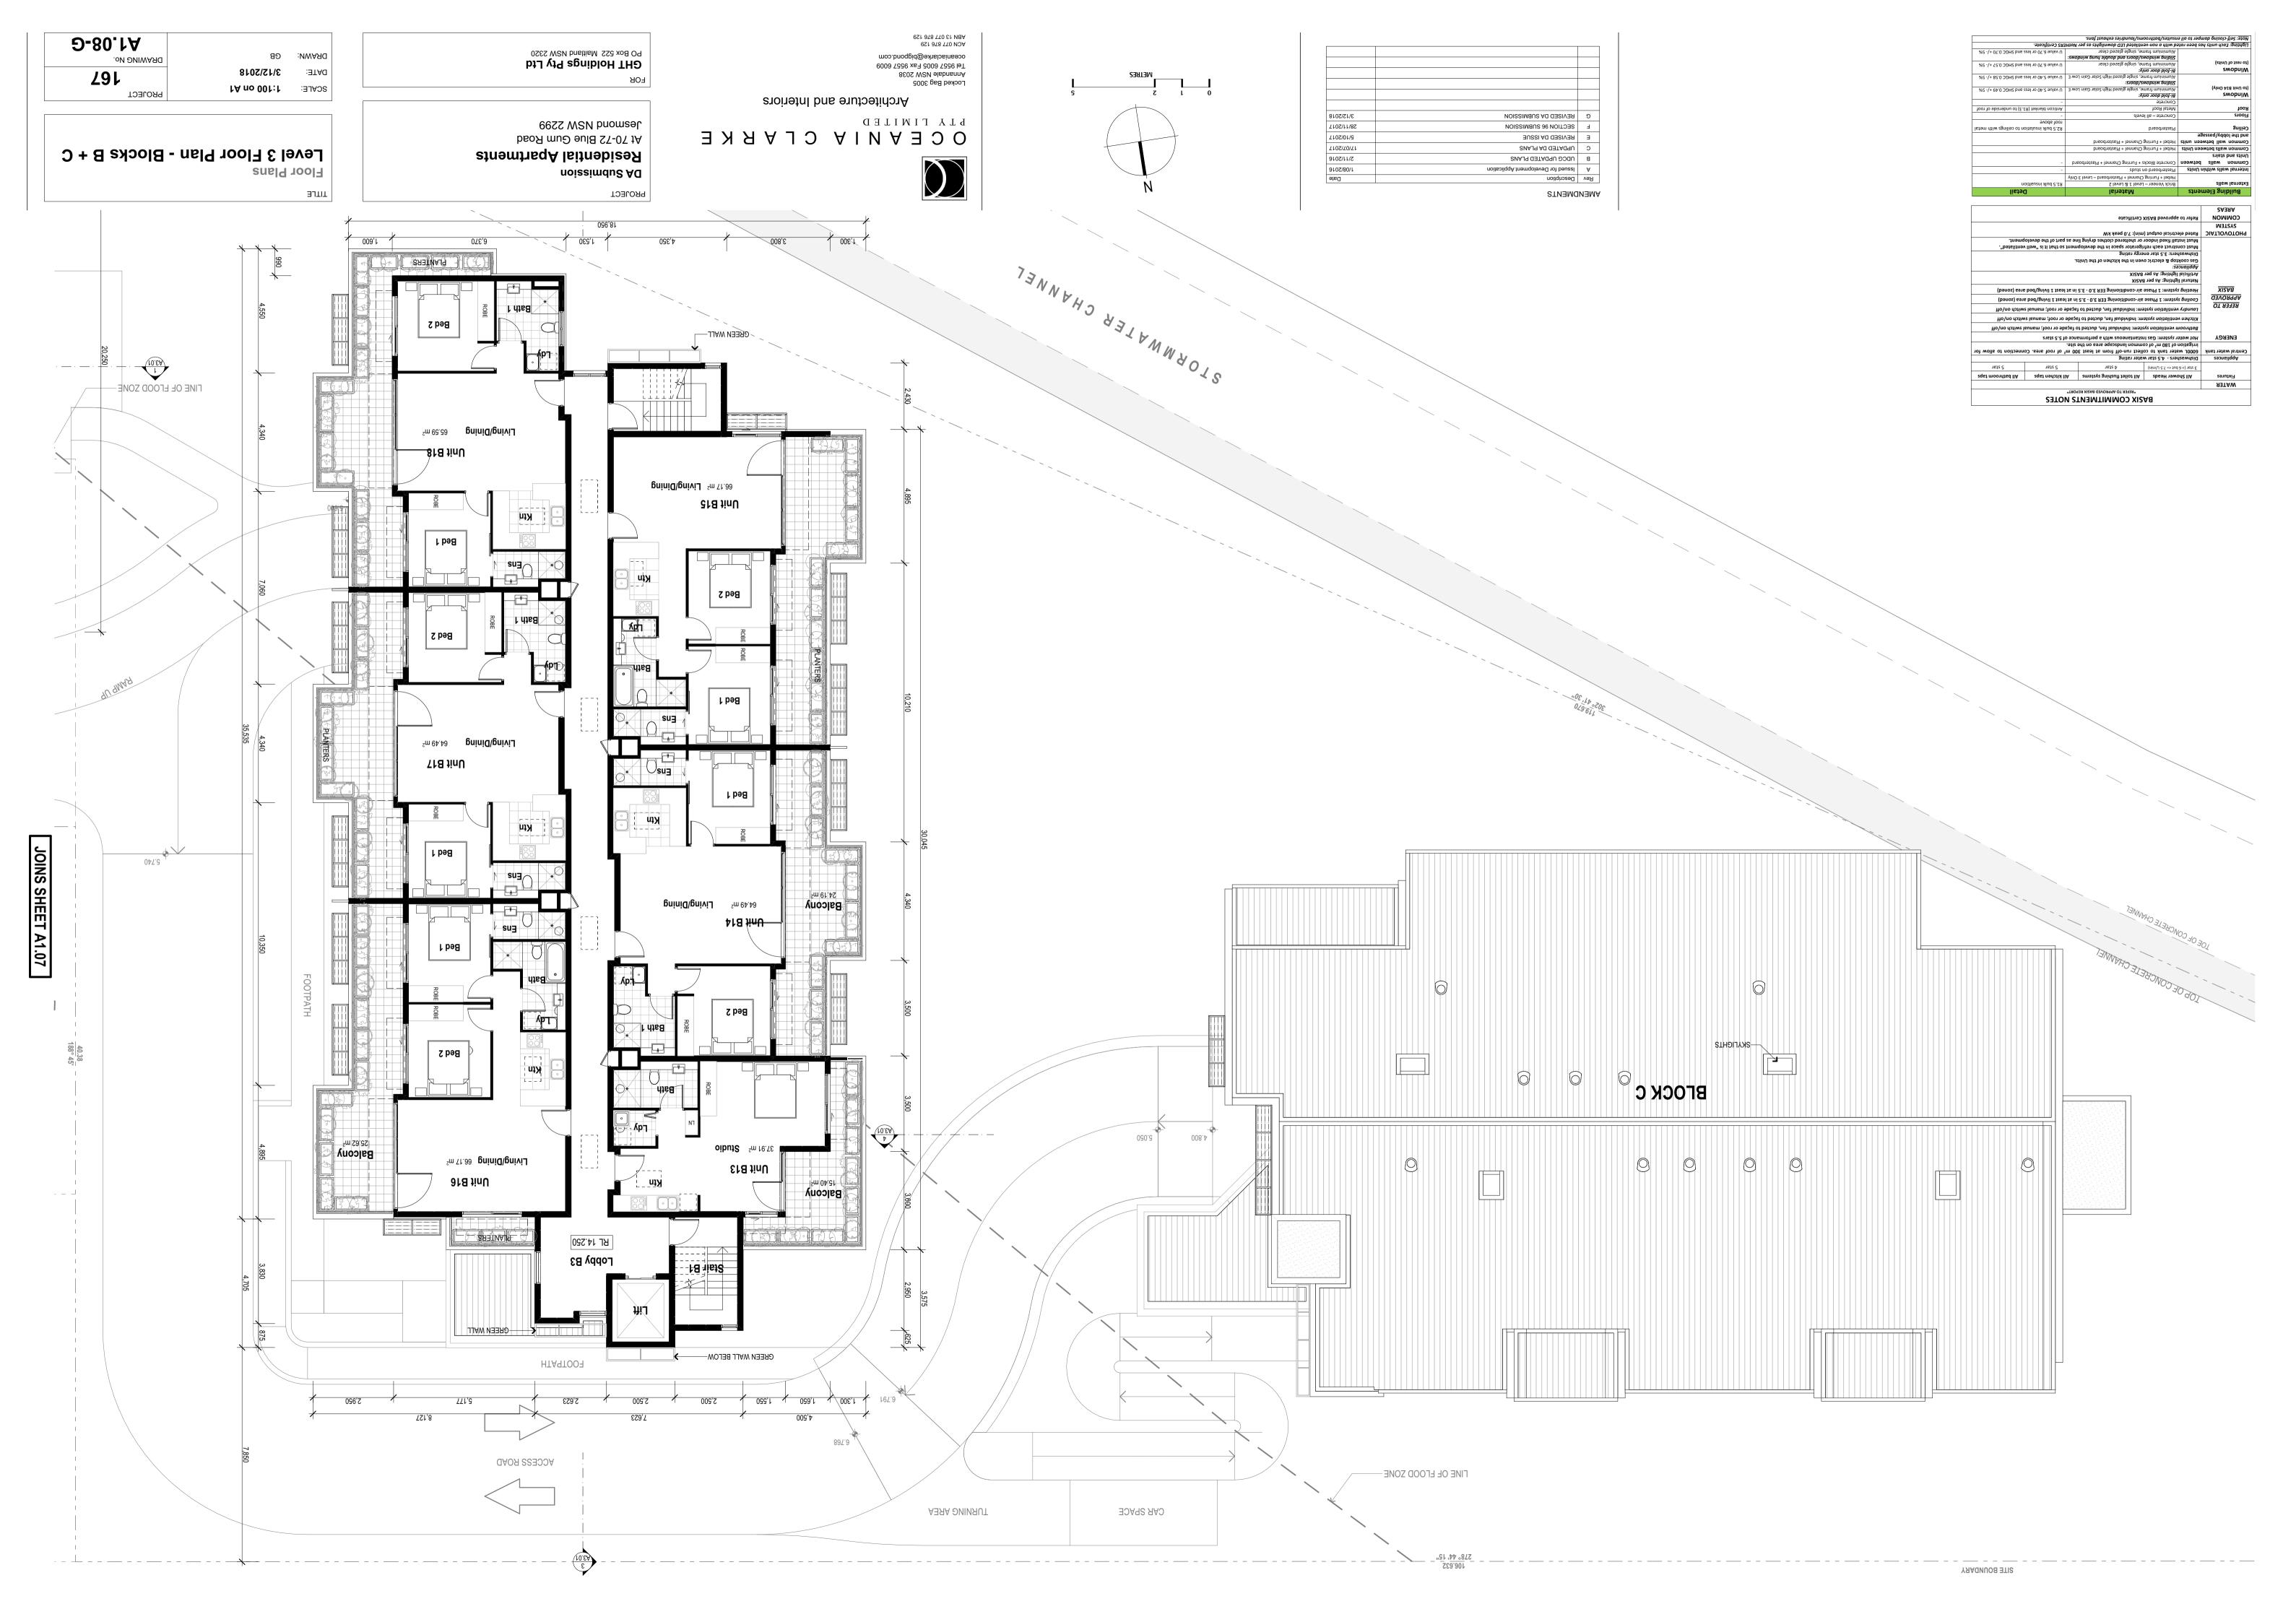


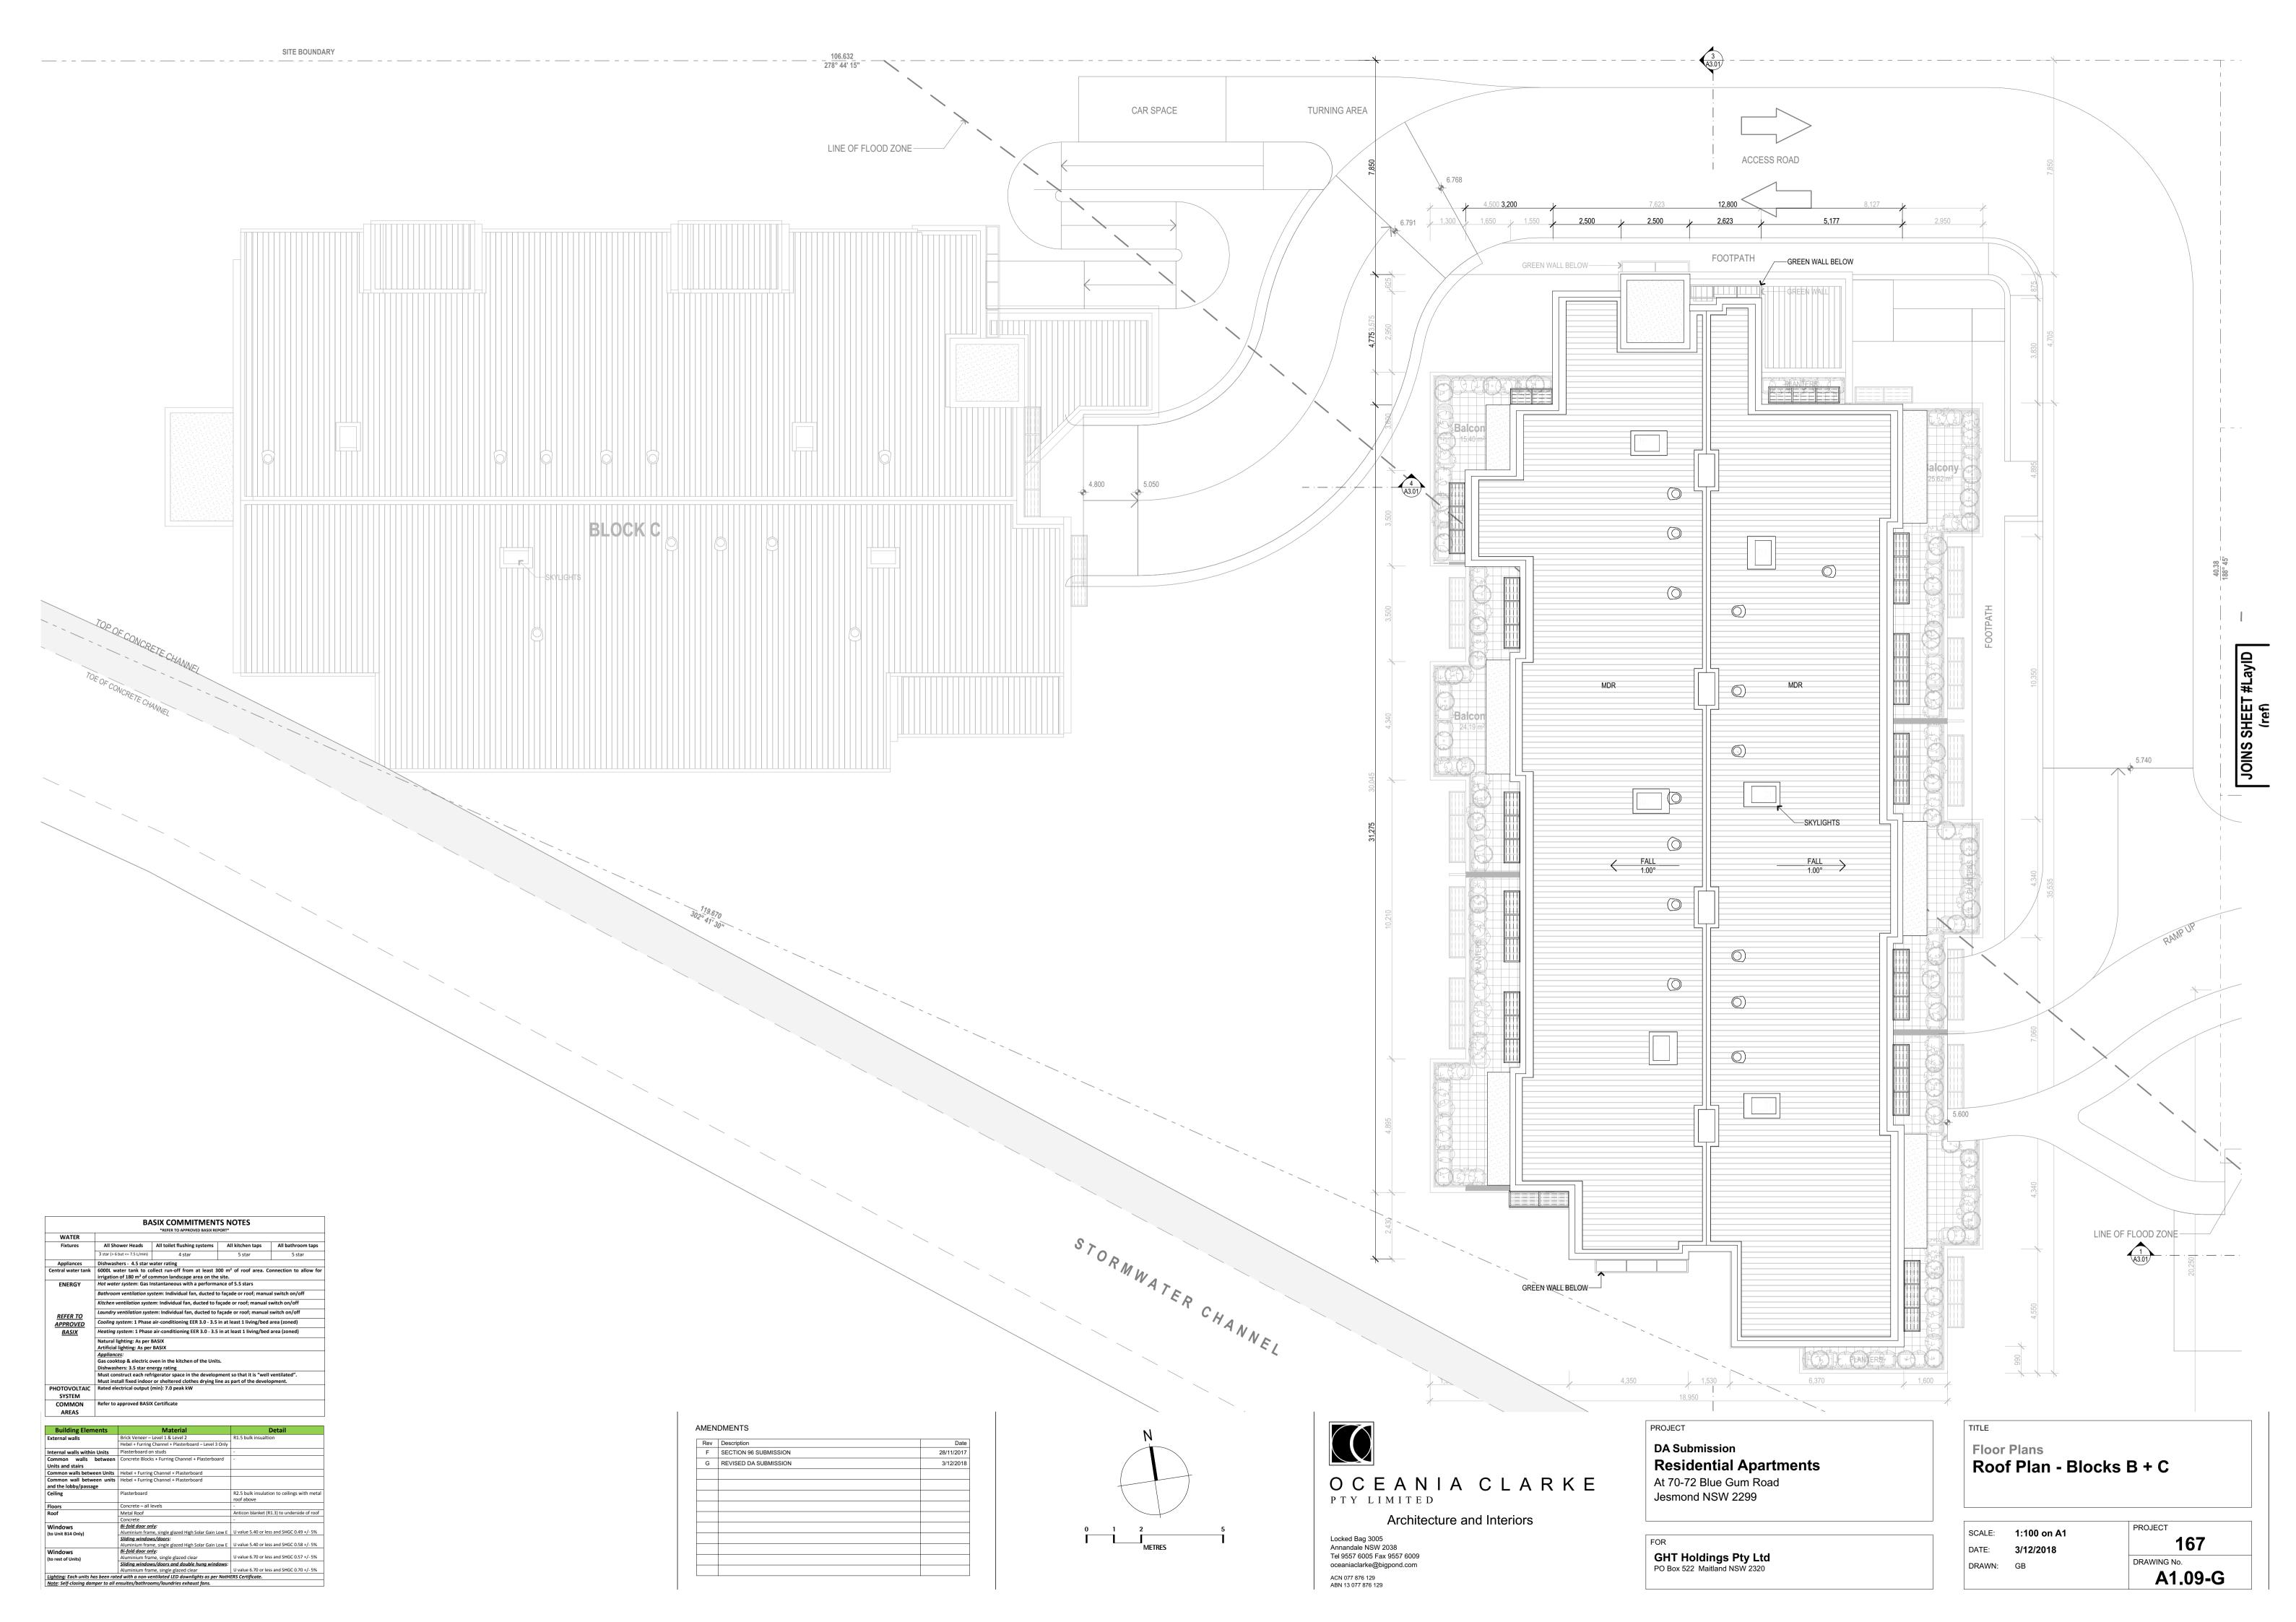



North Elevation




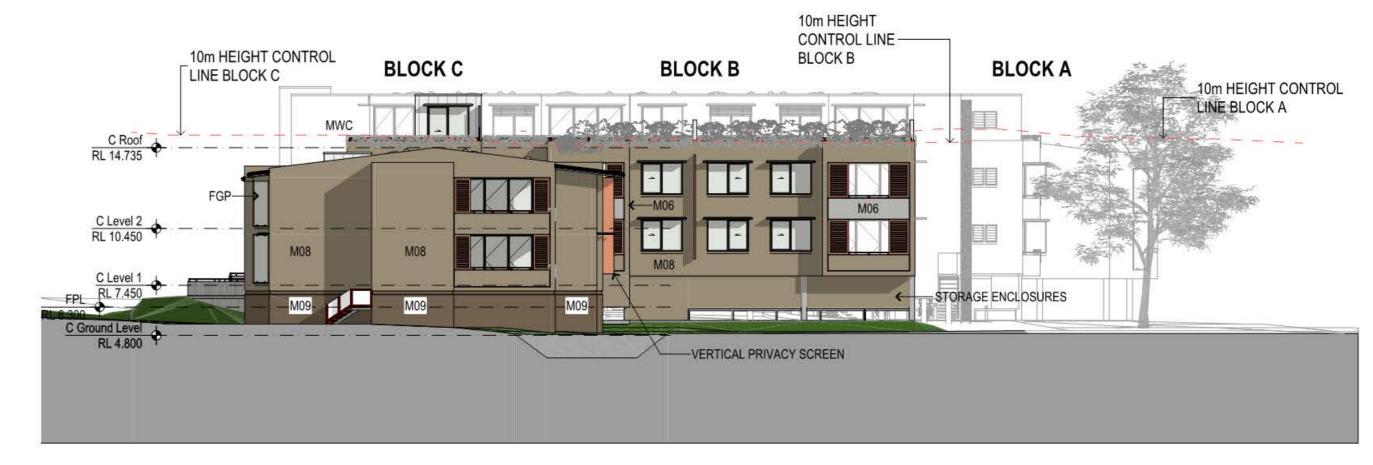



2 East Elevation 1:200 3




4	.,.				South Elevation				1:200
BASIX COMMITMENTS NOTES "REPER TO APPROVED BASIK REPORT!"	Building Elements Material External walls Brick Veneer – Level 1 & Level 2 Hebel + Furring Channel + Plasterboard	Petail R1.5 bulk insualtion Level 3 Only	AMENDMENTS		0 2.5 5 10 METRES		PROJECT	TITLE	
hower Heads All toilet flushing systems All kitchen taps All bathroom taps	Internal walls within Units Plasterboard on studs		Rev Description	Date			DA Culturiacian	g=1	
ashers - 4.5 star water rating	Common walls between Concrete Blocks + Furring Channel + P	lasterboard -	A Issued for Development Application	1/08/2016	LEGEND - ELEVATIONS		DA Submission	Elevations	
water tank to collect run-off from at least 300 m² of roof area. Connection to allow for	Common walls between Units Hebel + Furring Channel + Plasterboar	d	B UDCG UPDATED PLANS	2/11/2016	100 TO 10		Residential Apartments	Elevations	
er system: Gas Instantaneous with a performance of 5.5 stars	Common wall between units Hebel + Furring Channel + Plasterboar	rd .	C UPDATED DA PLANS	17/07/2017	<u>Elements</u>			Lievations	
om ventifation system: Individual fan, ducted to façade or roof; manual switch on/off	and the lobby/passage Plasterhoard	R2.5 bulk insulation to ceilings with metal	E REVISED DA ISSUE	5/10/2017	BAL Balustrade FGP Fixed glass panel LVS Louvre shutters (sliding) - aluminium MDR Metal deck roofing - Colorbond 'Shale Grey' MWC Metal wall cladding - zinc panels	OCEANIA CLARKE	At 70-72 Blue Gum Road		
ventilation system: Individual fan, ducted to façade or roof; manual switch on/off y ventilation system: Individual fan, ducted to façade or roof; manual switch on/off	Cennig	roof above	F SECTION 96 SUBMISSION	28/11/2017	LVS Louvre shutters (sliding) - aluminium		Jesmond NSW 2299		
g system: 1 Phase air-conditioning EER 3.0 - 3.5 in at least 1 living/bed area (zoned)	Floors Concrete – all levels Roof Metal Roof	Anticon blanket (R1.3) to underside of roof	G REVISED DA SUBMISSION	3/12/2018	MDR Metal deck roofing - Colorbond 'Shale Grey'	PTY LIMITED	Jesmond NSVV 2299		
a year of the control	Roof Wetal Roof	Anticon blanket (K1.5) to underside of root	G NEVIGED DA SODMISSION	3122010	MWC Metal wall cladding - zinc panels	21 2 6 2 2 2 2 2		5	
						Architecture and Interiors	Ç.		PROJECT
						The Printer Control of		SCALE: 1:200 on A1	PROJECT
						Locked Bag 3005 Annandale NSW 2038	FOR	Separation Co. Constitution of the Constitutio	1 10
						Tel 9557 6005 Fax 9557 6009	CUT Ualdiana Declad	DATE: 3/12/2018	,E**
							GHT Holdings Pty Ltd	DDAMNI. CD	DRAWING No.
						oceaniaclarke@bigpond.com	GHT Holdings Pty Ltd PO Box 522 Maitland NSW 2320	DRAWN: GB	DIV
						ACN 077 876 129 ABN 13 077 876 129			A2.

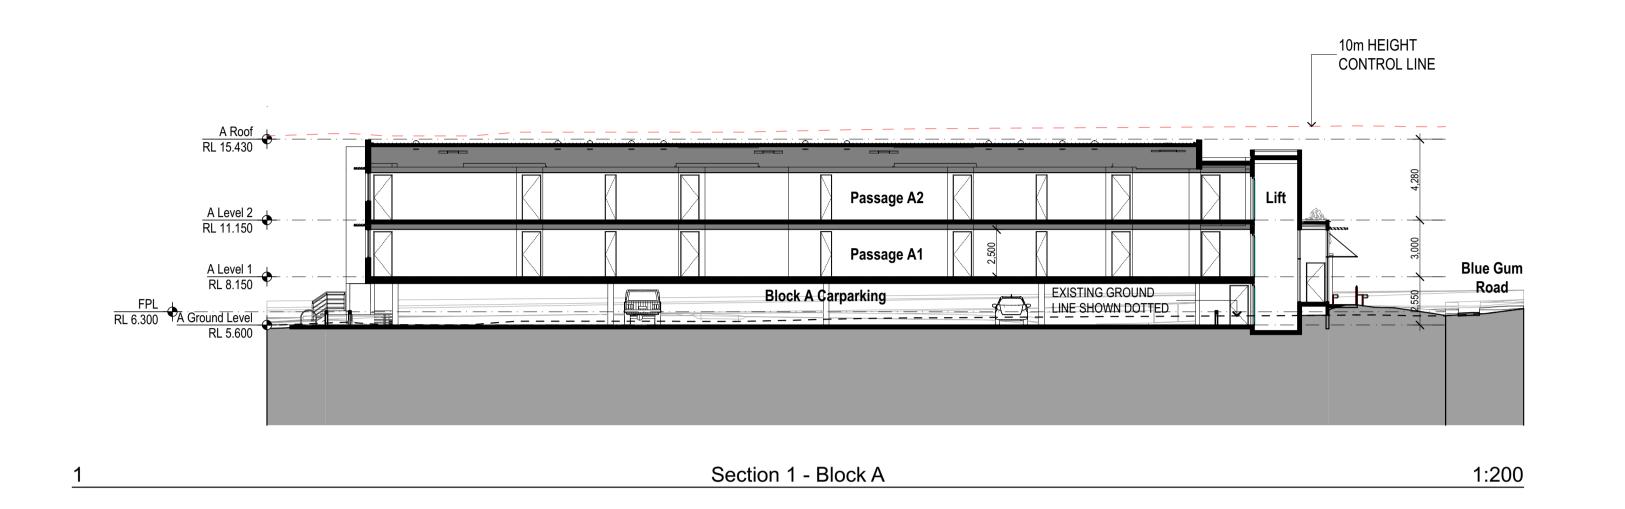


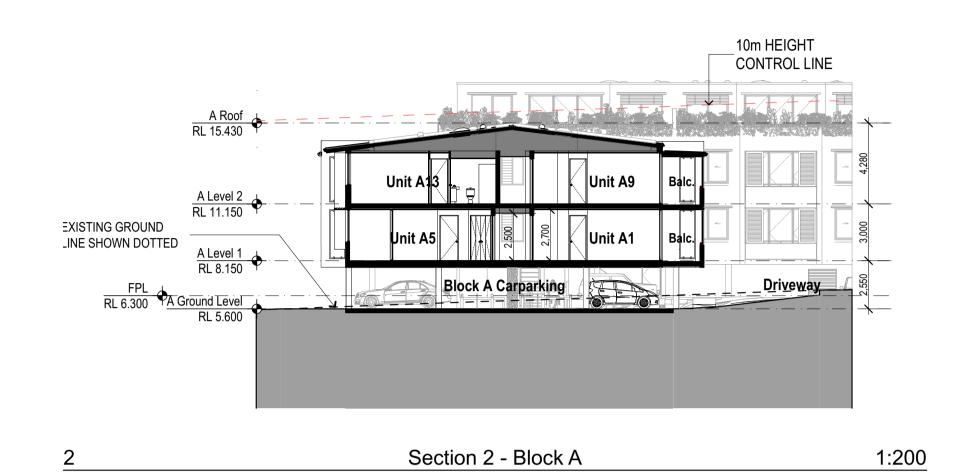


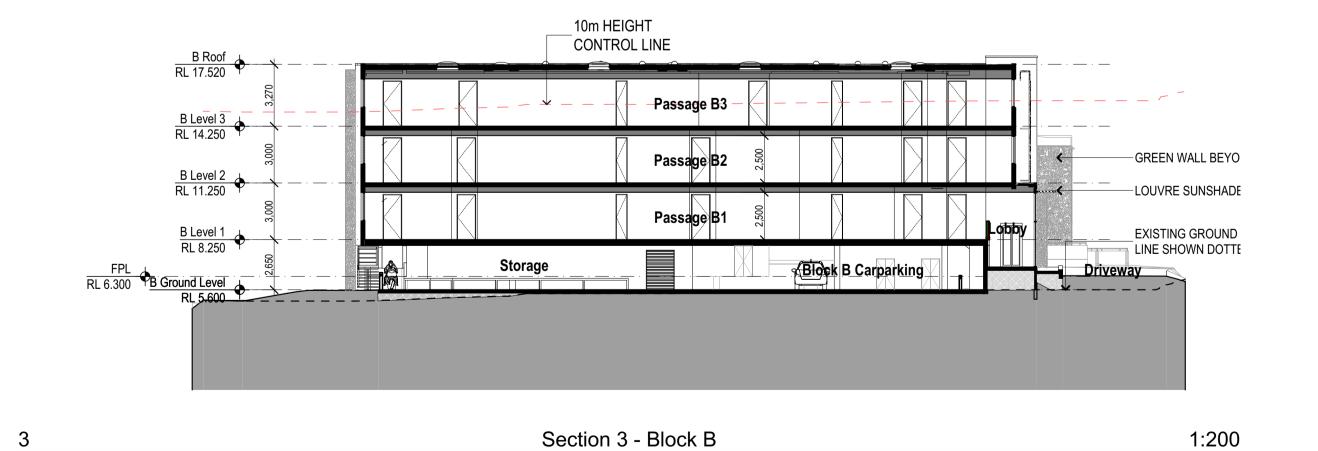

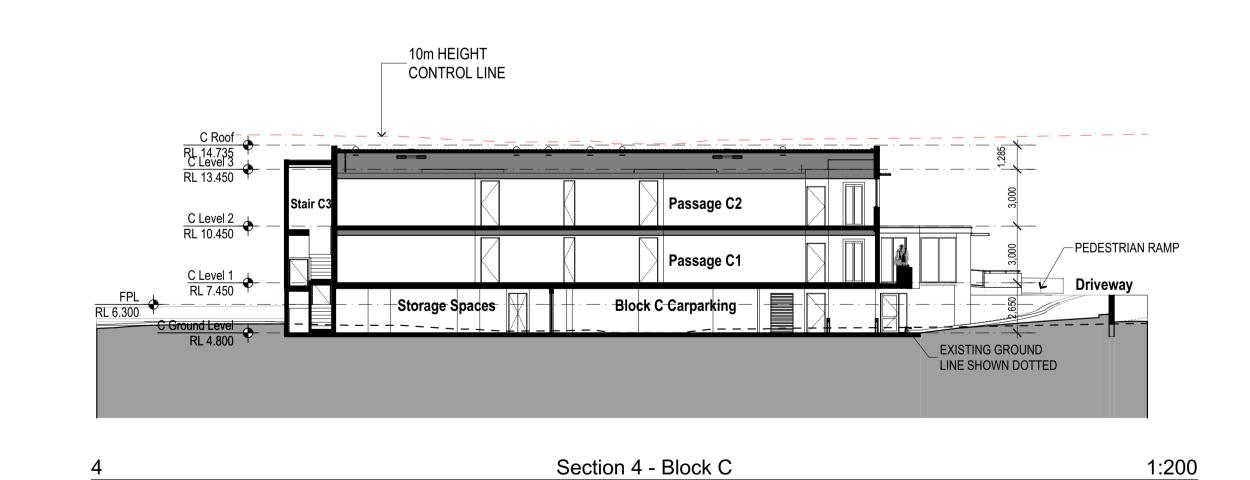

	B <i>A</i>	ASIX COMMITMEN	TS NOTES		Building Elements	Material	Detail
	T	*REFER TO APPROVED BASIX RE	PORT*		External walls	Brick Veneer – Level 1 & Level 2	R1.5 bulk insualtion
WATER						Hebel + Furring Channel + Plasterboard – Level 3 Only	
Fixtures	All Shower Heads	All toilet flushing systems	All kitchen taps	All bathroom taps	Internal walls within Units	Plasterboard on studs	-
	3 star (> 6 but <= 7.5 L/min)	4 star	5 star	5 star	Common walls between	Concrete Blocks + Furring Channel + Plasterboard	-
Appliances					Units and stairs	_	
Central water tank 6000L water tank to collect run-off from at least 300 m ² of roof area. Connection to allow for irrigation of 180 m ² of common landscape area on the site.			Common walls between Units	Hebel + Furring Channel + Plasterboard			
ENERGY Hot water system: Gas Instantaneous with a performance of 5.5 stars			Common wall between units	Hebel + Furring Channel + Plasterboard			
2.12.10	Rathroom ventilation sy	ctem: Individual fan ducted t	o facade or roof: manu	ial switch on/off	and the lobby/passage		
	Bathroom ventilation system: Individual fan, ducted to façade or roof; manual switch on/off Kitchen ventilation system: Individual fan, ducted to façade or roof; manual switch on/off			Ceiling	Plasterboard	R2.5 bulk insulation to ceilings with metal roof above	
REFER TO	REFER TO Laundry ventilation system: Individual fan, ducted to façade or roof; manual switch on/off			Floors	Concrete – all levels	-	
APPROVED	Cooling system: 1 Phase air-conditioning EER 3.0 - 3.5 in at least 1 living/bed area (zoned)		Roof	Metal Roof	Anticon blanket (R1.3) to underside of roof		
BASIX	Heating system: 1 Phase	e air-conditioning EER 3.0 - 3.5	in at least 1 living/bed	d area (zoned)		Concrete	-
	Natural lighting: As per	BASIX			Windows	Bi-fold door only:	
	Artificial lighting: As per	r BASIX			(to Unit B14 Only)	Aluminium frame, single glazed High Solar Gain Low E	U value 5.40 or less and SHGC 0.49 +/- 5%
	Appliances:					Sliding windows/doors:	
	Dishwashers: 3.5 star er	oven in the kitchen of the Unit	is.			Aluminium frame, single glazed High Solar Gain Low E	U value 5.40 or less and SHGC 0.58 +/- 5%
			ment so that it is "well	l ventilated"	Windows	Bi-fold door only:	
	Must construct each refrigerator space in the development so that it is "well ventilated". Must install fixed indoor or sheltered clothes drying line as part of the development.		(to rest of Units)	Aluminium frame, single glazed clear	U value 6.70 or less and SHGC 0.57 +/- 5%		
PHOTOVOLTAIC	Rated electrical output		•	•		Sliding windows/doors and double hung windows:	
SYSTEM						Aluminium frame, single glazed clear	U value 6.70 or less and SHGC 0.70 +/- 5%
COMMON	Refer to approved BASI	X Certificate				ted with a non-ventilated LED downlights as per NatH	ERS Certificate.
AREAS					Note: Self-closing damper to all	ensuites/bathrooms/laundries exhaust fans.	

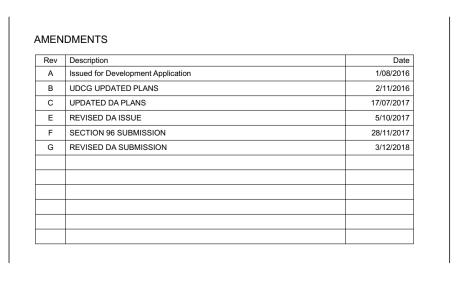

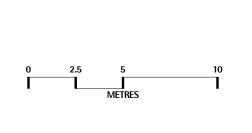


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Architecture and Interiors
Locked Bag 3005 Annandale NSW 2038 Tel 9557 6005 Fax 9557 6009


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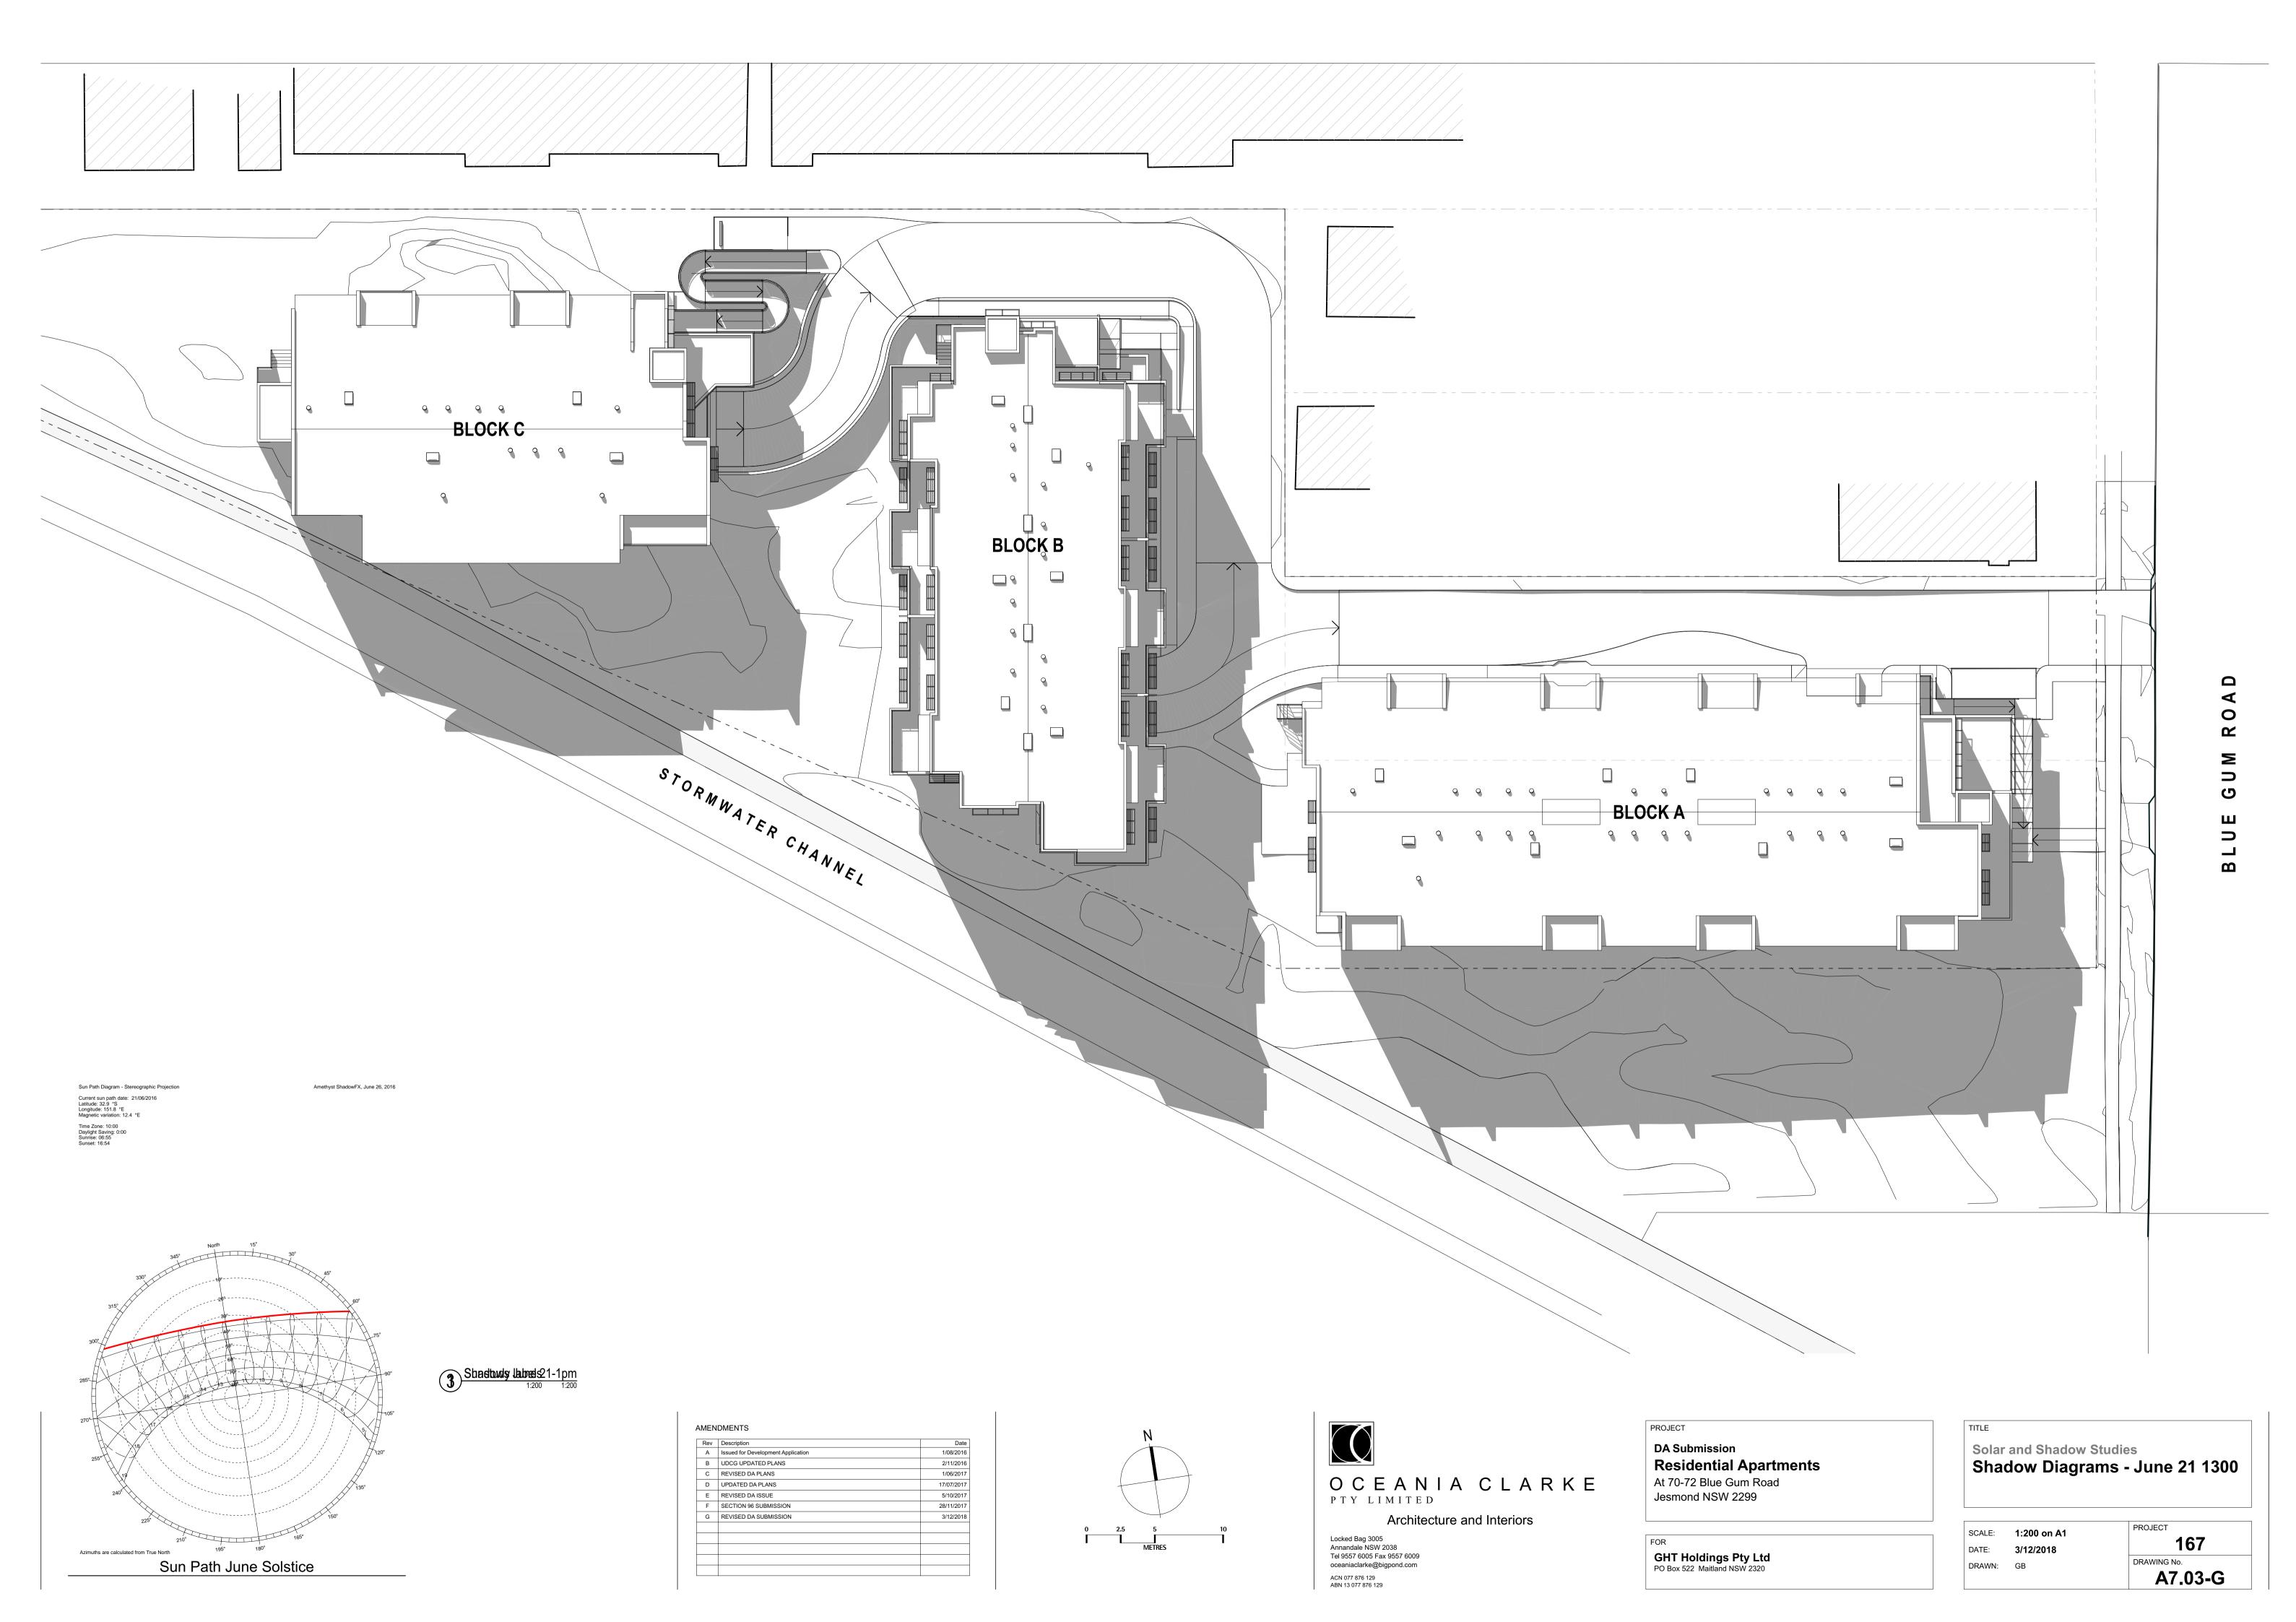
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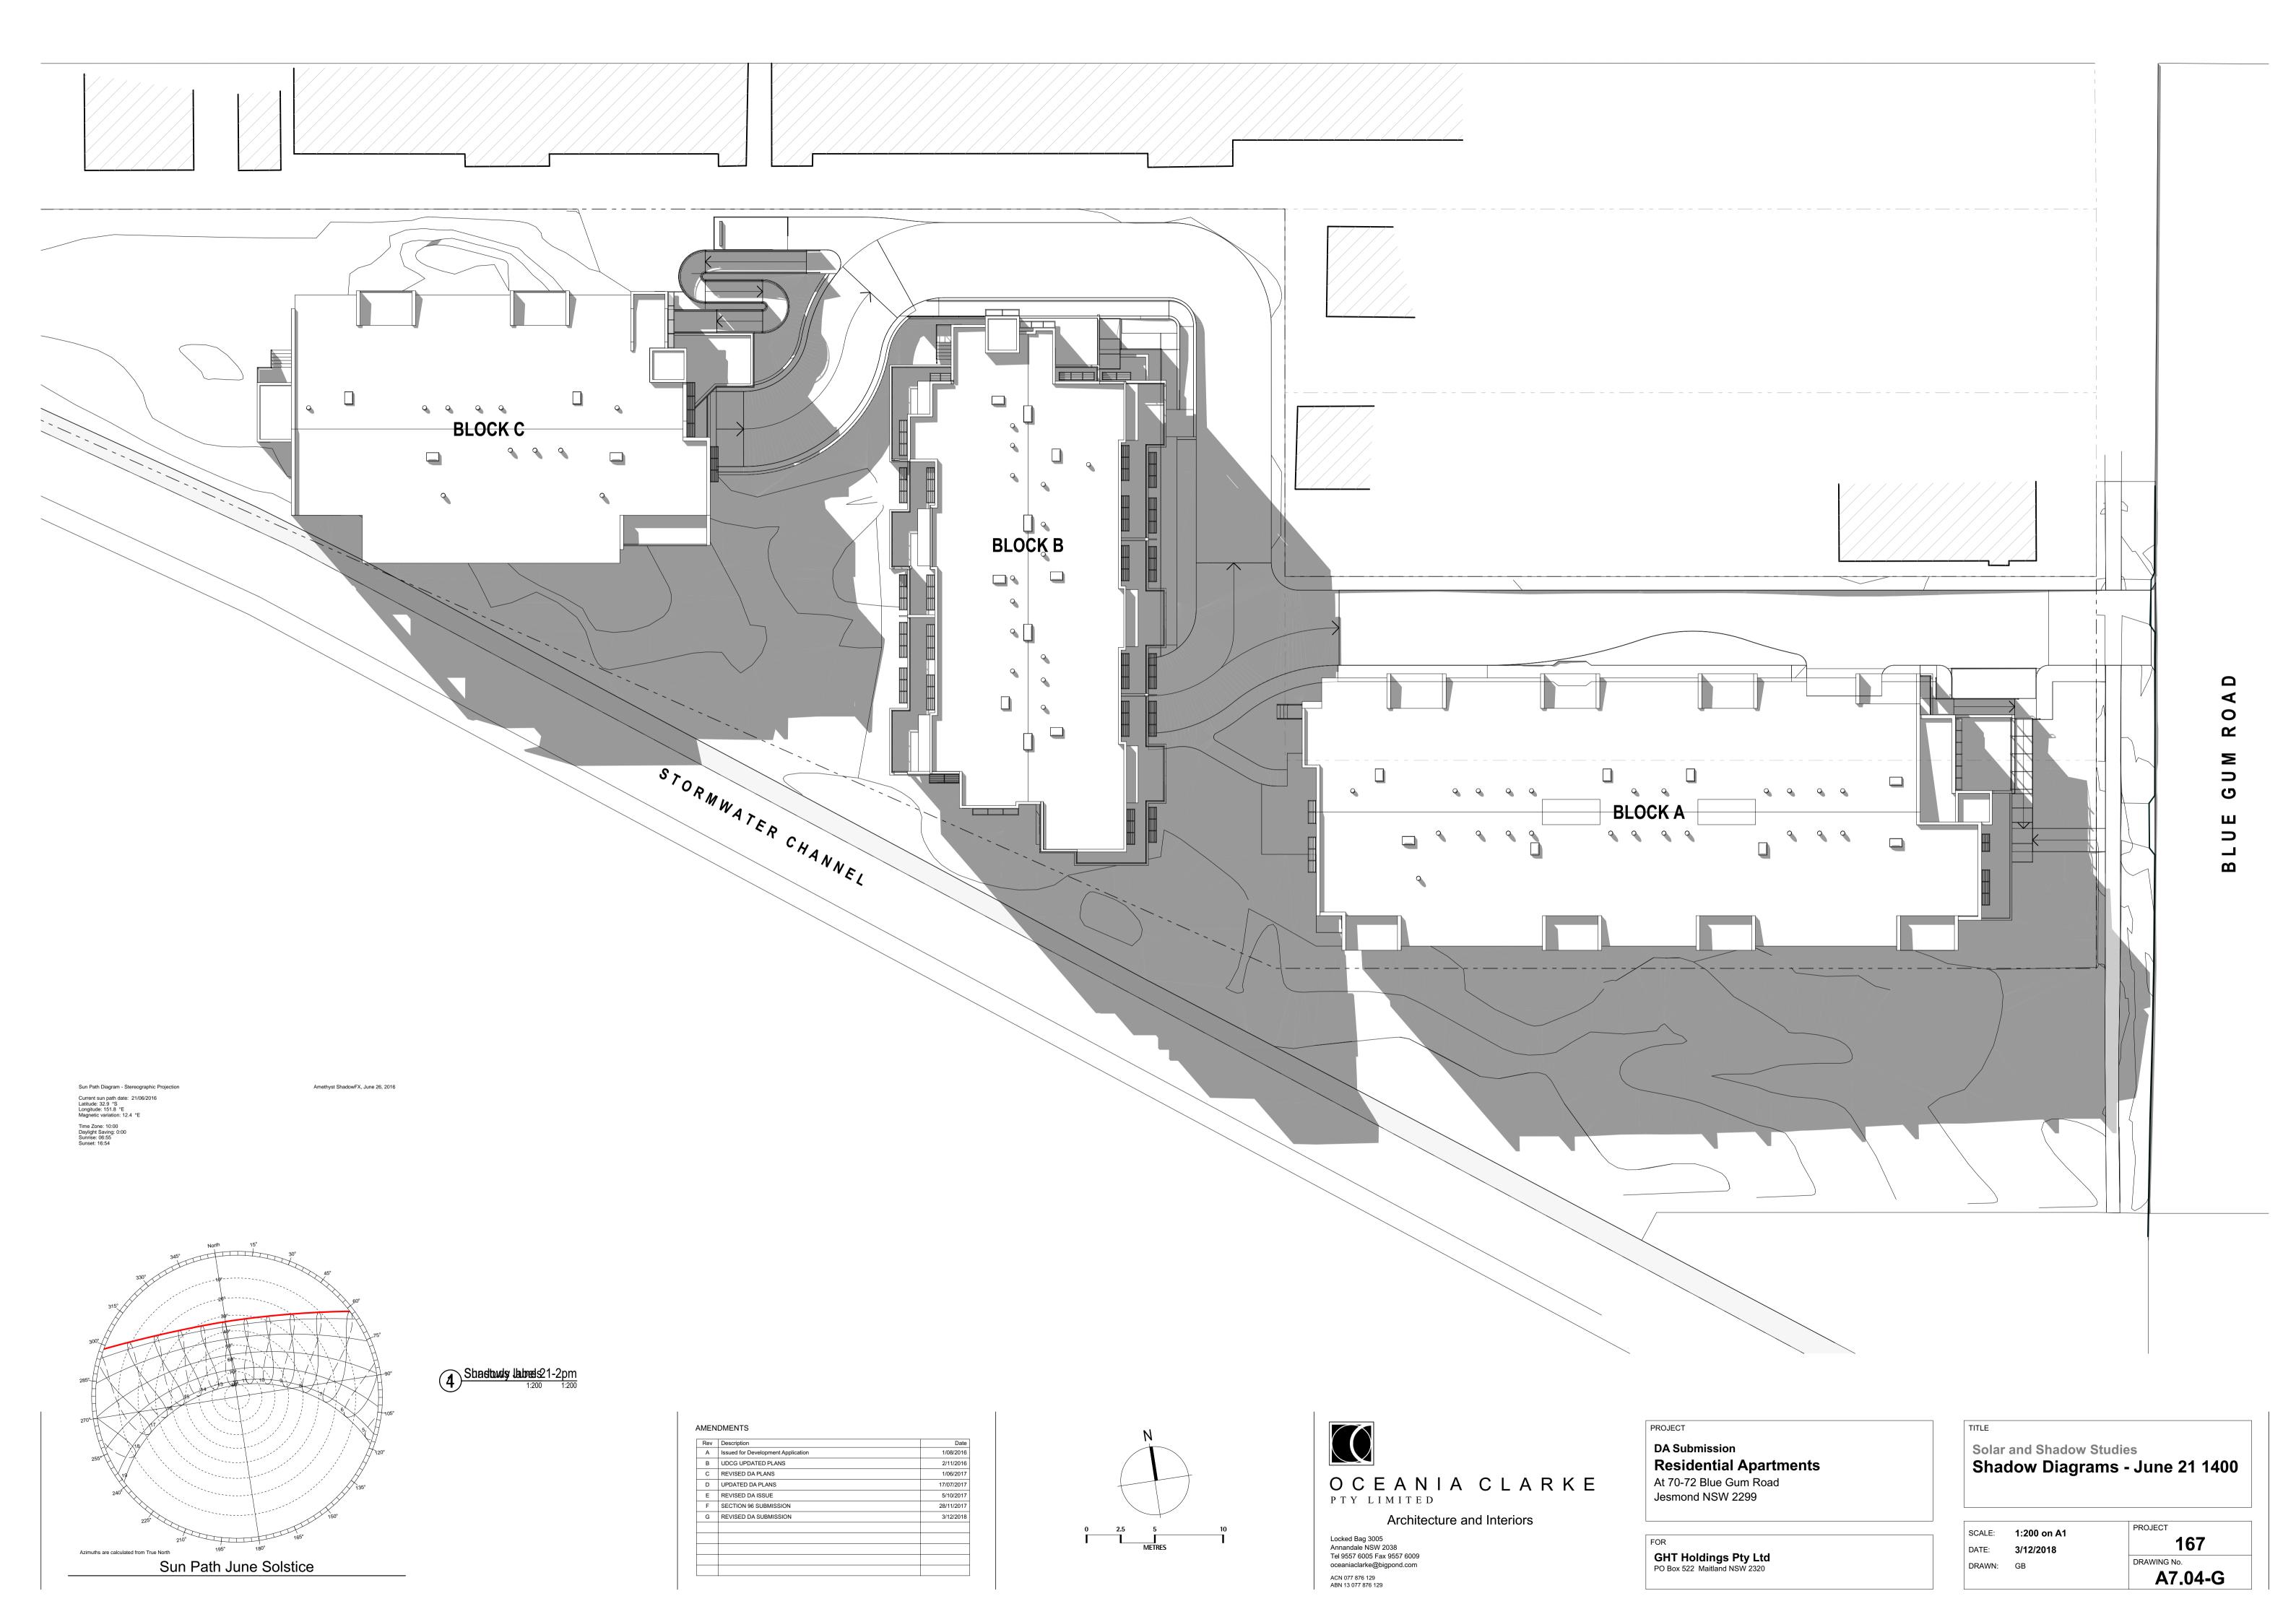
DA Submission	
Residential Apartments	
At 70-72 Blue Gum Road	
Jesmond NSW 2299	
DR	


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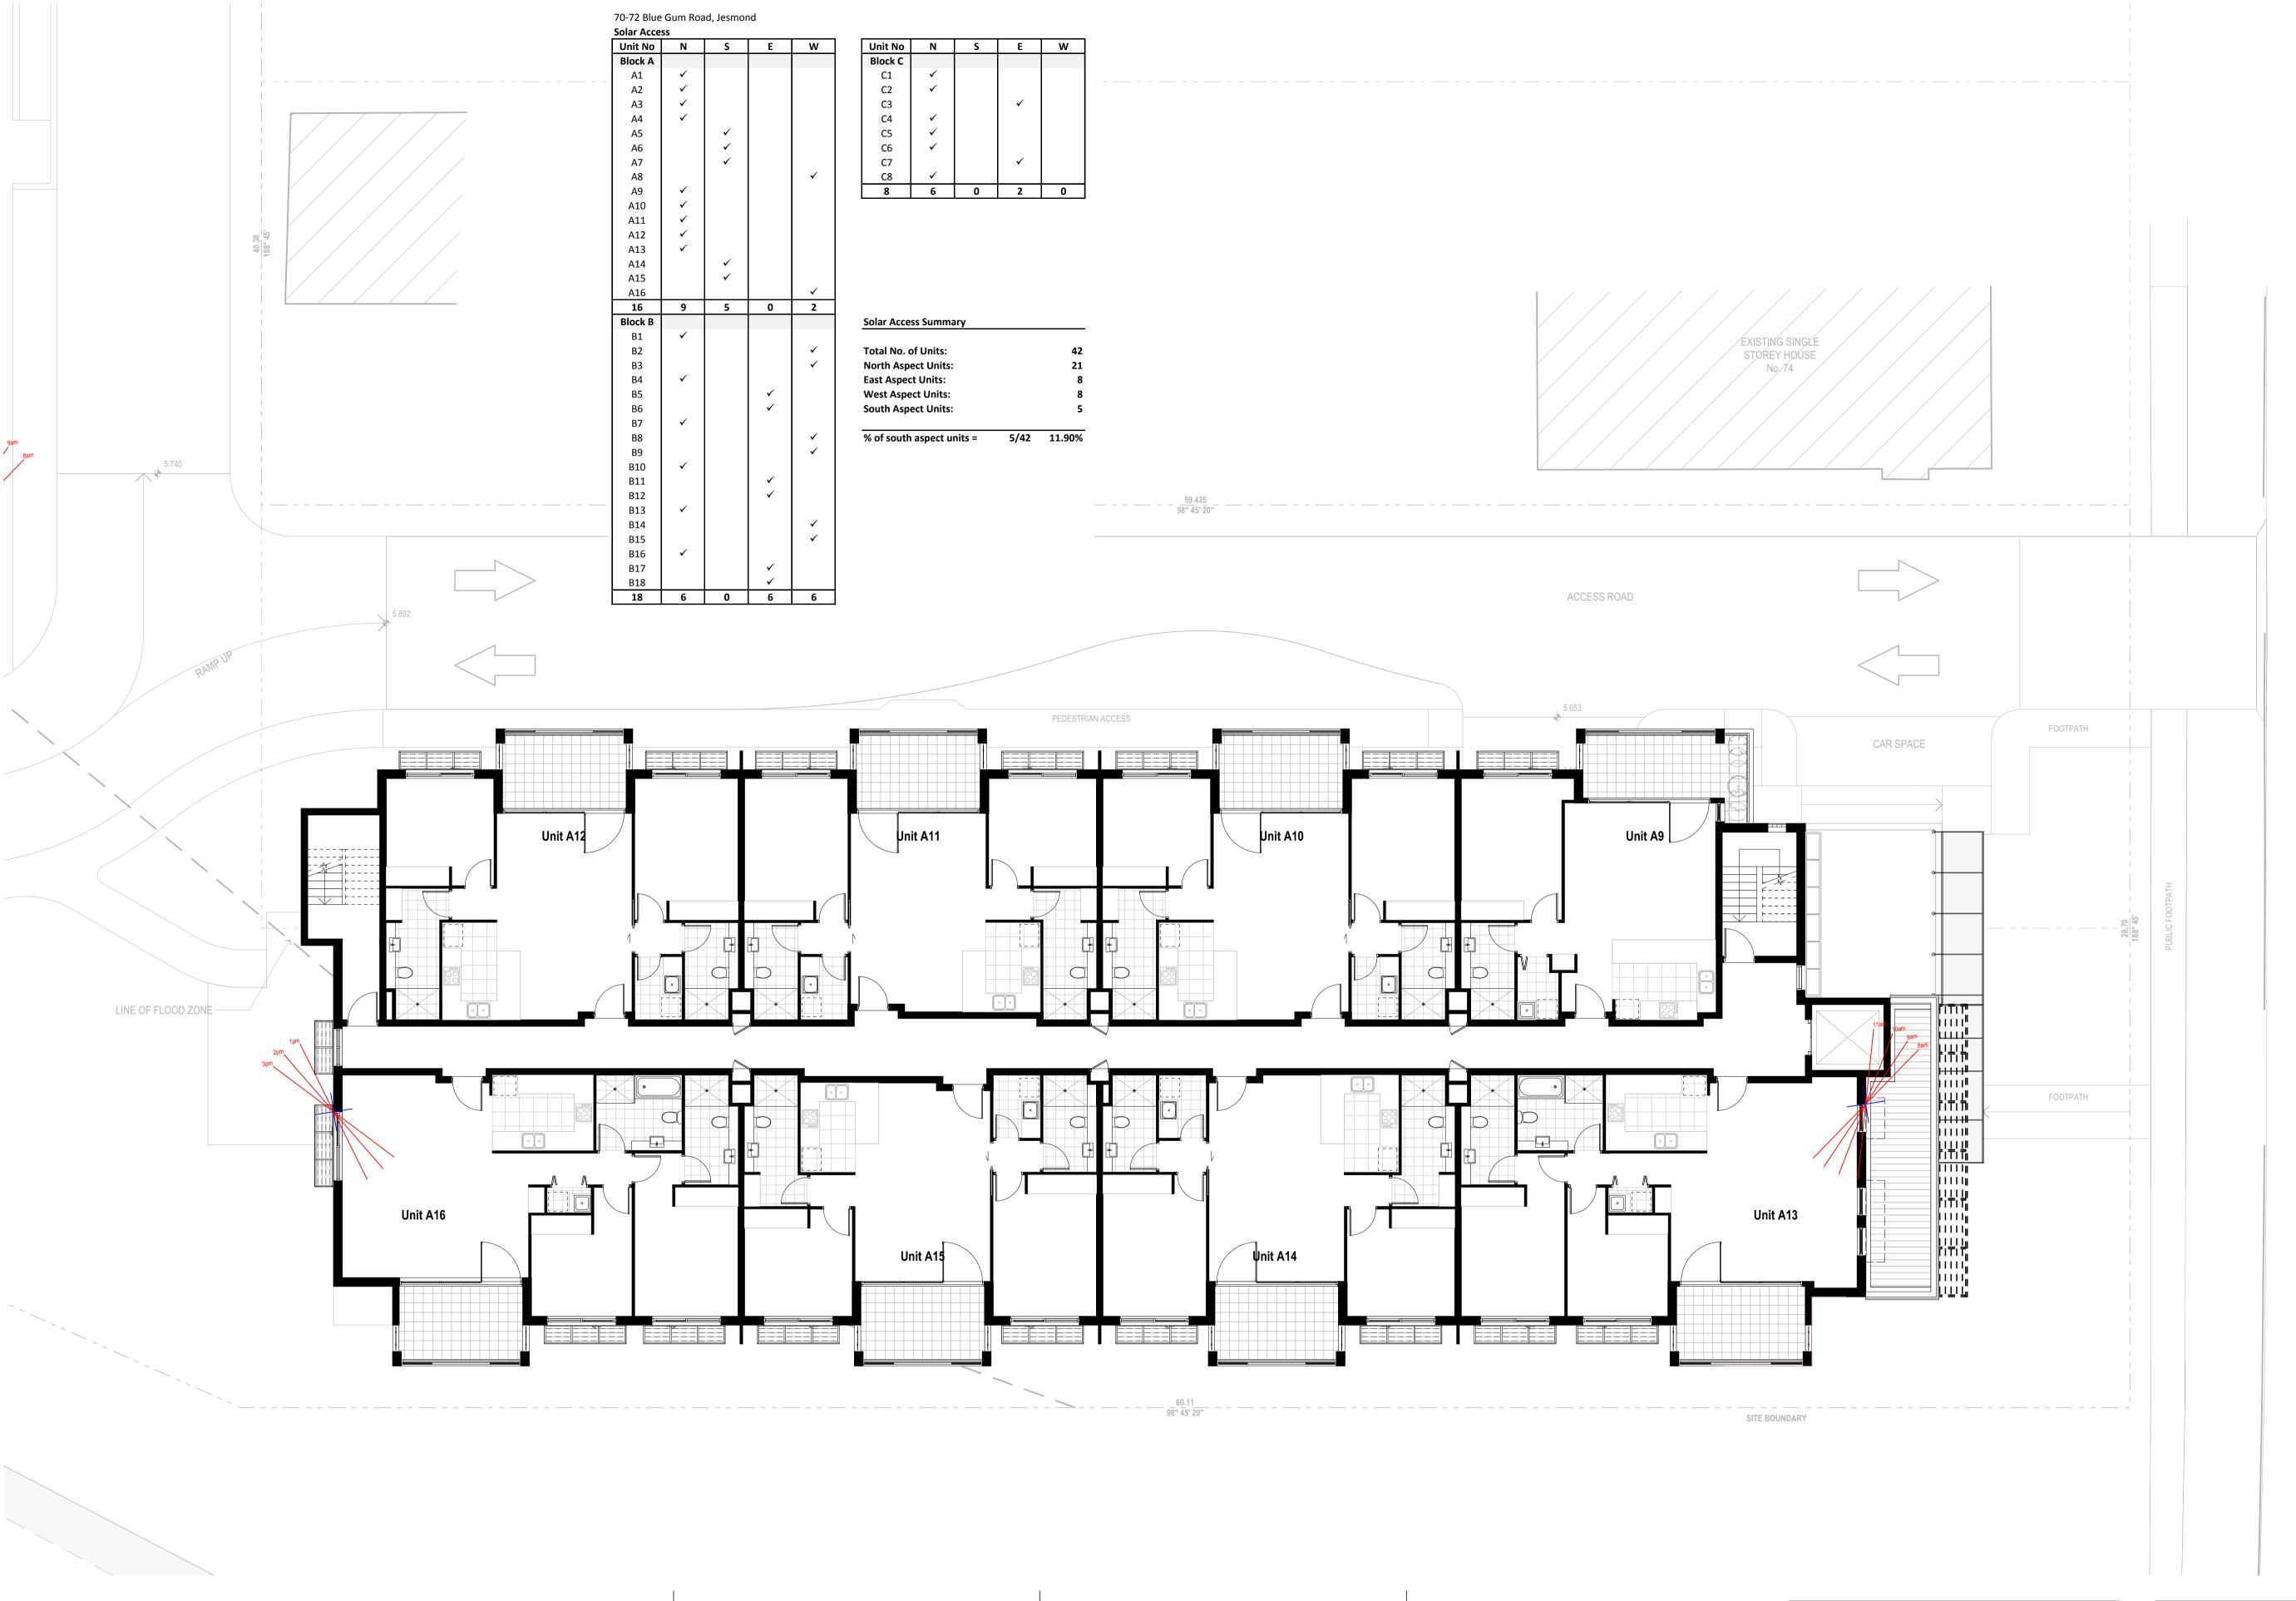








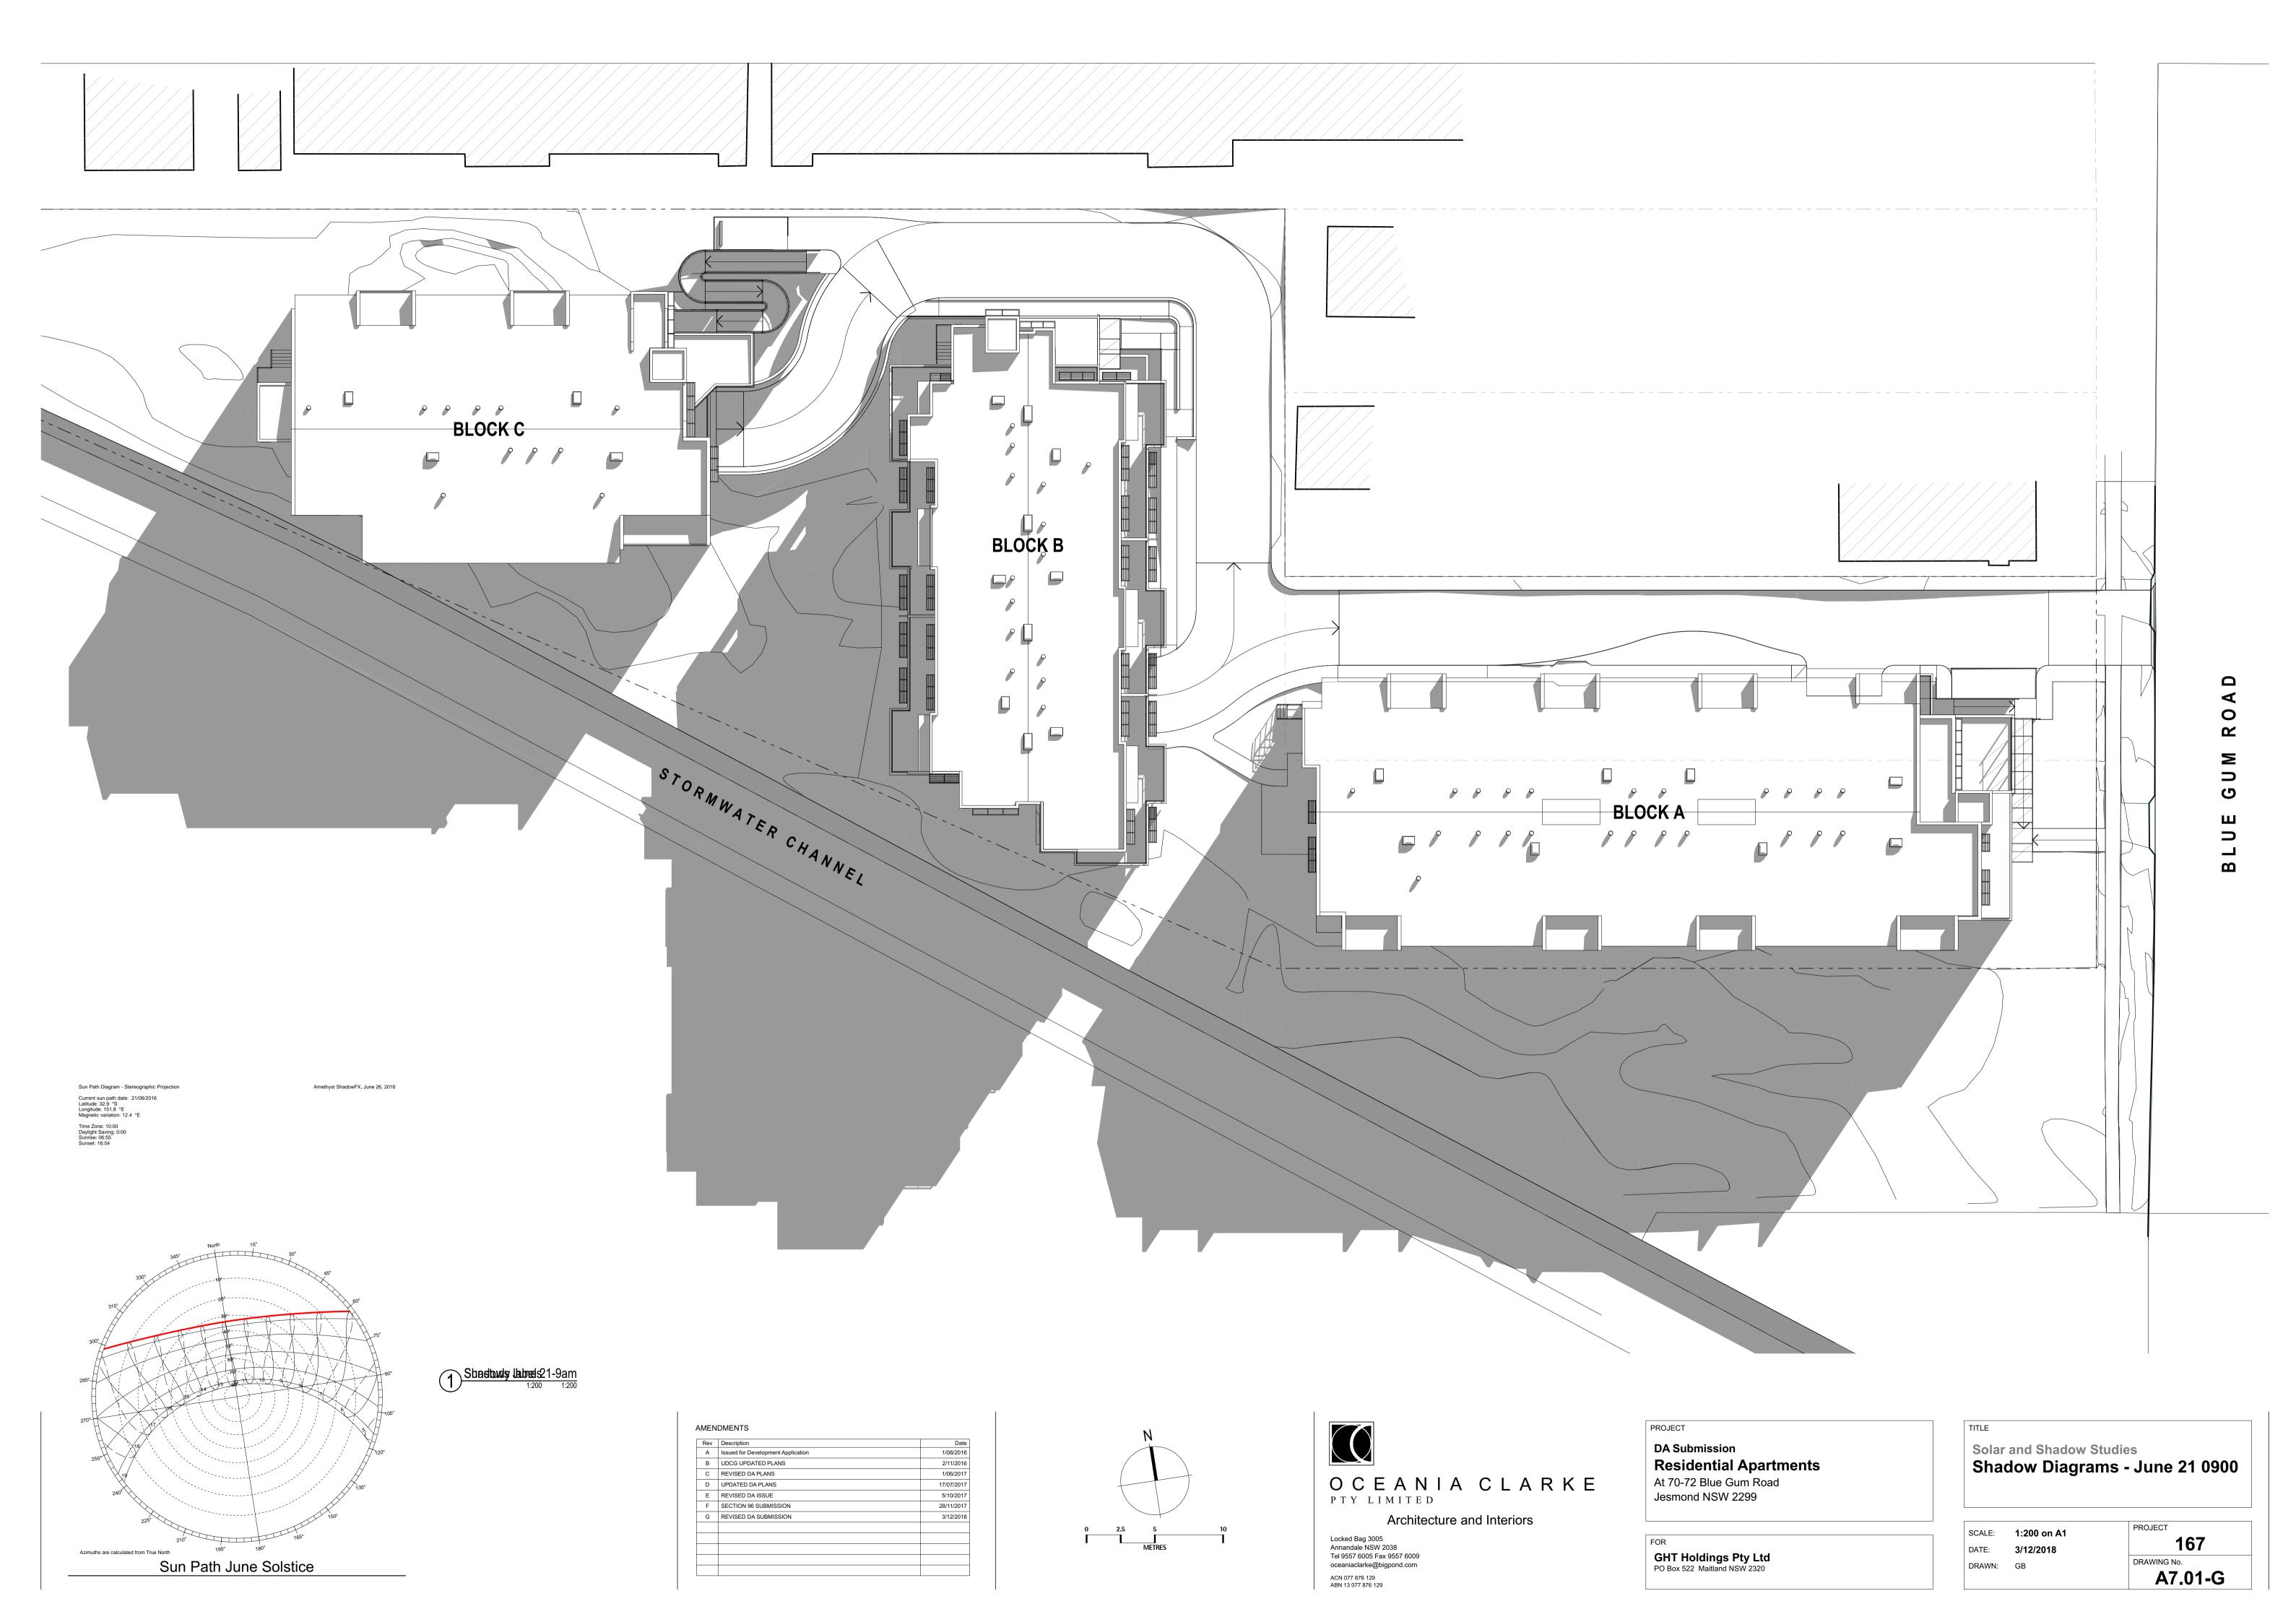

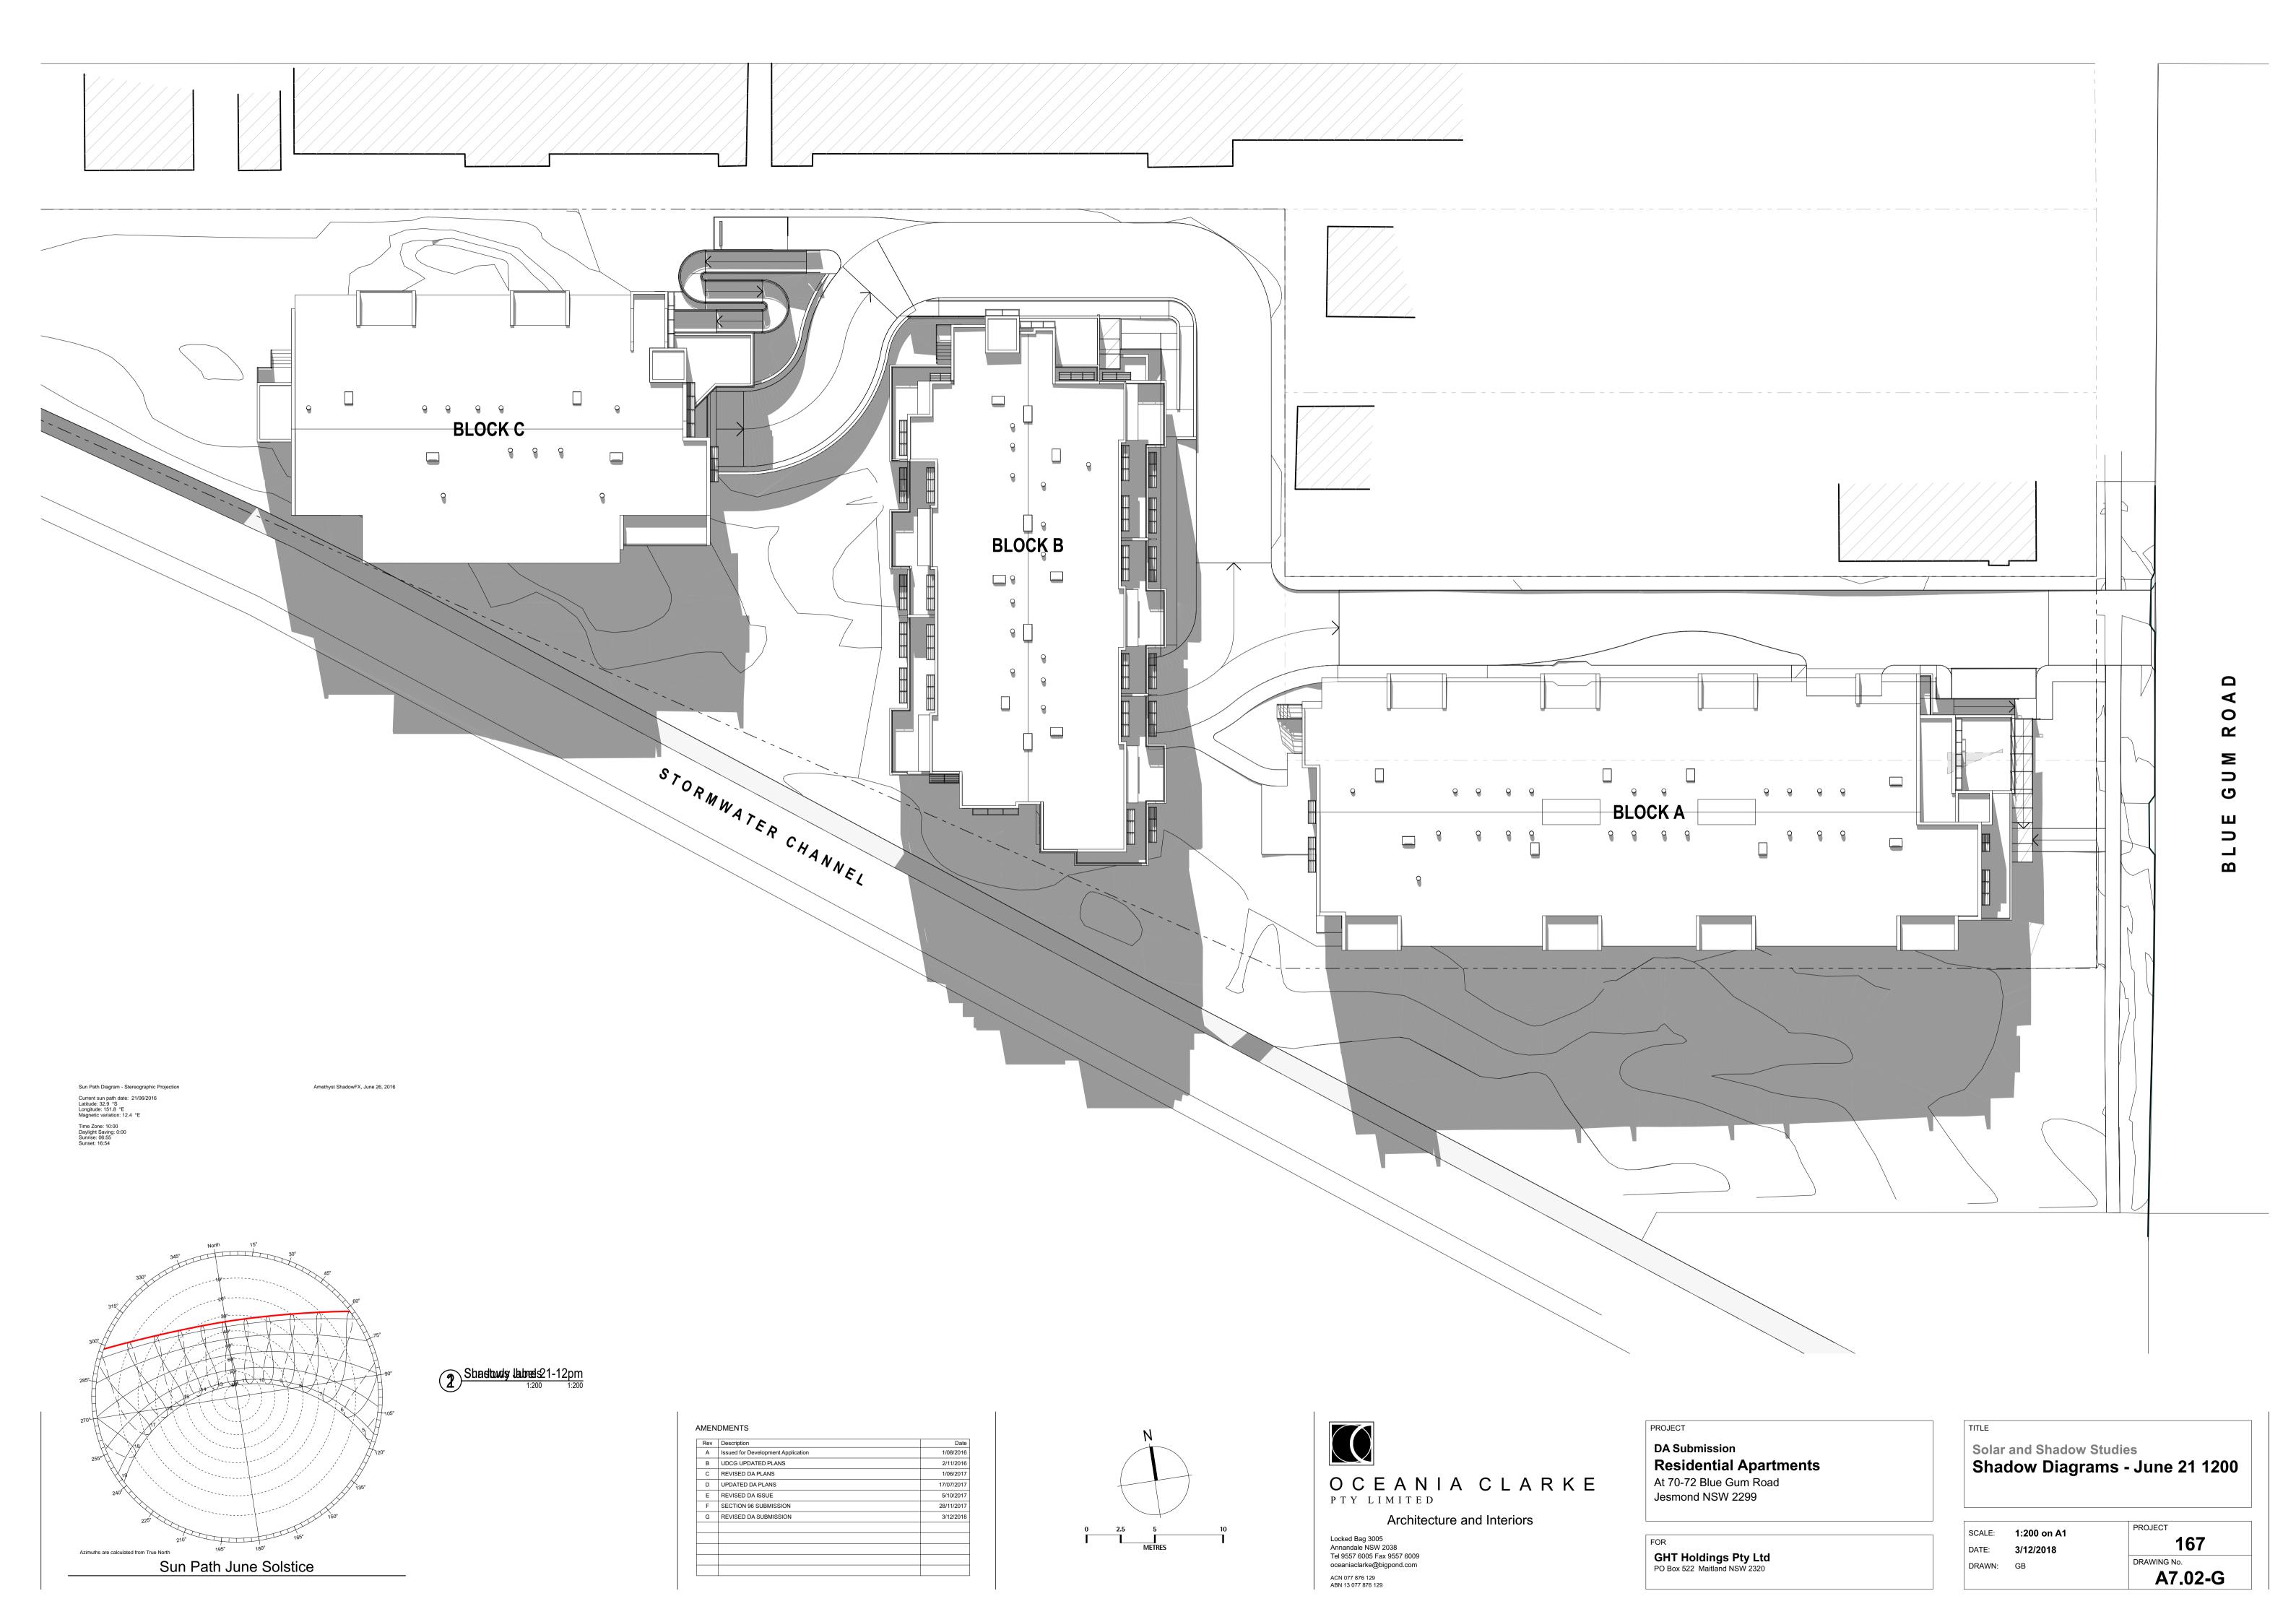

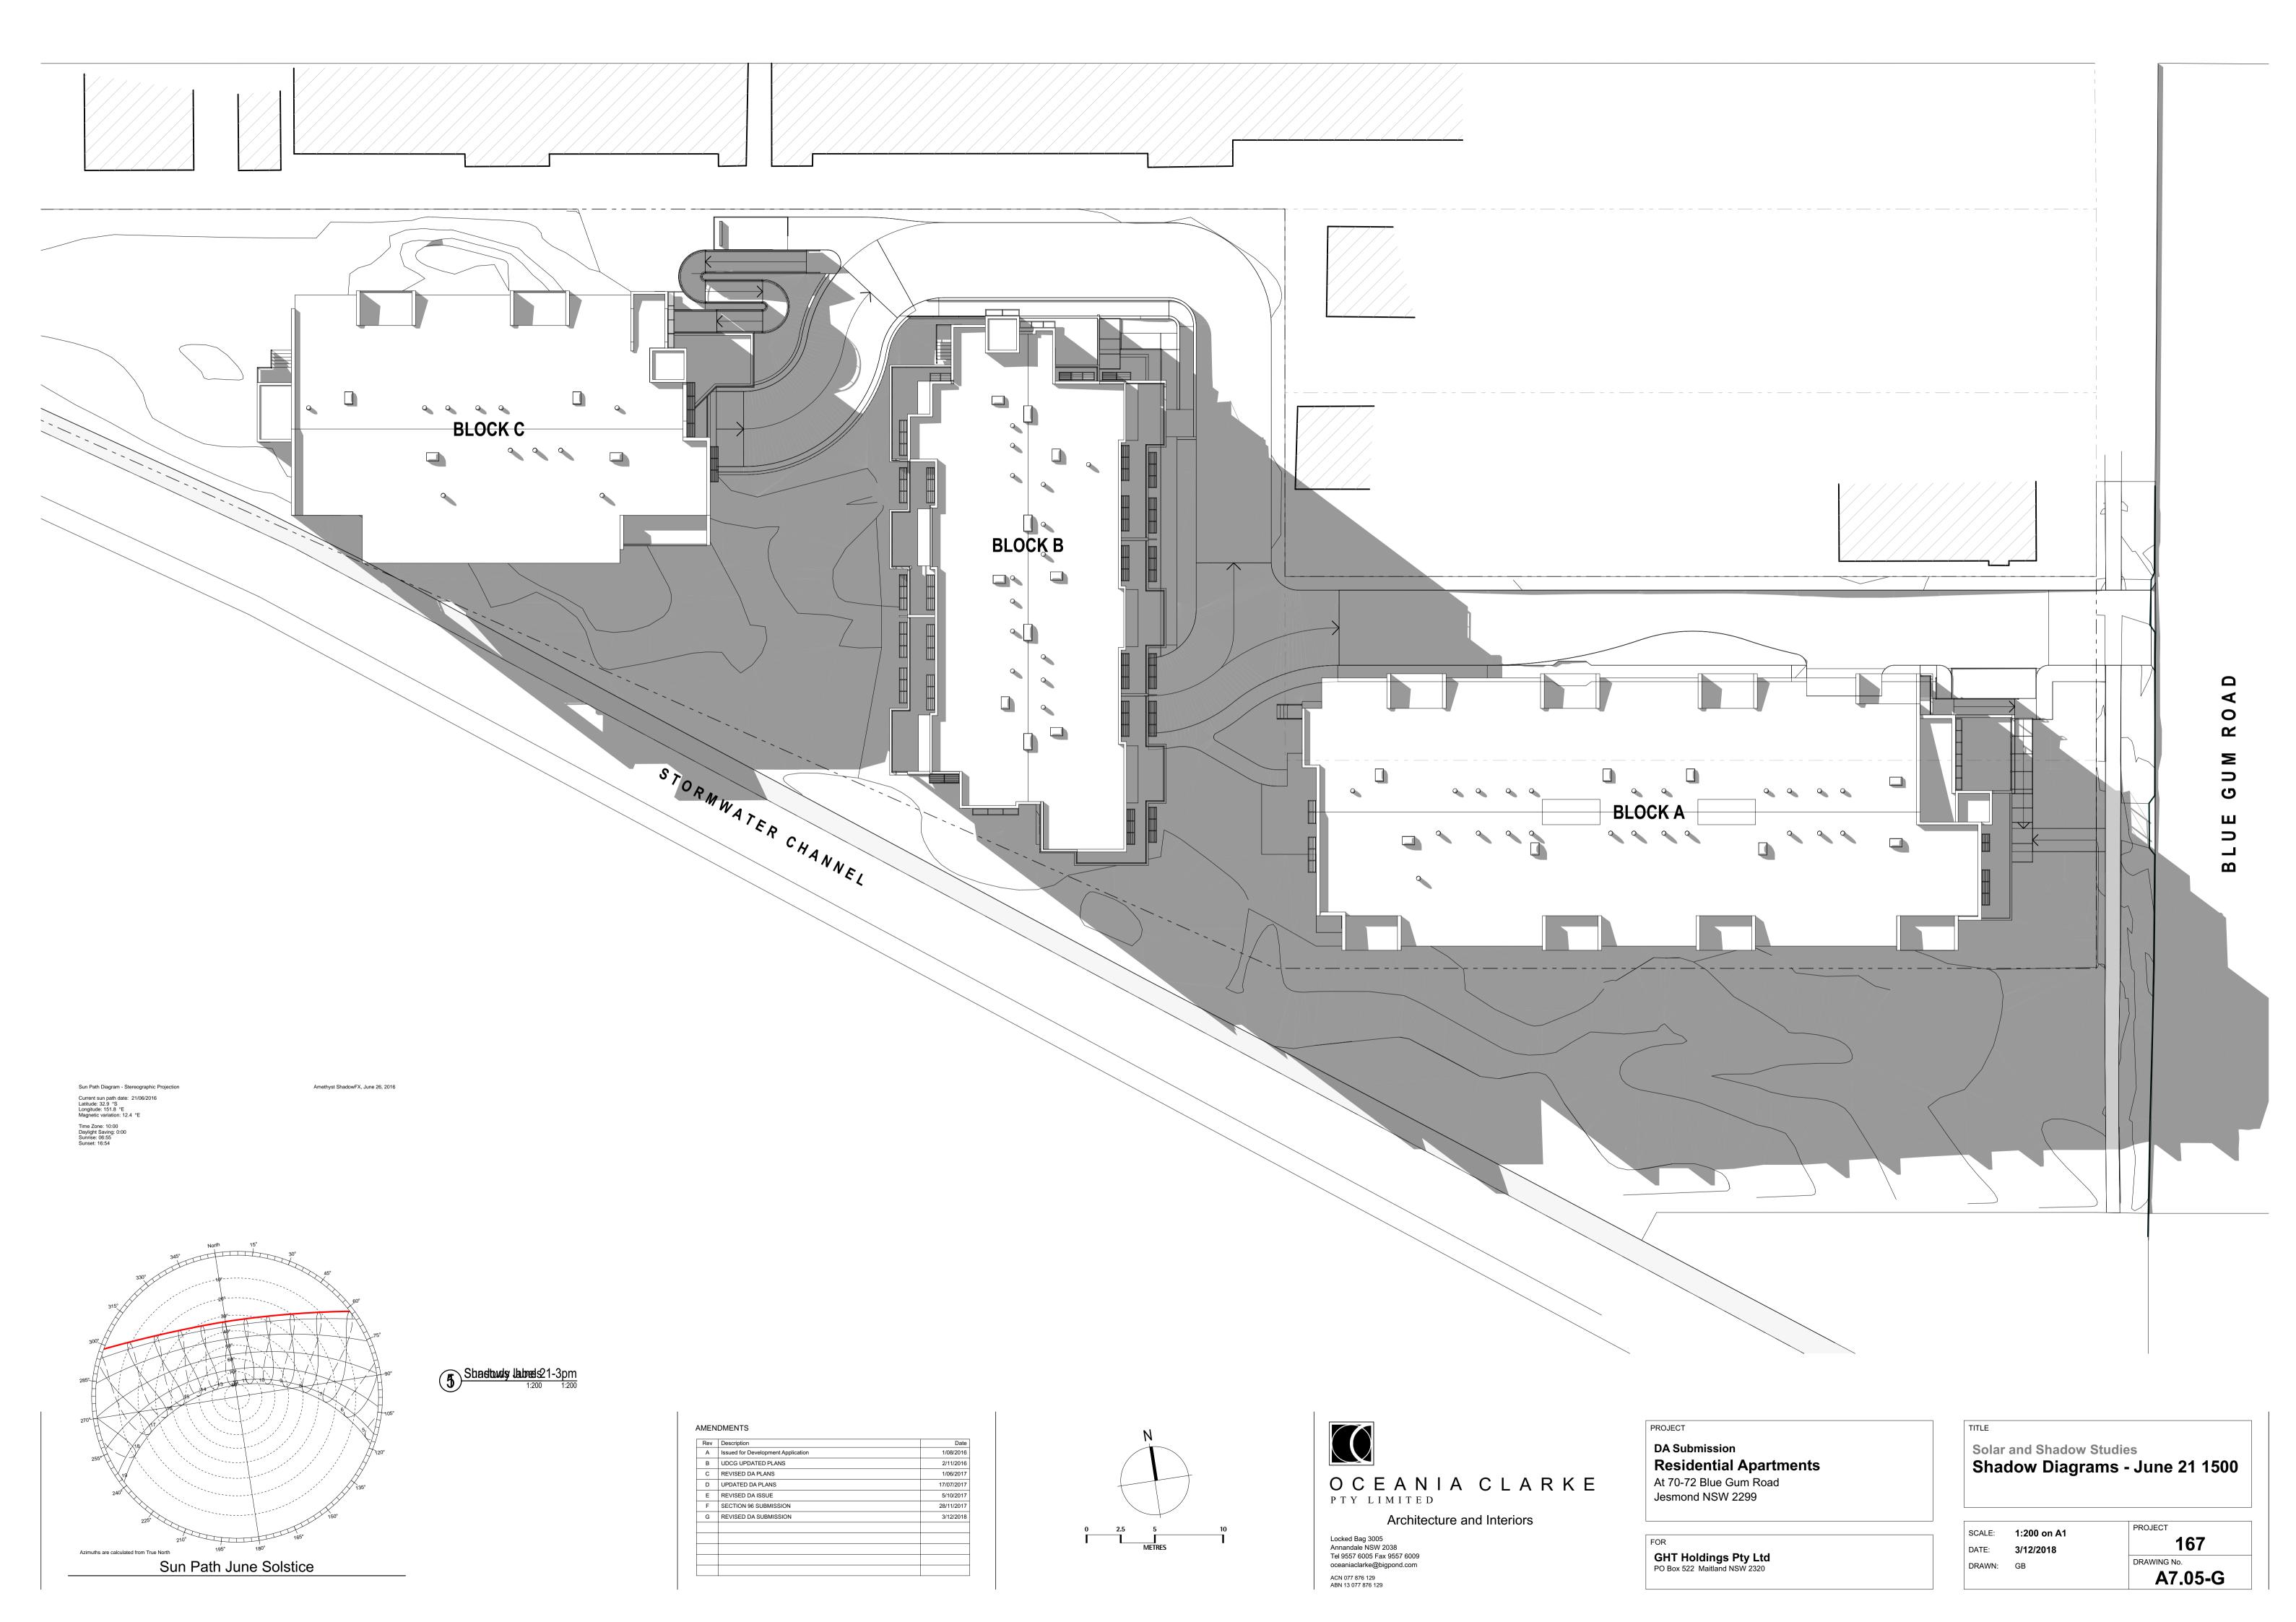

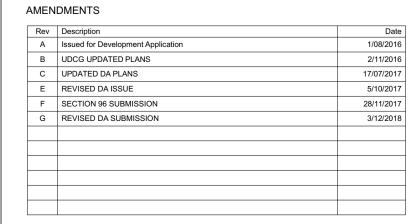

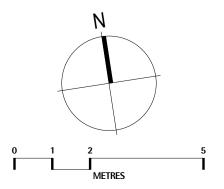



Locked Bag 3005 Annandale NSW 2038 Tel 9557 6005 Fax 9557 6009 oceaniaclarke@bigpond.com ACN 077 876 129 ABN 13 077 876 129


PROJECT **DA Submission Residential Apartments** At 70-72 Blue Gum Road Jesmond NSW 2299

GHT Holdings Pty Ltd PO Box 522 Maitland NSW 2320

Typical Floor Plan - Block A Solar Access Diagram

CALE: ATE:	1:100 on A1 3/12/2018	PROJECT 167
RAWN:	GB	A7.06-G

Solar and Shadow Studies

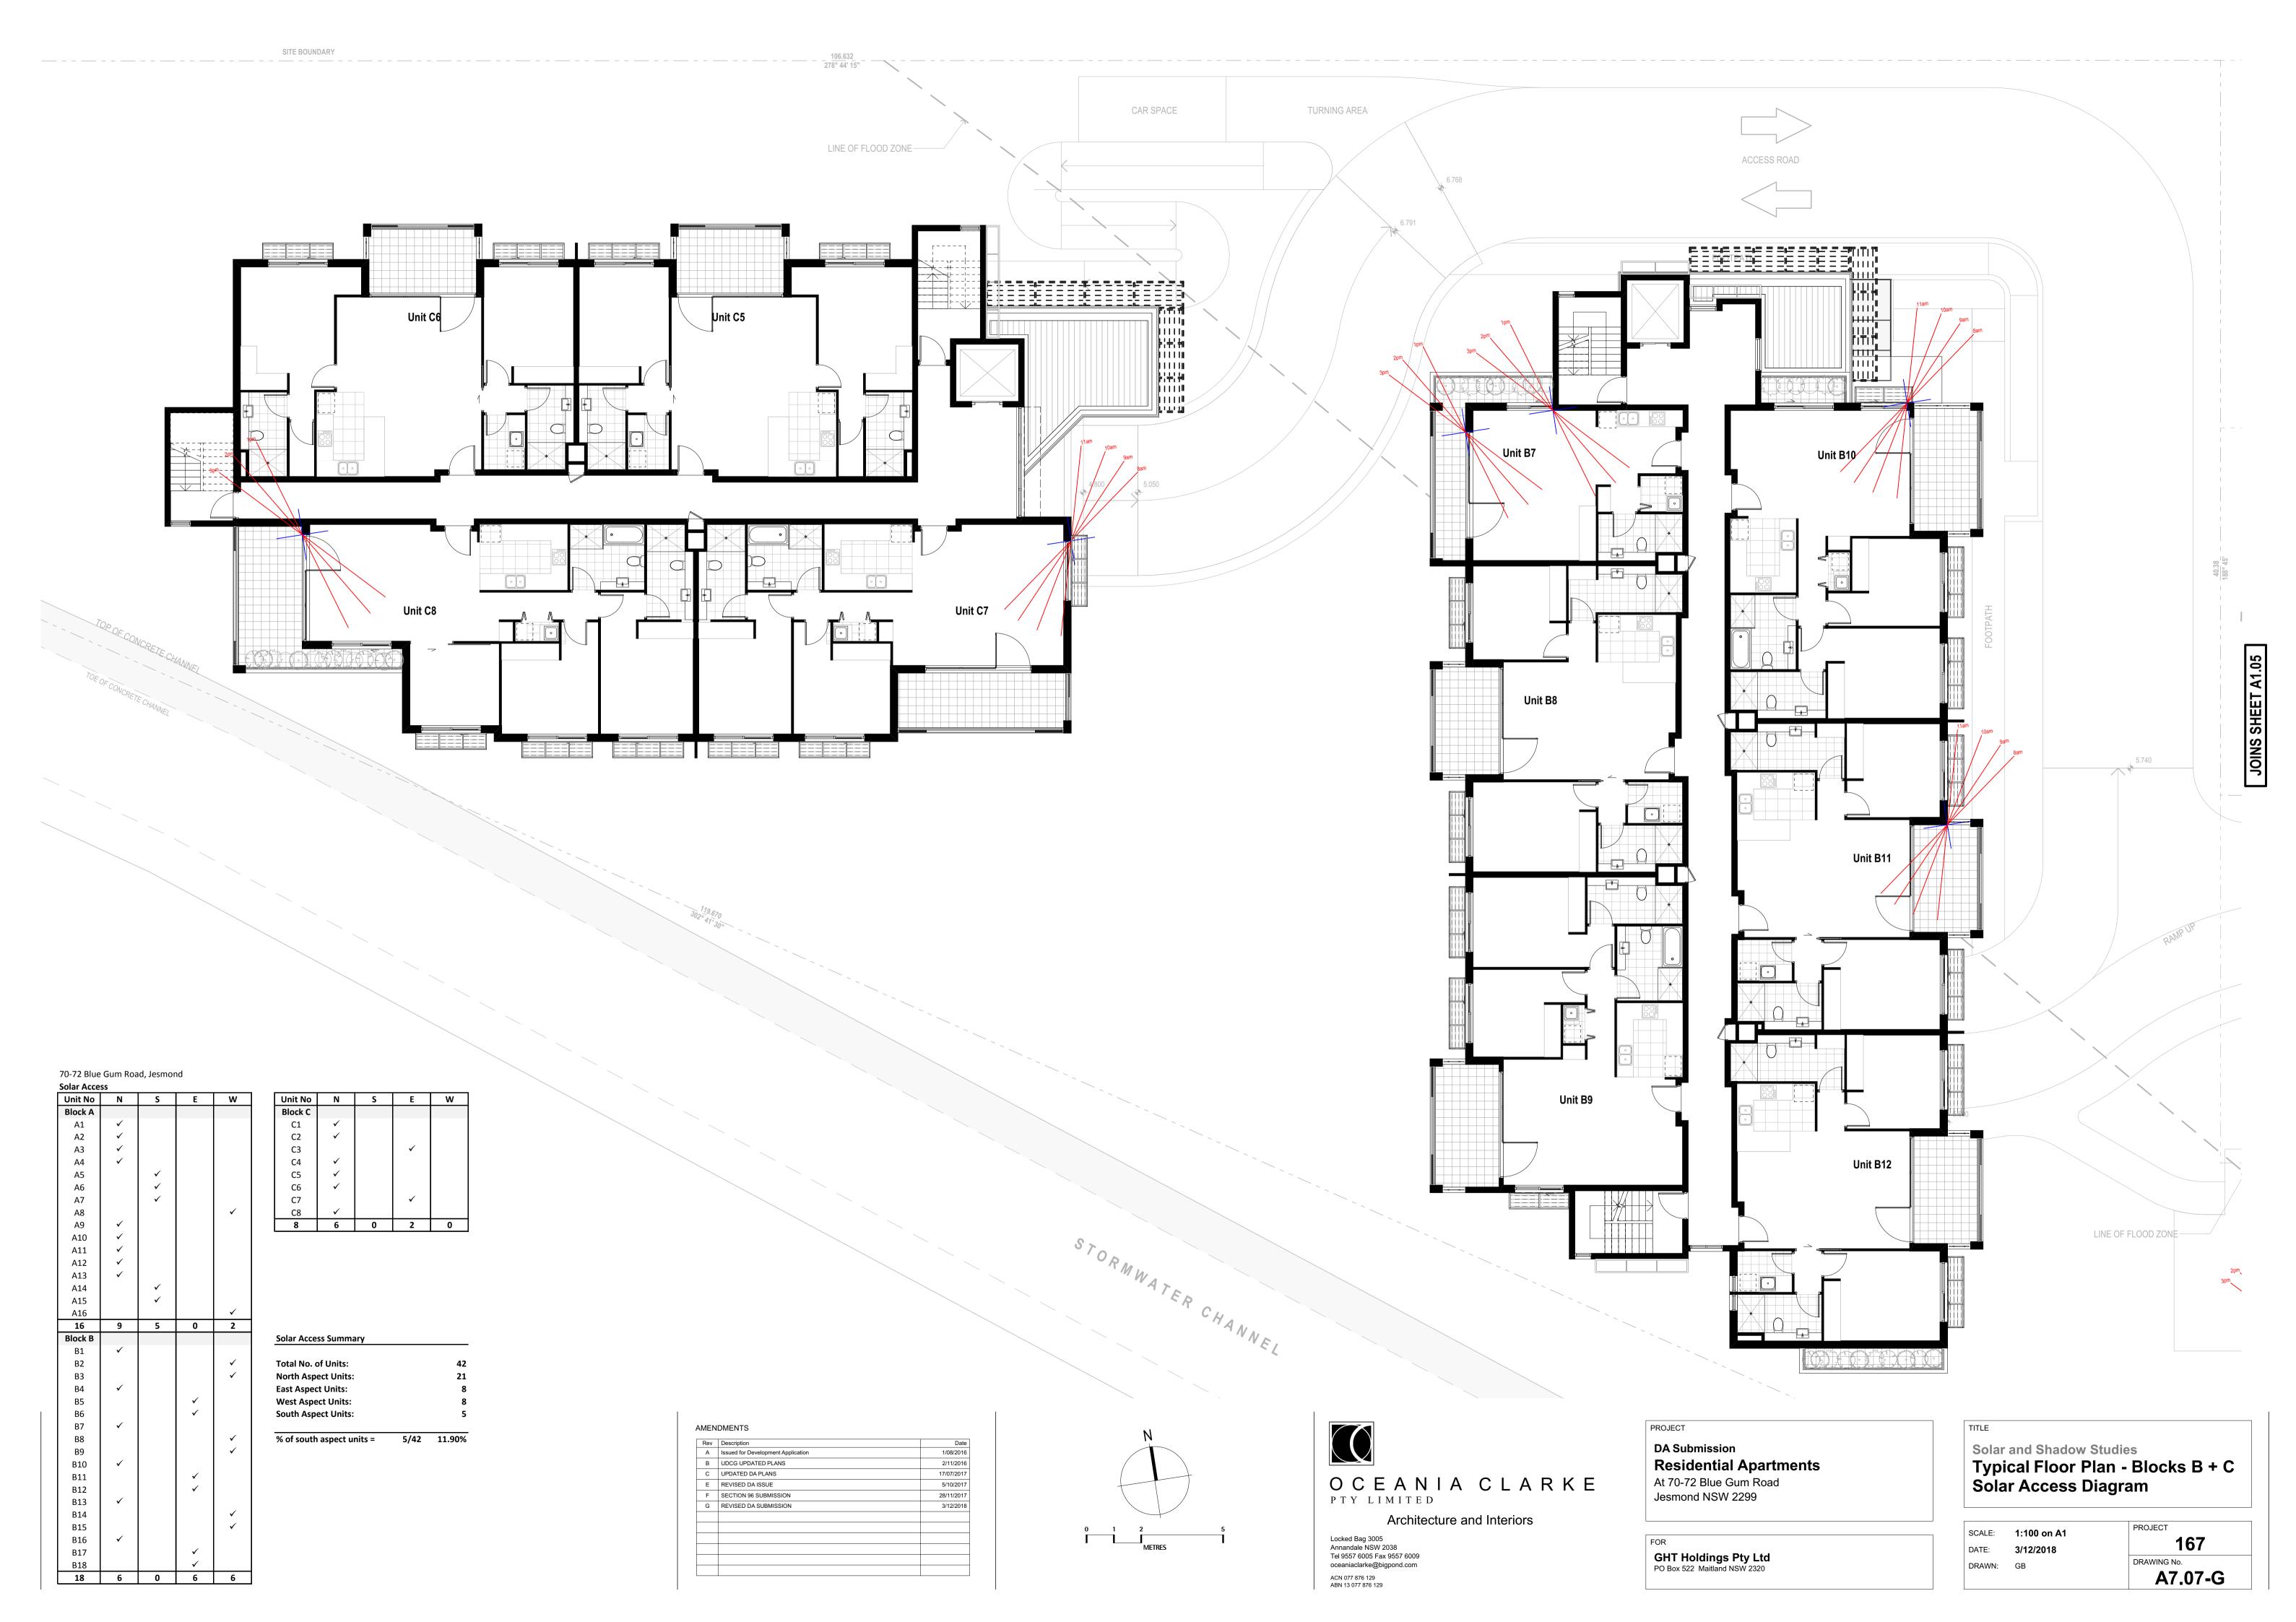






Street View Southeast 2 Street View East





Street View Northeast 4 Blocks B and C North

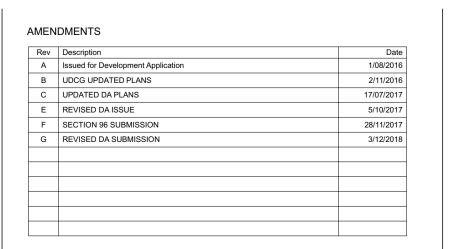



Architecture and Interiors

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oceaniaclarke@bigpond.com

ACN 077 876 129 ABN 13 077 876 129

ROJECT
DA Submission
Residential Apartments
At 70-72 Blue Gum Road
lesmond NSW 2299

GHT Holdings Pty Ltd PO Box 522 Maitland NSW 2320 3D Representation
Perspective Views

SCALE: NTS
DATE: 3/12/2018
DRAWN: GB
PROJECT
167
DRAWING No.
A9.01-G






Aerial View from Southeast 2 Aerial View from Park





Aerial View from North

Aerial View from North

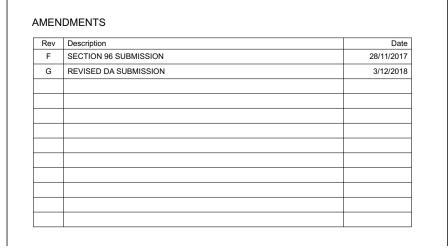



Architecture and Interiors

Locked Bag 3005
Annandale NSW 2038
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ACN 077 876 129 ABN 13 077 876 129

PROJECT
DA Submission
Residential Apartments
At 70-72 Blue Gum Road
Jesmond NSW 2299

GHT Holdings Pty Ltd PO Box 522 Maitland NSW 2320 3D Representation Perspective Views

SCALE: NTS

DATE: 3/12/2018

DRAWN: GB

PROJECT

167

DRAWING No.

A9.02-G

DEVELOPMENT APPLICATIONS COMMITTEE MEETING

18 June 2019


ATTACHMENTS DISTRIBUTED UNDER SEPARATE COVER


REPORTS BY COUNCIL OFFICERS

Attachment A - Plans DA2018/00968 - 37 Alfred Street Newcastle East

Alterations and additions to dwelling

DISTRIBUTED UNDER SEPARATE COVER

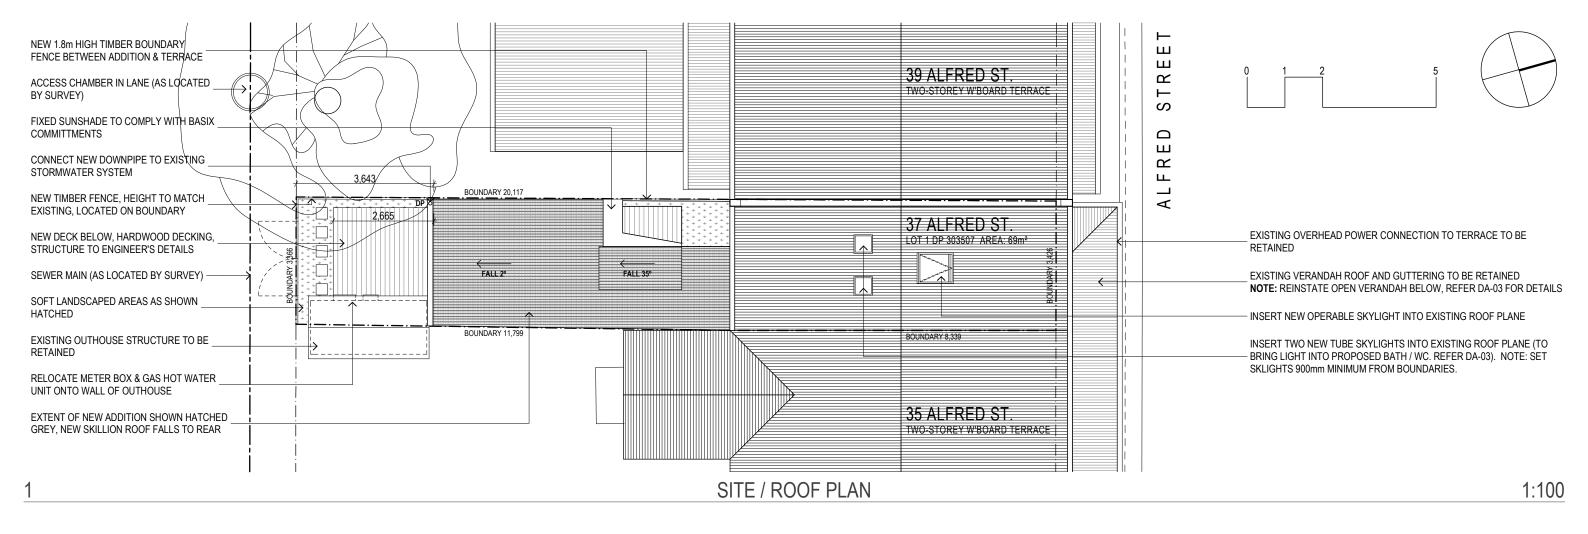

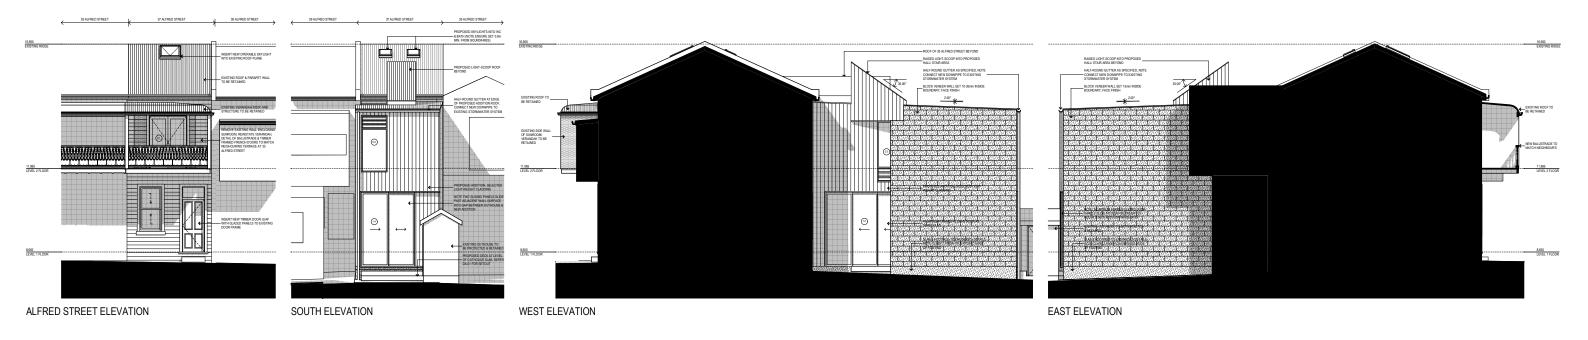

2 NOTIFICATION ELEVATIONS 1:150

BOURNE + BLUE ARCHITECTURE

WWW BOURNEBLUE.COM.AU PO BOX 295, NEWCASTLE, NSW 2300 T 02 4929 1450 F 02 4927 1623 ABN 95 114 746 897 NOMINATED NSW REGISTERED ADQUITED T SUANCE JULIE PECICETATION NO. 6890

 B
 DA ISSUE
 13/08/18

 A
 ISSUE FOR CLIENT APPROVAL
 03/07/18


 ISSUE
 AMENDMENT
 DATE

SCARBOROUGH
37 ALFRED STREET NEWCASTLE EAST

ROOF/ SITE PLAN

Status: DEVELOPMENT APPLICATION
Project No: Drawing No.:

497 DA-01

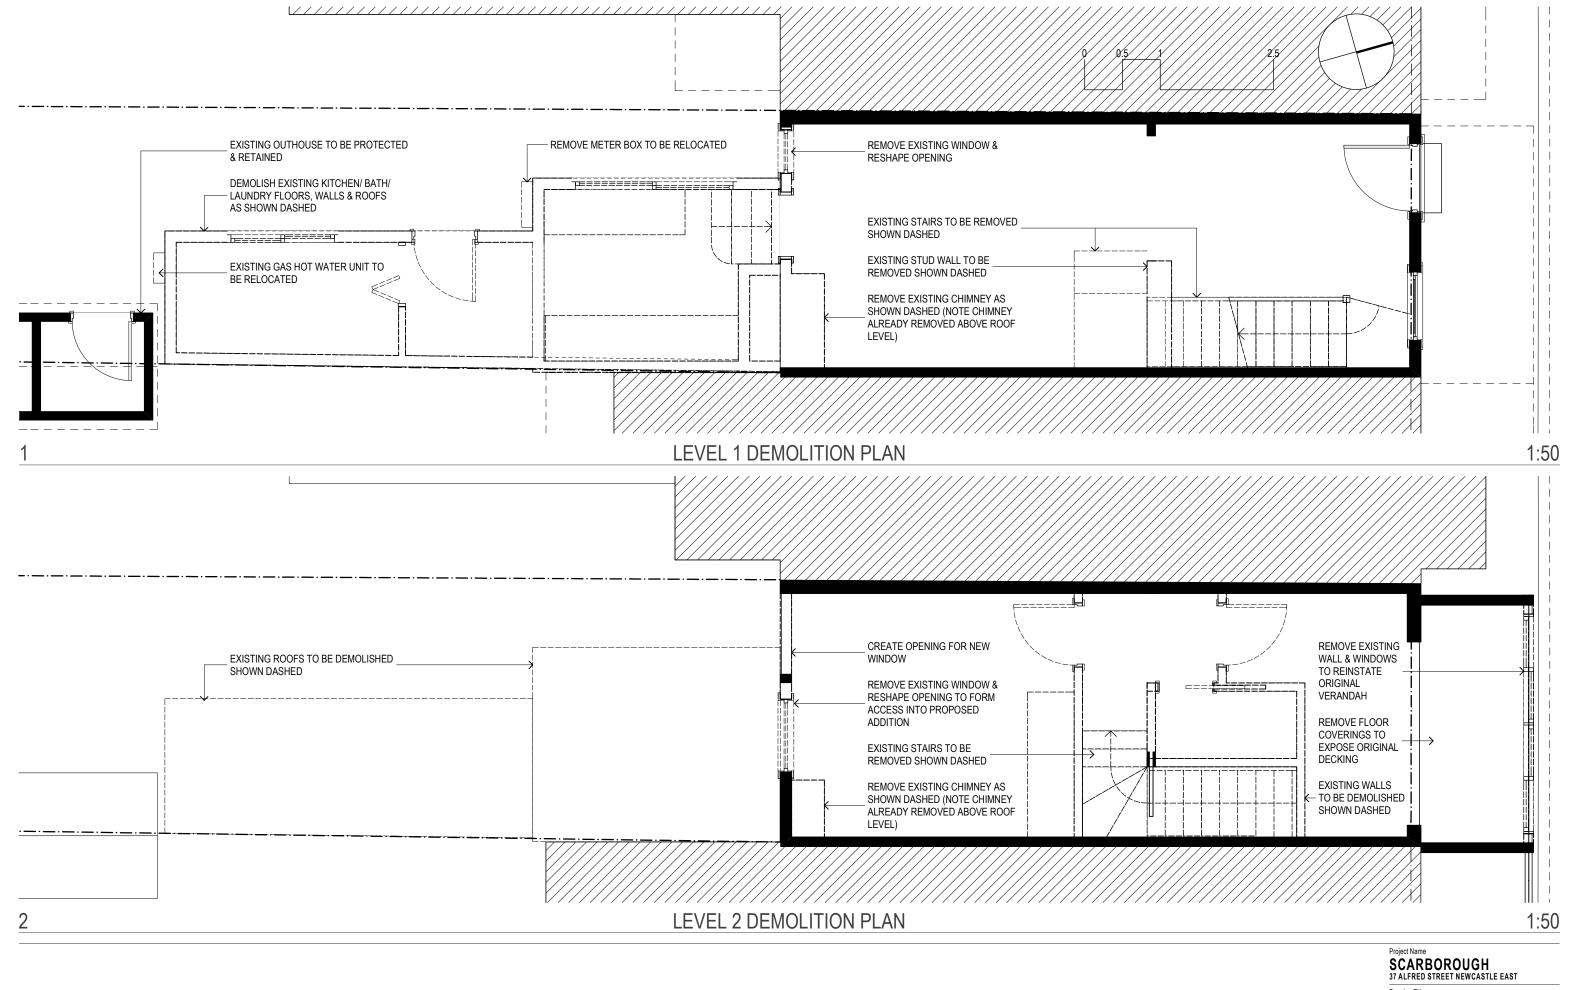


ISSUE FOR CLIENT APPROVAL 03/07/18
ISSUE TO CLIENT 26/09/17

DEMOLITION PLANS Status: DEVELOPMENT APPLICATION

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Project No: 497 **DA-02**

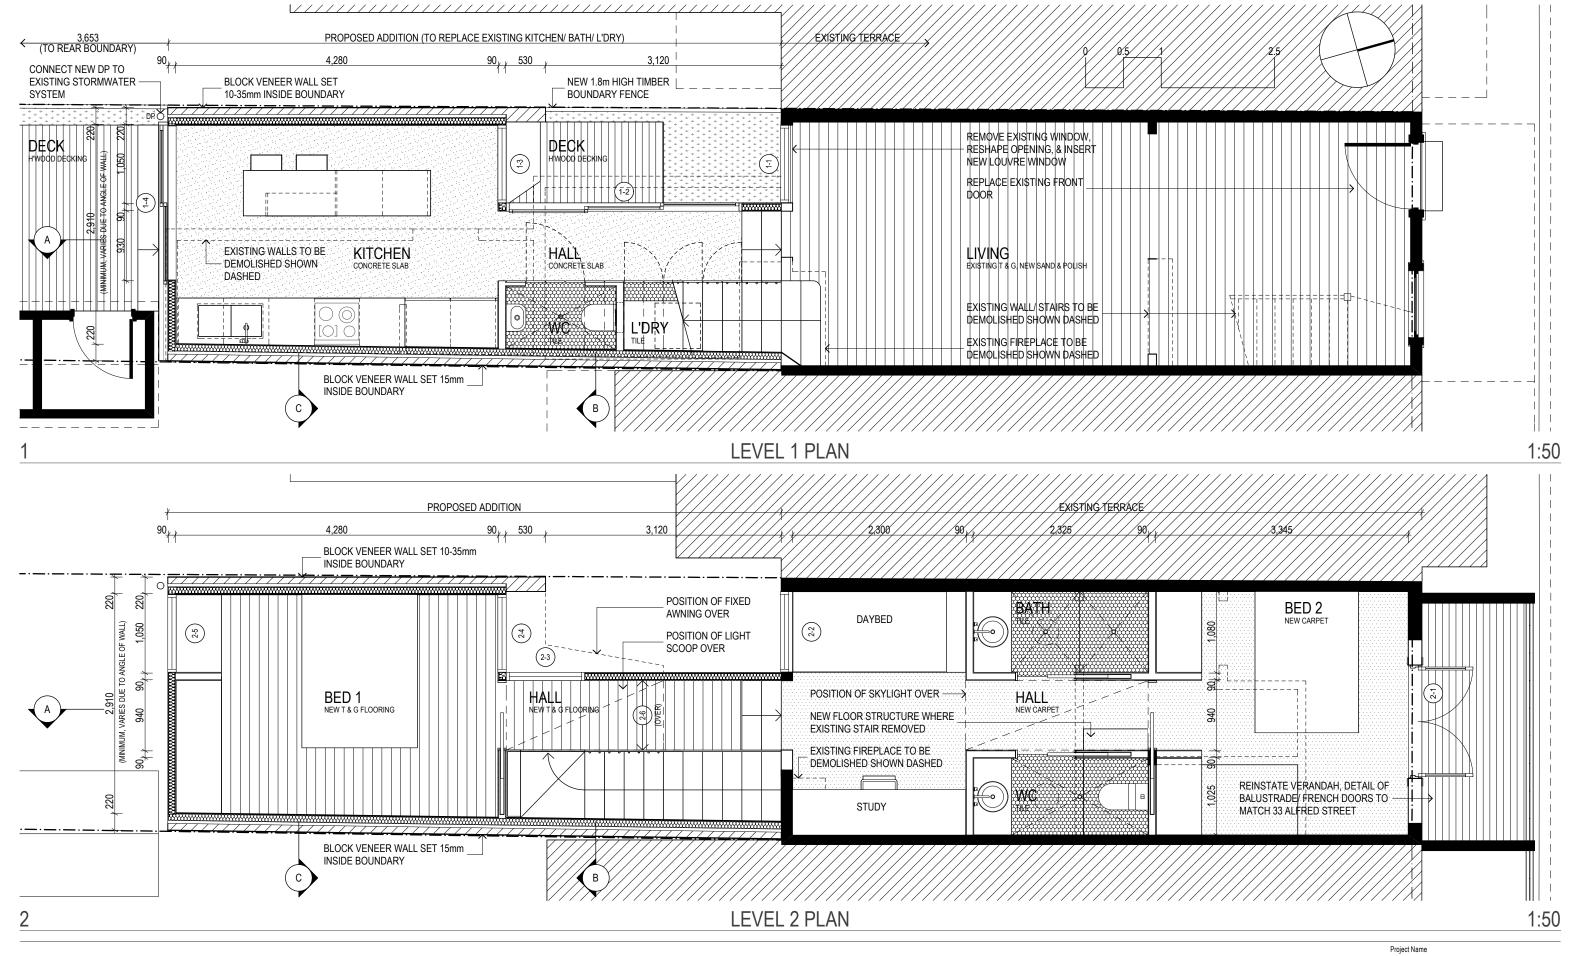


ISSUE FOR CLIENT APPROVAL 03/07/18
ISSUE TO CLIENT 26/09/17

SCARBOROUGH

FLOOR PLANS


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ISSUE FOR CLIENT APPROVAL 03/07/18
ISSUE TO CLIENT 26/09/17 DATE

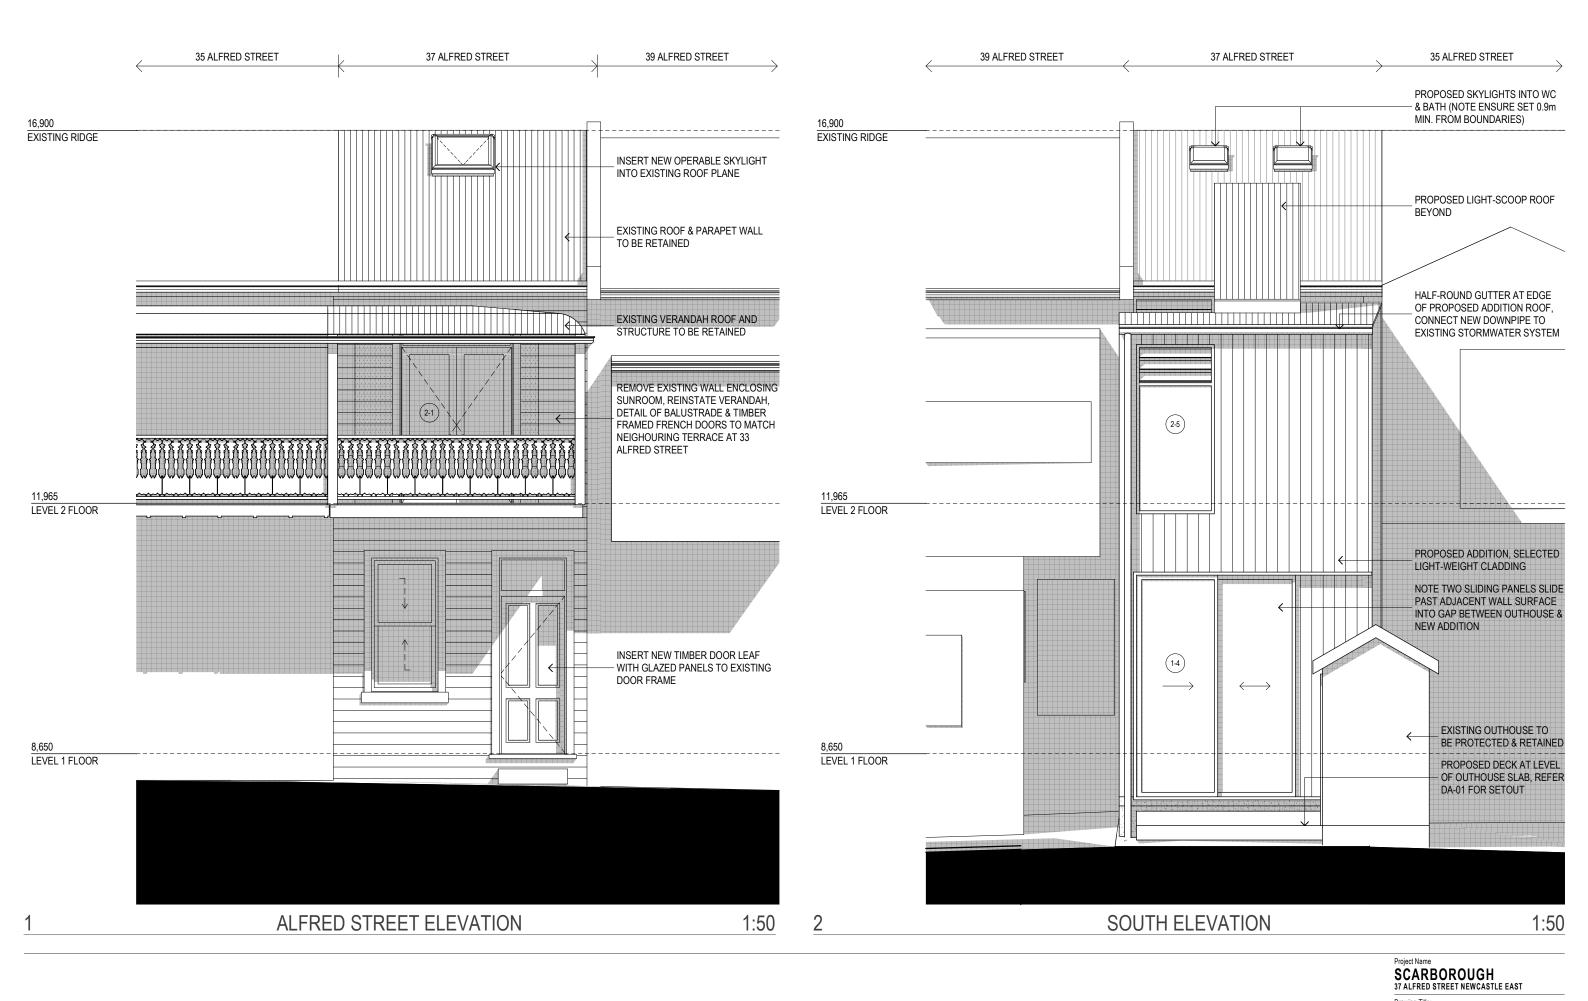ELEVATIONS Status: DEVELOPMENT APPLICATION

Project No: 497 DA-04 Z:\497 Scarborough\CURRENT\497 D03.pln



ISSUE FOR CLIENT APPROVAL 03/07/18
ISSUE TO CLIENT 26/09/17 DATE

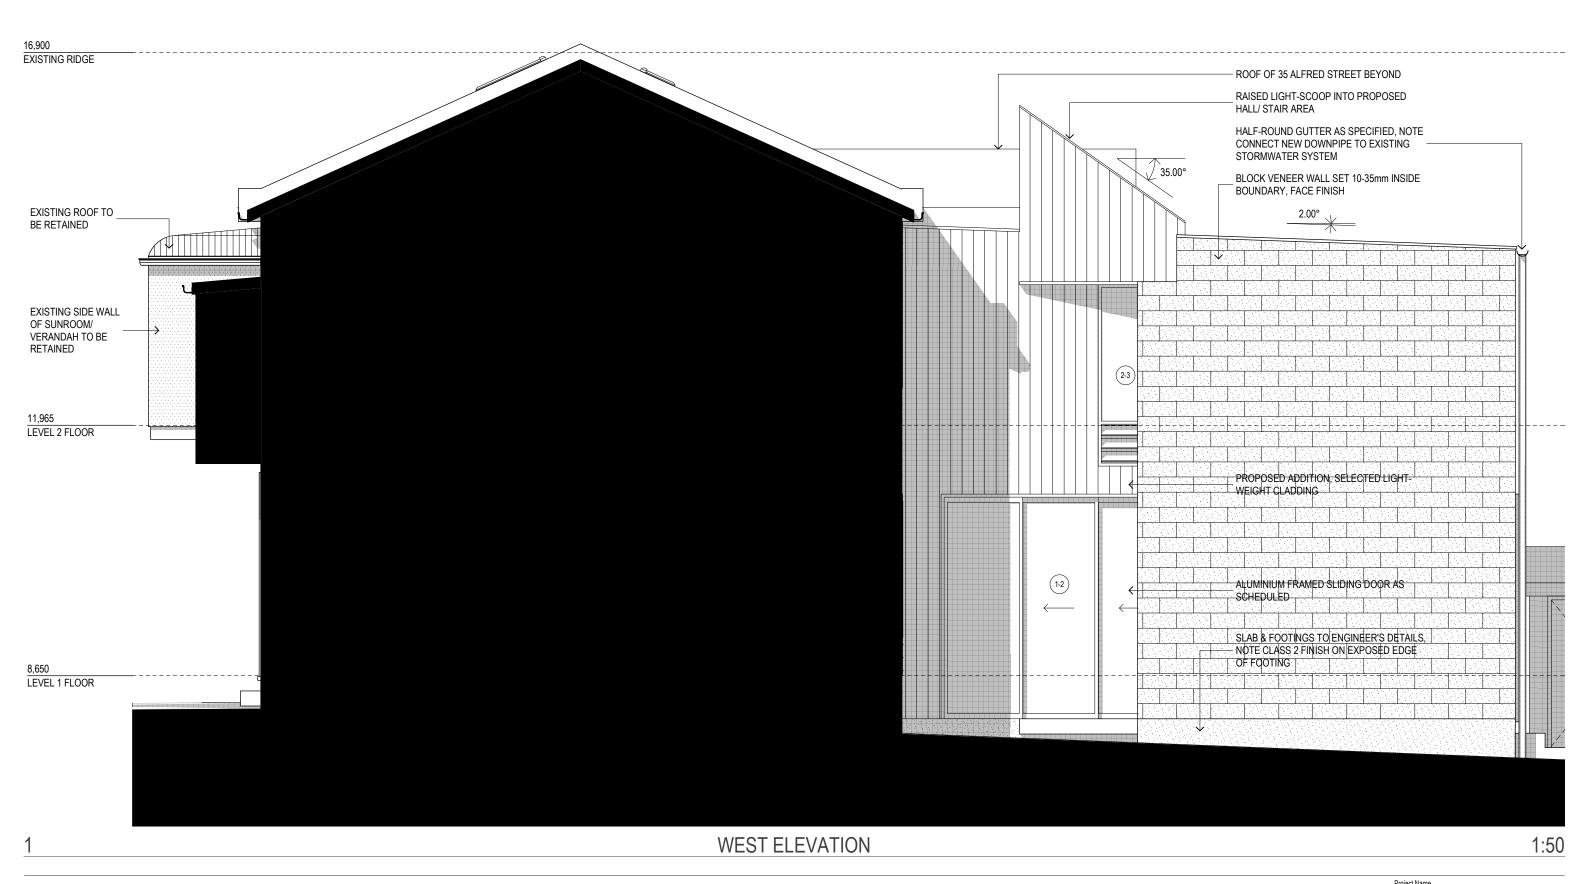
SCARBOROUGH
37 ALFRED STREET NEWCASTLE EAST

WEST ELEVATION

Status: DEVELOPMENT APPLICATION Project No:

497 **DA-05** Z:\497 Scarborough\CURRENT\497 D03.pln


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NEWCASTLE, NSW 2300 TO 24929 1450 To 24929 To 24929 1450 To 24929 1450 To 24929 1450 To 24929 1450 To 24929

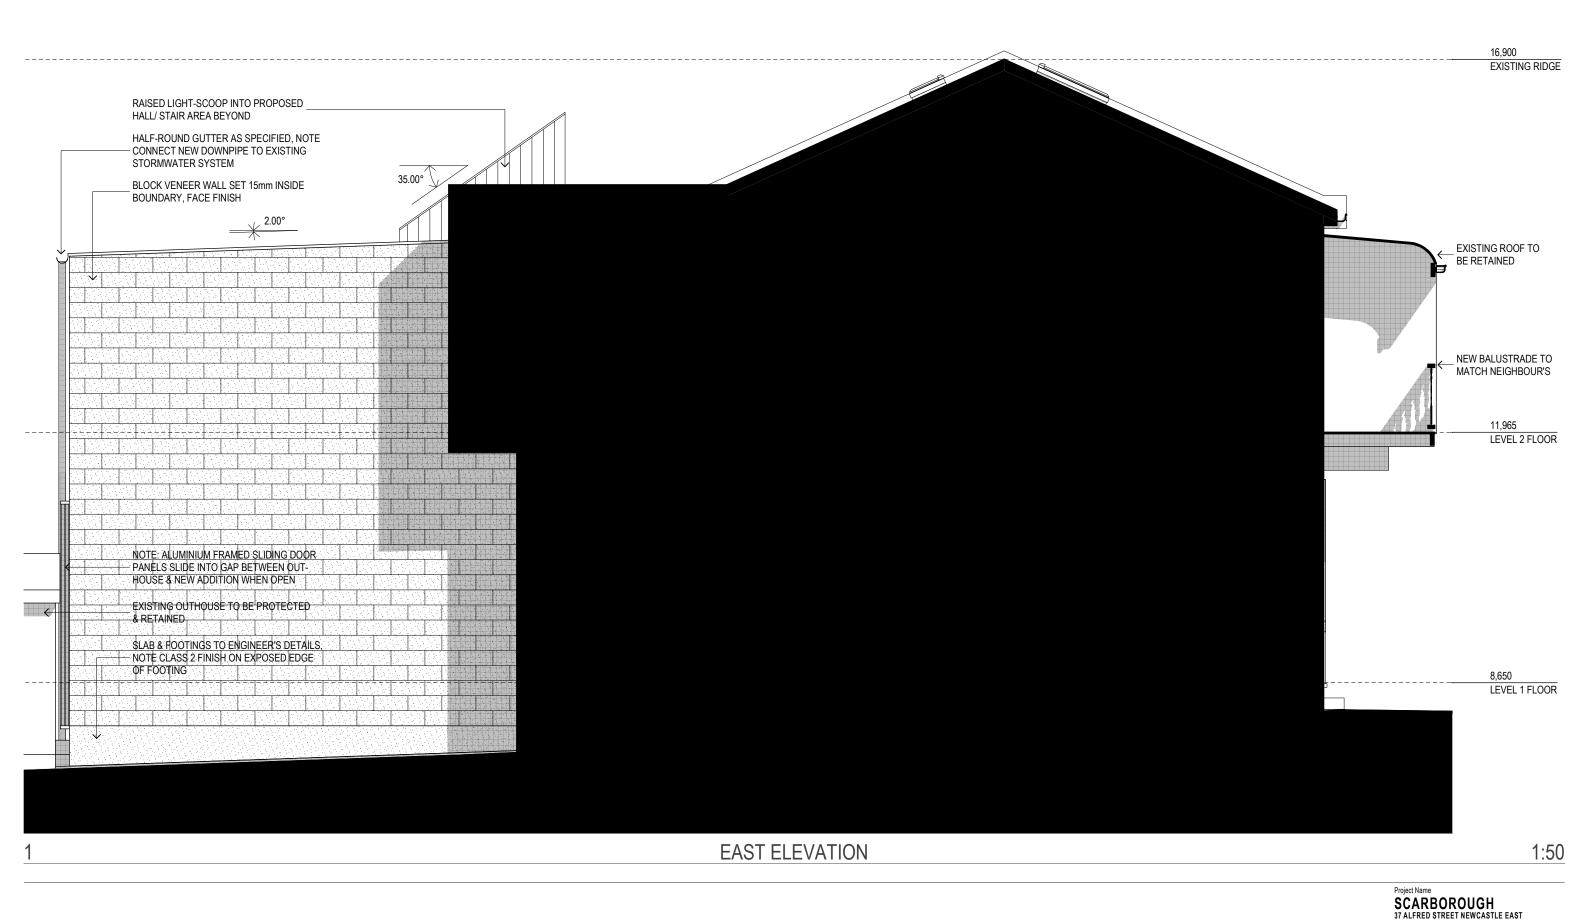

DA ISSUE ISSUE FOR CLIENT APPROVAL 03/07/18
ISSUE TO CLIENT 26/09/17 DATE

EAST ELEVATION Status: DEVELOPMENT APPLICATION Project No: Drawing No.:


497 **DA-06** Z:\497 Scarborough\CURRENT\497 D03.pln

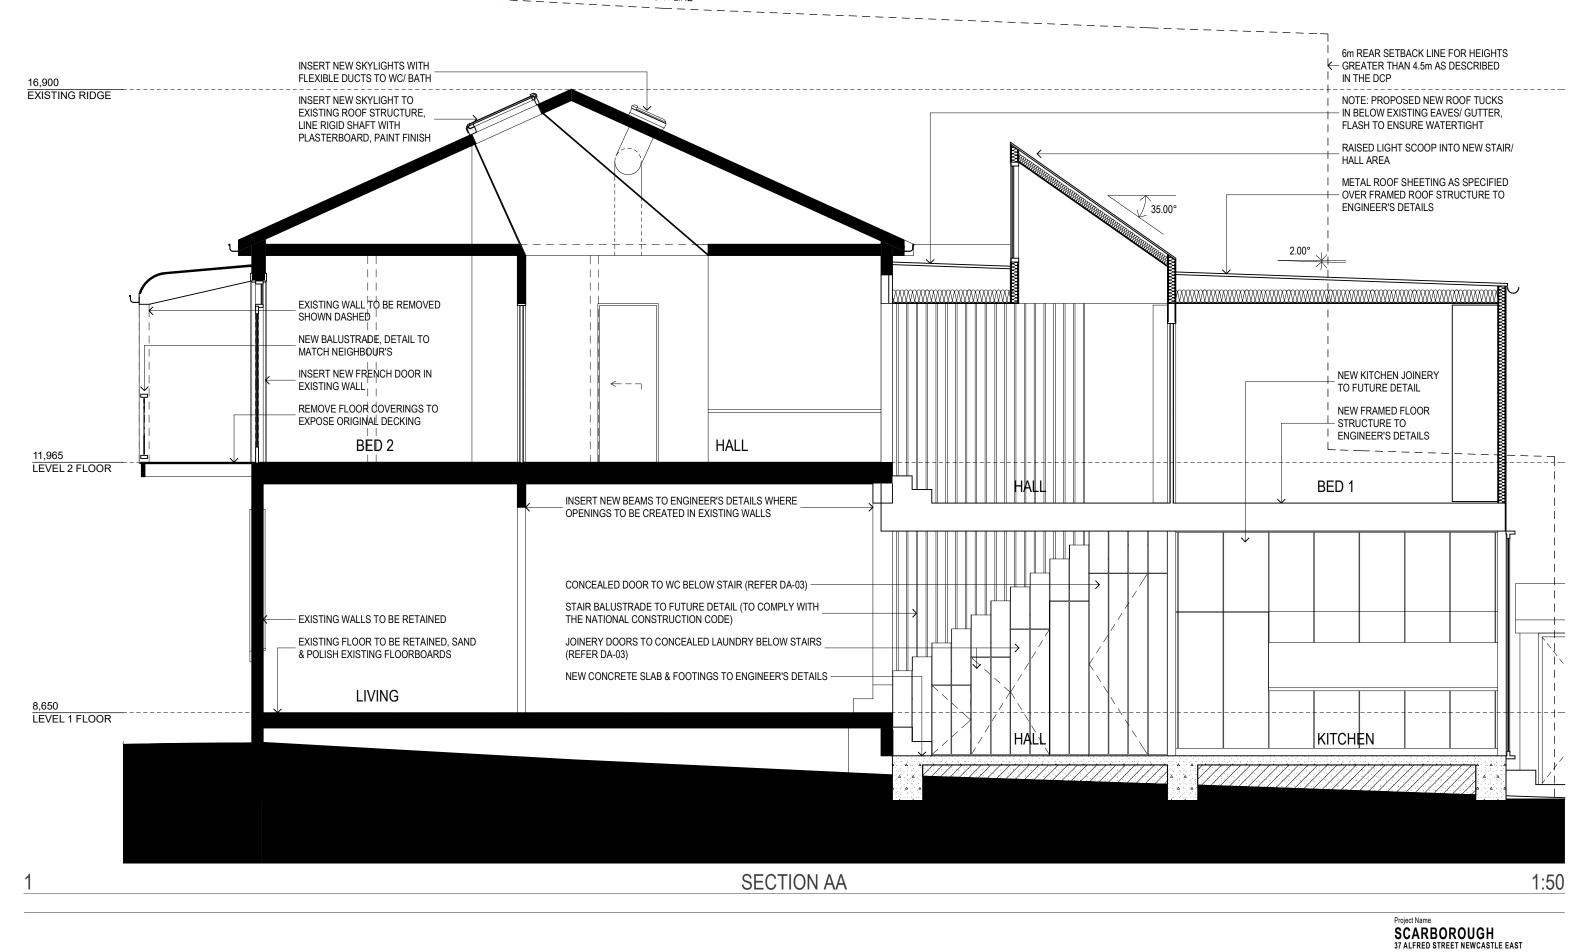

ISSUE FOR CLIENT APPROVAL 03/07/18
ISSUE TO CLIENT 26/09/17

SECTION AA Status: DEVELOPMENT APPLICATION Project No:

497 **DA-07** Z:\497 Scarborough\CURRENT\497 D03.pln

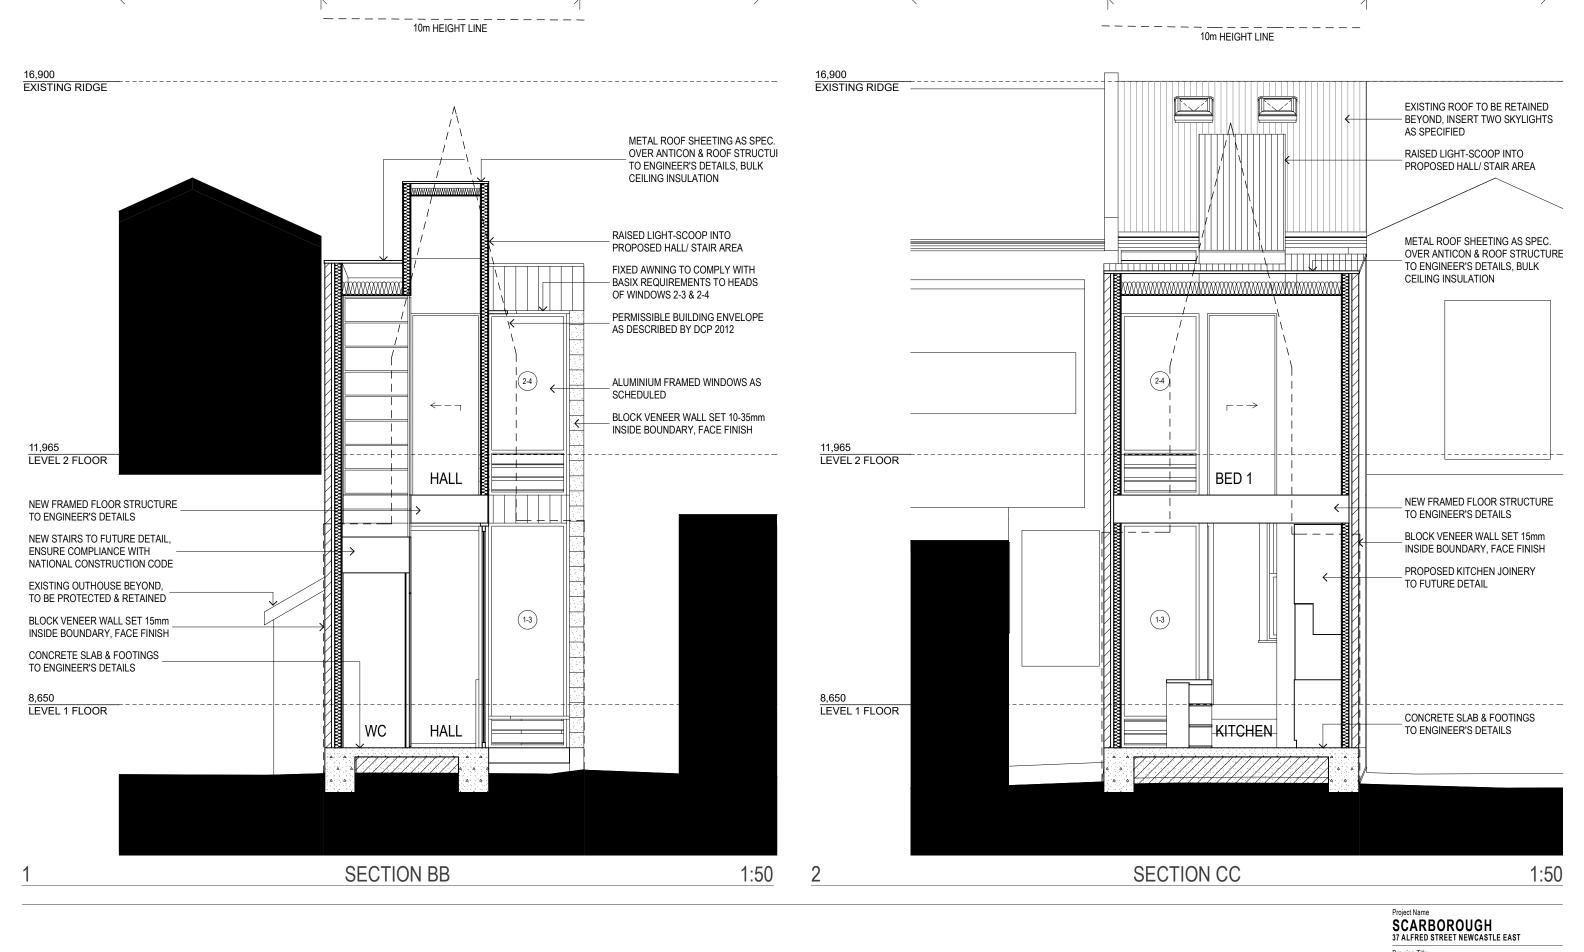

39 ALFRED STREET

BOURNE+BLUE ARCHITECTURE 35 ALFRED STREET

37 ALFRED STREET

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C DA ISSUE 13/08/18
B ISSUE FOR CLIENT APPROVAL 03/07/18
A ISSUE TO CLIENT 26/09/17
ISSUE AMENDMENT DATE


37 ALFRED STREET

39 ALFRED STREET

SECTIONS BB & CC
Status: DEVELOPMENT APPLICATION

35 ALFRED STREET


Project No: Drawing No.: DA-08

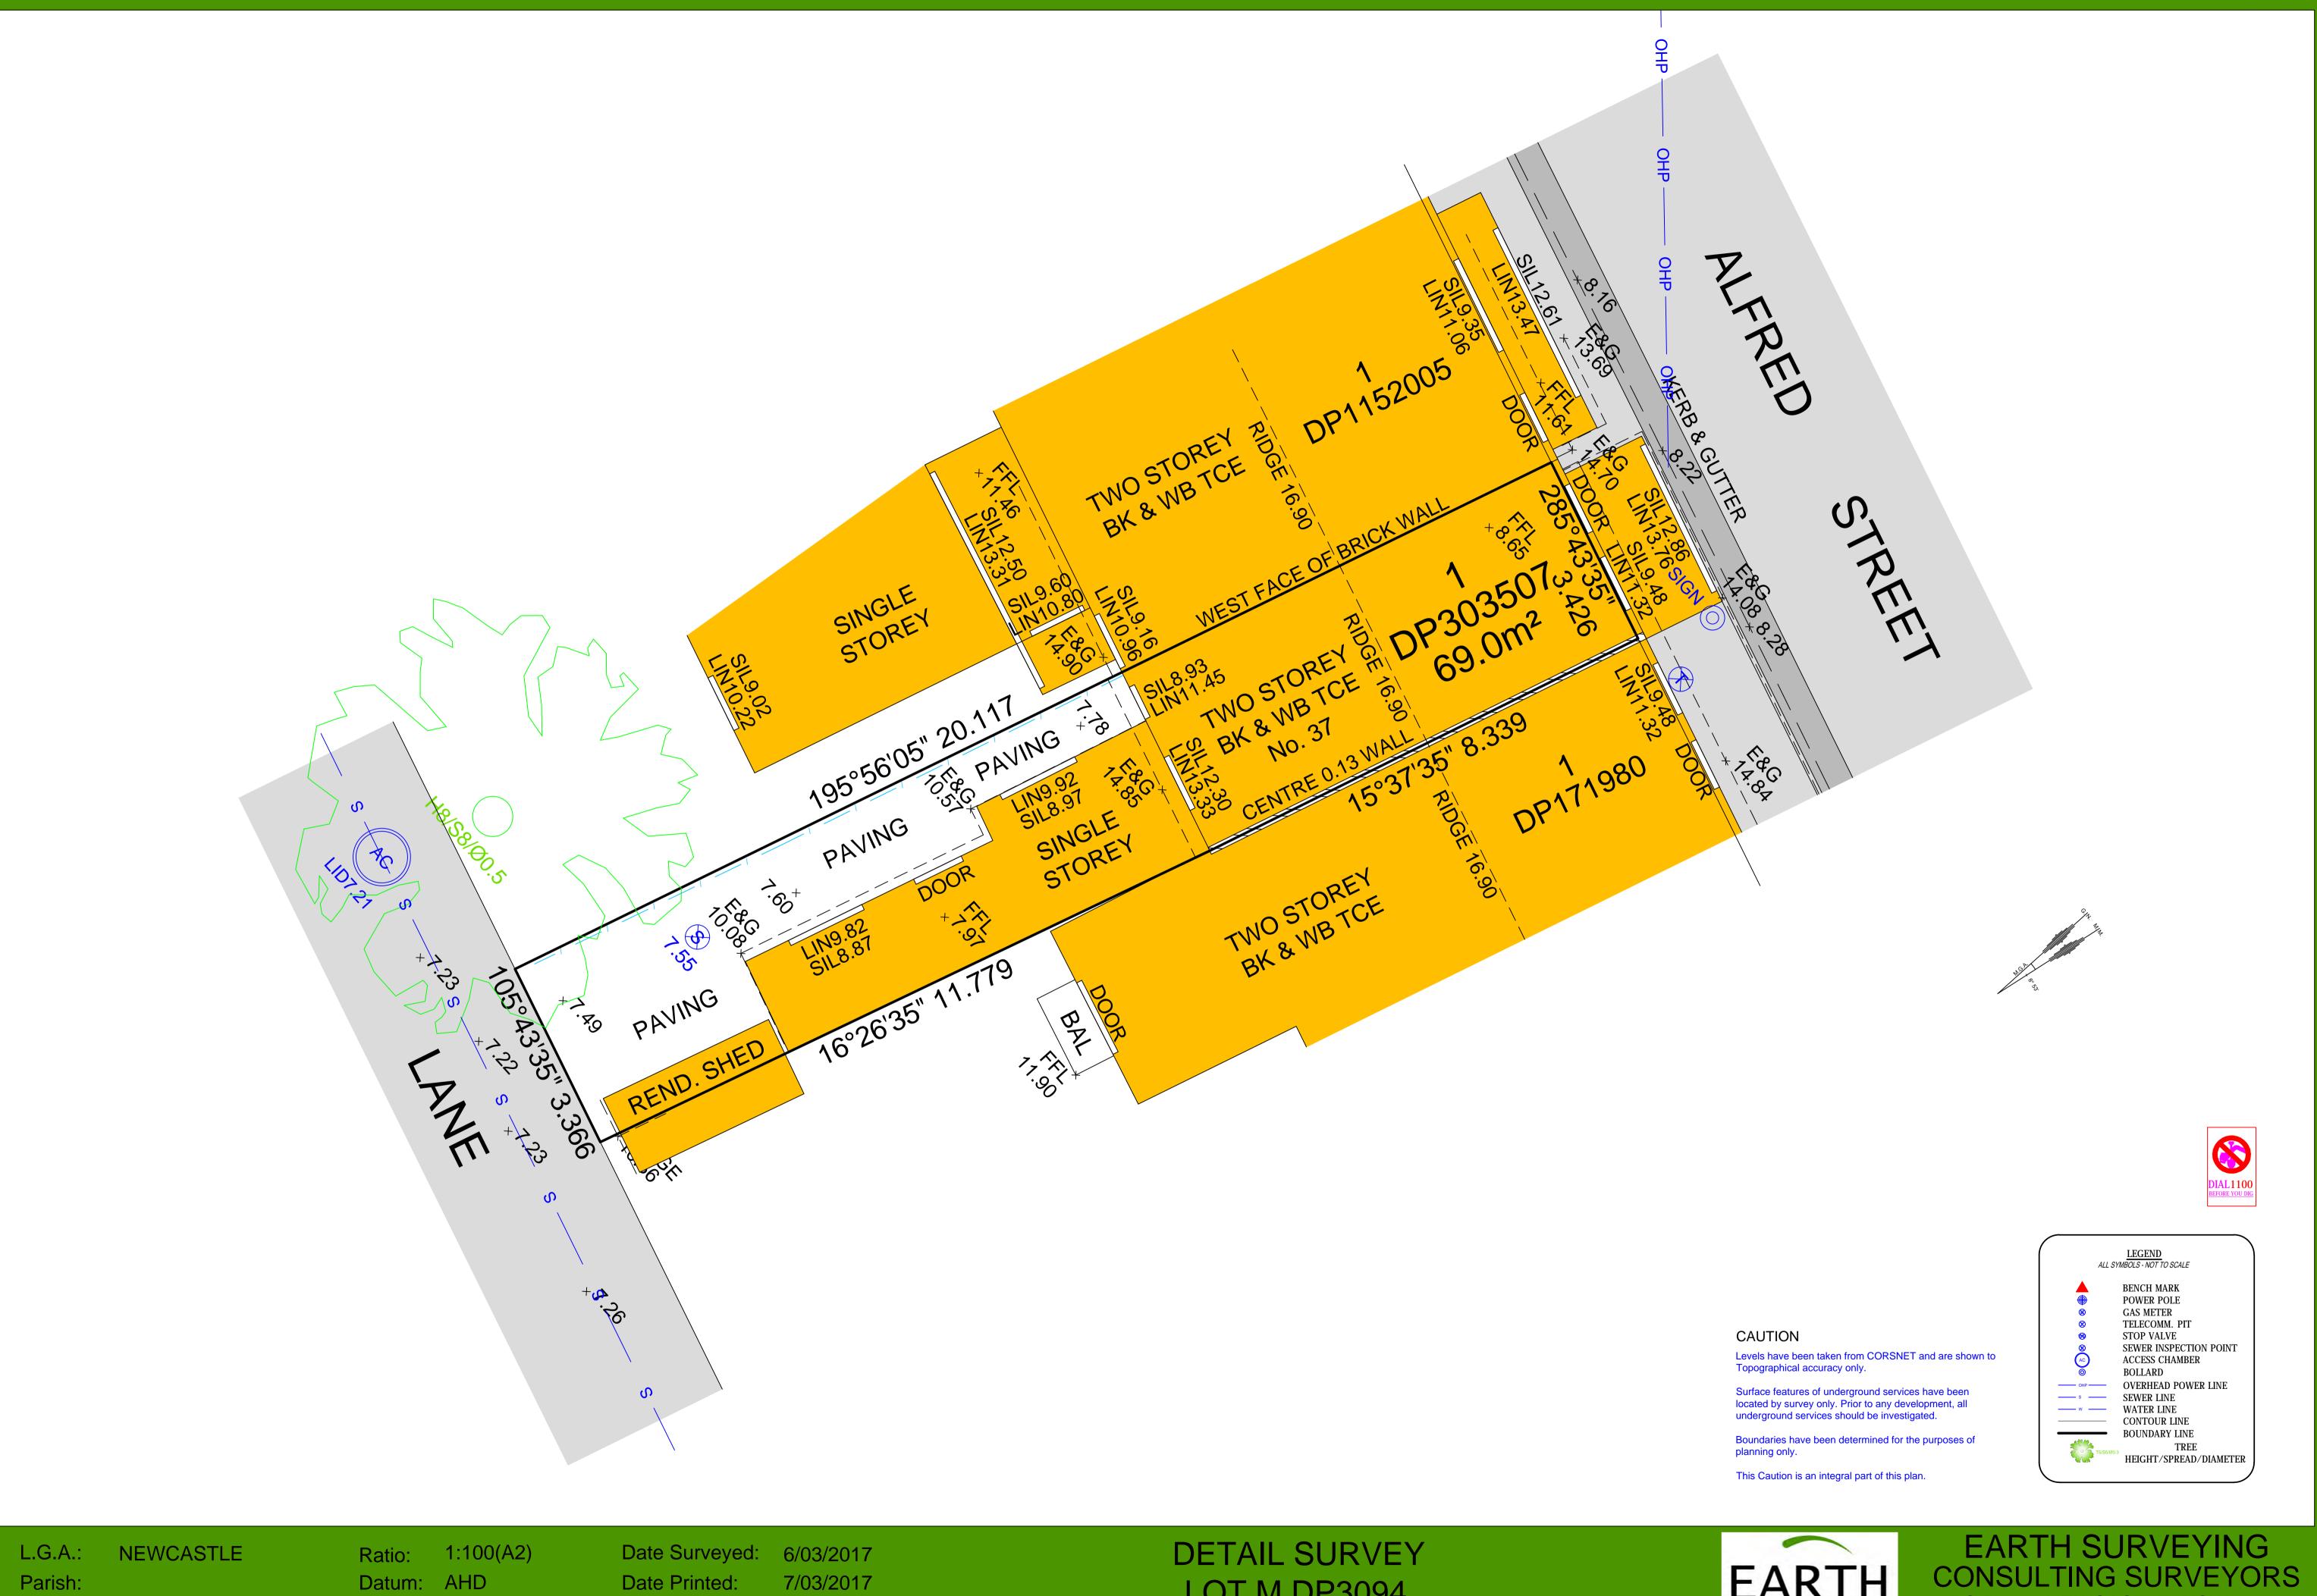

LOT M DP3094 NEWCASTLE EAST Origin: Reference: 100180 Locality 37 ALFRED STREET, NEWCASTLE EAST BOURNEBLUE 100180_1.dwg Drawn: AM Client: Drawing:

EARTH

PO Box 4, NEWCASTLE NSW 2300 02 4929 1900 0405 223133 andrew@earthsurveying.com.au

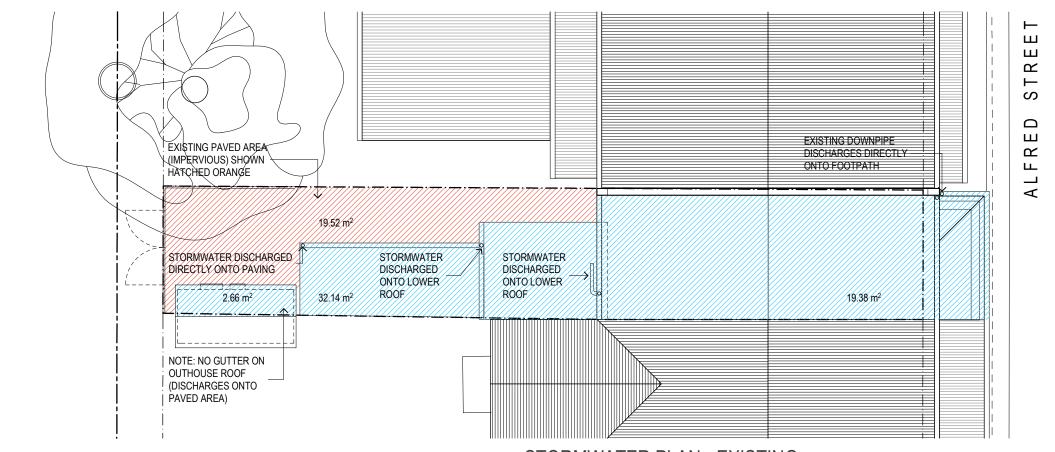



1:100

1:100

EXISTING STORMWATER ARRANGEMENTS

NOTE: 100% OF STORMWATER IS CURRENTLY UN-MANAGED.

73.7m² UN-MANAGED STORMWATER: REAR LEAN-TO ROOFS (32.14m²) & OUTHOUSE ROOF (2.66m²) AS SHOWN HATCHED LIGHT BLUE + PAVING AREA (19.52m²) AS SHOWN HATCHED ORANGE

NOTE: NO PERVIOUS AREA

NOTE: THERE DO NOT APPEAR TO BE ANY STORMWATER PITS LOCATED IN THE EXISTING REAR PAVED AREA OR IN THE ADJACENT REAR LANE.

STORMWATER PLAN - EXISTING

ш ш \propto \vdash ഗ NEW SIDE COURTYARD IS PERVIOUS (SOFT LANDSCAPING & DECK WITH SPACED DECKING) ш CONNECT NEW DOWNPIPE TO ALFRED NEW STORMWATER PIPE TO MODIFY EXISTING DOWNPIPE \propto PROPOSED STORMWATER ARRANGEMENTS STREET KERB VIA CHARGED & SEALED RUN THROUGH EXISTING TO BE PIPED TO ALFRED STREET + ட 57.37m² STORMWATER PIPED TO COUNCIL STORMWATER SYSTEM AT LINE (AS SHOWN DASHED) SUBFLOOR AREA ALFRED STREET KERB: FRONT ROOF (19.38m²) + REAR ROOFS (37.99m²) \triangleleft AS SHOWN HATCHED DARK BLUE **2.66m²** UN-MANAGED STORMWATER: OUTHOUSE ROOF AS SHOWN HATCHED LIGHT BLUE - NOTE THIS NOW DISCHARGES ONTO PERVIOUS 4.23 m² AREA RATHER THAN PAVING. 13.54m² PERVIOUS AREA: SIDE COURTYARD (4.23m²) + REAR YARD AREA (9.31m²) AS SHOWN HATCHED GREEN. NOTE: NEW CHARGED & SEALED STORMWATER LINE TO BE 100mm SEWER GAUGE UPVC PIPE 2.66 m² 37.99 m² 19.38 m² NOTE: NO GUTTER ON EXISTING OUTHOUSE ROOF (DISCHARGES ONTO NEW PERVIOUS AREA) NOTE: REAR YARD AREA IS NOW PERVIOUS (SOFT LANDSCAPING & DECK WITH SPACED DECKING) STORMWATER PLAN - PROPOSED

SCARBOROUGH

STORMWATER PLAN

Status: DEVELOPMENT APPLICATION

Project No: DA-09

497

BOURNE + BLUE ARCHITECTURE

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MODIFIED ISSUE

DA ISSUE

15/04/19 11/04/19