Development Applications Committee Meeting 16 November 2021



ATTACHMENTS DISTRIBUTED UNDER SEPARATE COVER

DAC 16/11/21 - 57A Henry Street Tighes Hill - DA2020/01328 - Multi Dwelling housing – demolition of existing structures, erection of three storey dwellings and 1 into 3 lot subdivision.

PAGE	3	ITEM-22	Attachment A:	Submitted Plans
PAGE	28	ITEM-22	Attachment B:	Draft Schedule of Conditions
PAGE	41	ITEM-22	Attachment C:	Processing Chronology

Development Applications Committee Meeting 16 November 2021





ATTACHMENTS DISTRIBUTED UNDER SEPARATE COVER

DAC 16/11/21 - 57A Henry Street Tighes Hill - DA2020/01328 - Multi Dwelling housing – demolition of existing structures, erection of three storey dwellings and 1 into 3 lot subdivision.

ITEM-22 Attachment A: Submitted Plans

Development Applications Committee Meeting 16 November 2021



DEVELOPMENT APPLICATION 20071

Multi-Dwelling - 57a Henry Street, Tighes Hill

Linefront Pty Ltd

SCHEDU	LE OF DRAWINGS
DA000	COVER PAGE
DA010	SITE ANALYSIS PLAN
DA011	AREA ANALYSIS PLAN
DA020	DEMOLITION PLAN
DA030	SITE PLAN
DA035	SITE COVERAGE PLAN
DA040	PERSPECTIVES
DA100	GROUND FLOOR
DA110	FIRST FLOOR
DA150	ROOF PLAN
DA300	ELEVATIONS
DA301	ELEVATIONS
DA302	ELEVATIONS
DA350	EXTERNAL FINISHES
DA400	SECTIONS
DA900	EXTERNAL SHADOW DIAGRAMS
DA901	EXTERNAL SHADOW DIAGRAMS
DA960	SEDIMENT CONTROL



SUBJECT SITE



SITE LOCATION

Survey By: DELF LASCELLES Ref: 20414 Date: 22-07-20

ontained in the document is copyright and may not be used or

other project or purpose.
ns and levels on site and report any discrepancies prior to the
work and any ordering of materials.
e read in conjunction with all contract documents.

PO Box 601 Kotara

NSW 2289 Ph 49524425 Nominated Architect: Daniel Hadley 8209

n: 02 4964 4886

: 0412582966



For Review For Review For Authority Approva RFI Amendments

20/08/2020 26/08/2020 1/10/2020 9/11/2020 21/01/2021 6/04/2021

Linefront Pty Ltd

Multi-Dwelling 57a Henry Street **Tiahes Hill**

ENERGY COMMITMENTS

Lighting (Primarily li by fluoro or LED)

OTHER COMMITMENTS

DMN Assessor #16/1742

eferenced documentation.

External Wall Constructi

Cavity wall, direct fix

Floor Construction 225mm Waffle Pod Slah

GJA-011-21 A Aluminium framed 6EA Fixed Windows Single Glazed GJA-013-25 A Aluminium framed 6EA Sliding Windows Single Glazed

6EA Sliding Doors Single Glazed

ontact Evergreen Energy Consultants.

7th September 2021 Reference: 264/2020

Ph: 1300 584 010

Timber Carnet Tiles and Bare

Evergreen Energy Consultants

Important Note for Development Applicants: The following specification was used to achieve the thermal performance values indicated on the Assessor Cortificate. If they vary from drawings or other specifications this Specification shall take precedence. If only one specification option is detailed for a building element, that specification must apply to all instances of that element for the whole project. If alternate specifications are detailed, th ocation and extent of the alternate specification must be detailed below and / or clearly indicated or

condition of consent and must be included in the built works. If you do not want to include these requirements, the proposed construction varies to those detailed or need further information, please

This assessment has assumed that the BCA provisions for building sealing will be complied with a

gap R2.5

Bulk, reflective side dow no air gap above R1.3 Bulk, reflective side dow no air gap above R1.3

Shaded areas and shade devices as drawn, adjoining buildings and boundary fences

For construction in NSW the BCA Vol 1 or 2 must be complied with, in particular the following: Thermal construction in accordance with Vol 1 Section J1.2 or Vol 2 Part 3.12.1.1 Thermal breaks in accordance with Section J1.3(d) & 1.5(c) or Part 3.12.1.2(c) & 3.12.1.4(b) Compensating for loss of ceiling insulation in accordance with Section J1.3(c) or Part 3.12.1.2(e) Floor insulation in accordance with Section J1.6(c) & (d) or Part 3.12.1.5(a)(iii) or (c) & (d) Building sealing in accordance with Section J3 or Part 3.12.3.1 to 3.12.3.6.

57a Henry Street, Tighes Hill SUMMARY OF BASIX COMMITMENTS

This is a summary of the BASIX Commitments as detailed in the BASIX Certificate.

Refer to the CURRENT BASIX Certificate for Complete details.

Bathrooms Fan ducted to roof/facade Manual on/of

Window/Skylight in Kitchen

COVER PAGE 1:1.06 @ A3

Ceiling fans + 1 phase air-conditioning 4.5 star (average zone)
Ceiling fans

FOR AUTHORITY APPROVAL ONLY NOT FOR CONSTRUCTION

DA000

Project Numbe

20071


PRELIMINARY



onsu	ıltants	

m: 0425 203 049

20/10/2021 QA CHECKED

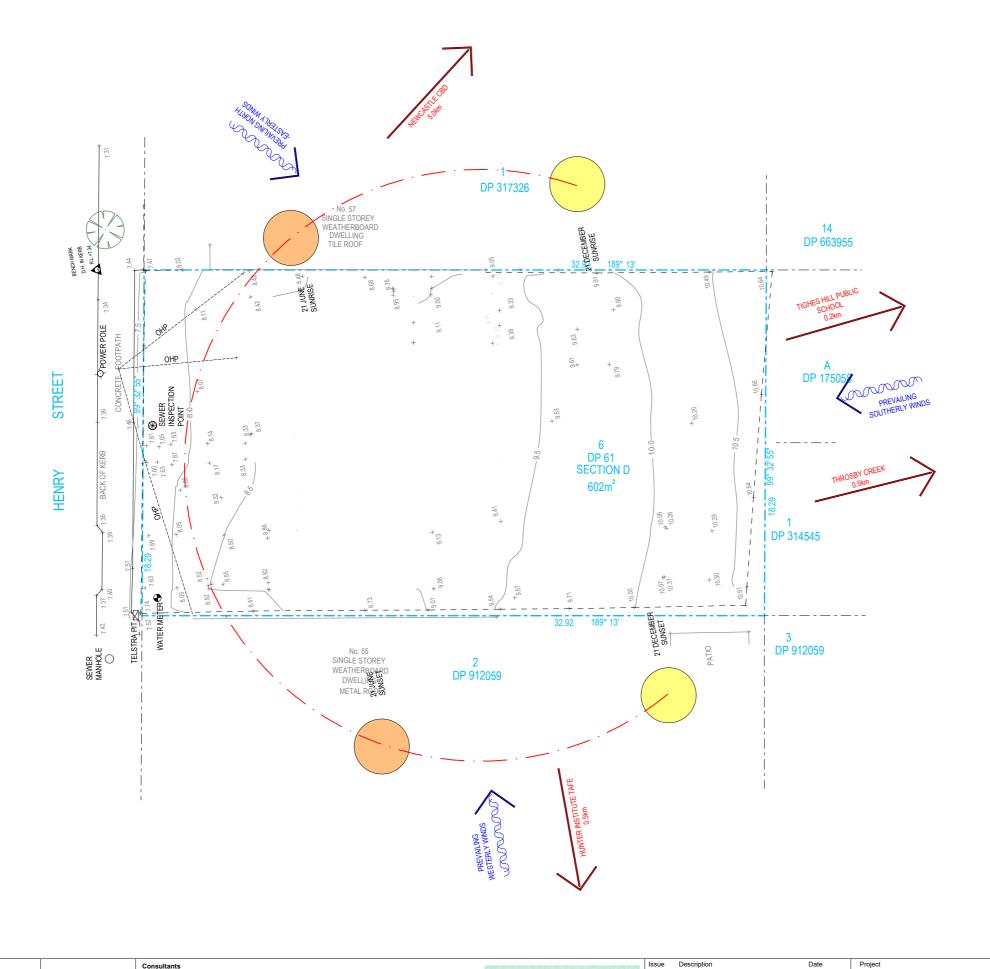

PRELIMINARY

FOR AUTHORITY APPROVAL ONLY NOT FOR CONSTRUCTION

PO Box 601 Kotara NSW 2289 Ph 49524425 Nominated Architect: Daniel Hadley 8209



Surveyor Delfs Lascelles p: 02 4964 4886 e: admin@delacs.com.au

Civil Engineer MPC Consulting Engineers p: 02 4927 5566 e: admin@mpceng.com.au Energy Assessor Evergreen Energy Consultants p: (02) 4975 5350 m: 0407 886 275 e: joseph@evergreenec.com.au

Arborist Abacus Tree Services m: 0425 203 049 e: abacustrees@gmail.com

Landscape Consultant JK's Gardencreations p: 0412582966 e: gardenflora704@gmail.com Town Planner Piper Planning Pty Ltd p: 0401660152 e: piperplanning.com.au

RFI Amendments

1/10/2020 9/11/2020

Multi-Dwelling 57a Henry Street

Tighes Hill Client
Linefront Pty Ltd DRAWN

TG

Drawing
SITE ANALYSIS PLAN @ A3 20/10/2021 QA CHECKED

sv

Drawing Number DA010 Issue B

Project Number



53 HENRY STREET TIGHES HILL




41 WILLIAMSON & 18 JOHN STREET TIGHES HILL





CRN HENRY & UNION STREET TIGHES HILL

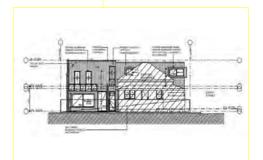

17 ELIZABETH STREET TIGHES HILL - DUAL OCCUPANCY



103 HENRY STREET TIGHES HILL - DUAL OCCUPANCY

FOR AUTHORITY APPROVAL ONLY

NOT FOR CONSTRUCTION

PO Box 601 Kotara NSW 2289 Ph 49524425 Nominated Architect: Daniel Hadley 8209



Surveyor Delfs Lascelles p: 02 4964 4886 e: admin@delacs.com.au

Energy Assessor Evergreen Energy Consultants p: (02) 4975 5350 m: 0407 886 275 e: joseph@evergreenec.com.au

Abacus Tree Services m: 0425 203 049 e: abacustrees@gmail.com

Town Planner Piper Planning Pty Ltd p: 0401660152 e: piperplanning.com.au

3/09/2021

Multi-Dwelling

57a Henry Street Tighes Hill

Client
Linefront Pty Ltd

TG

AREA ANALYSIS PLAN 20/10/2021 @ A3

Drawing Number DA011

QA CHECKED

Project Number

20071

PRELIMINARY






EXISTING TREE TO BE DEMOLISHED

EXISTING TREE TO BE RETAINED

TO BE DEMOLISHED

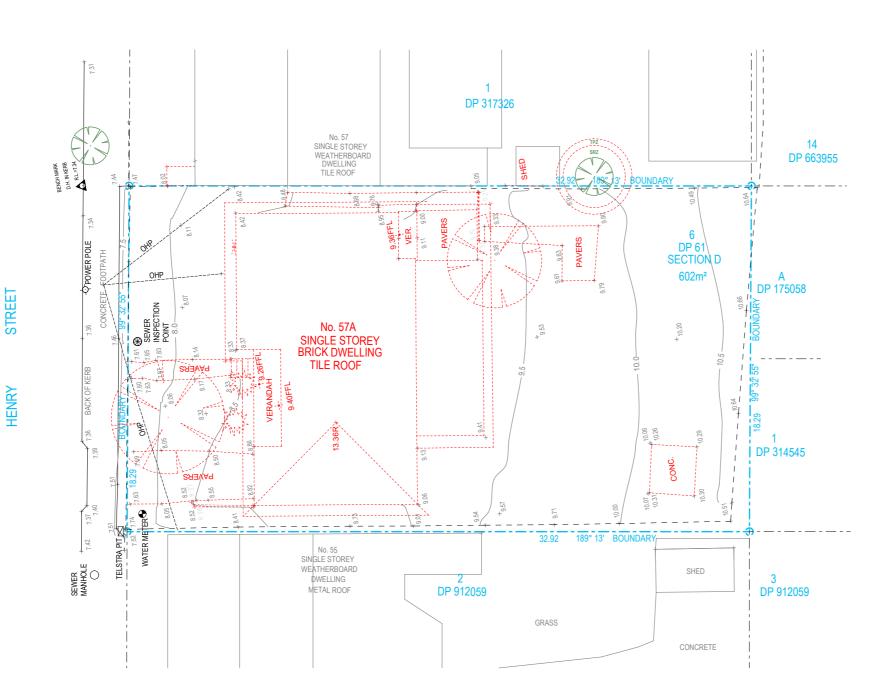

PRELIMINARY

FOR AUTHORITY APPROVAL ONLY NOT FOR CONSTRUCTION

PO Box 601 Kotara NSW 2289 Ph 49524425 Nominated Architect: Daniel Hadley 8209

on contained in the document is copyright and may not be used or or any other project or purpose, ensions and levels on site and report any discrepancies prior to the ent of work and any ordering of materials. to be read in conjunction with all contract documents.

Surveyor Delfs Lascelles p: 02 4964 4886 e: admin@delacs.com.au

Energy Assessor Evergreen Energy Consultants p: (02) 4975 5350 m: 0407 886 275

Civil Engineer MPC Consulting Engineers p: 02 4927 5566 e: admin@mpceng.com.au

Landscape Consultant JK's Gardencreations p: 0412582966 e: gardenflora704@gmail.com Arborist Abacus Tree Services m: 0425 203 049 e: abacustrees@gmail.com

Town Planner Piper Planning Pty Ltd p: 0401660152 e: piperplanning.com.au

Description For Authority Approval Development Application

2/09/2020 1/10/2020 9/11/2020 6/09/2021

Multi-Dwelling

57a Henry Street Tighes Hill Client
Linefront Pty Ltd


TG


DEMOLITION PLAN 1:200 @ A3 20/10/2021 QA CHECKED DRAWN

sv

Drawing Number DA020 В

Project Number

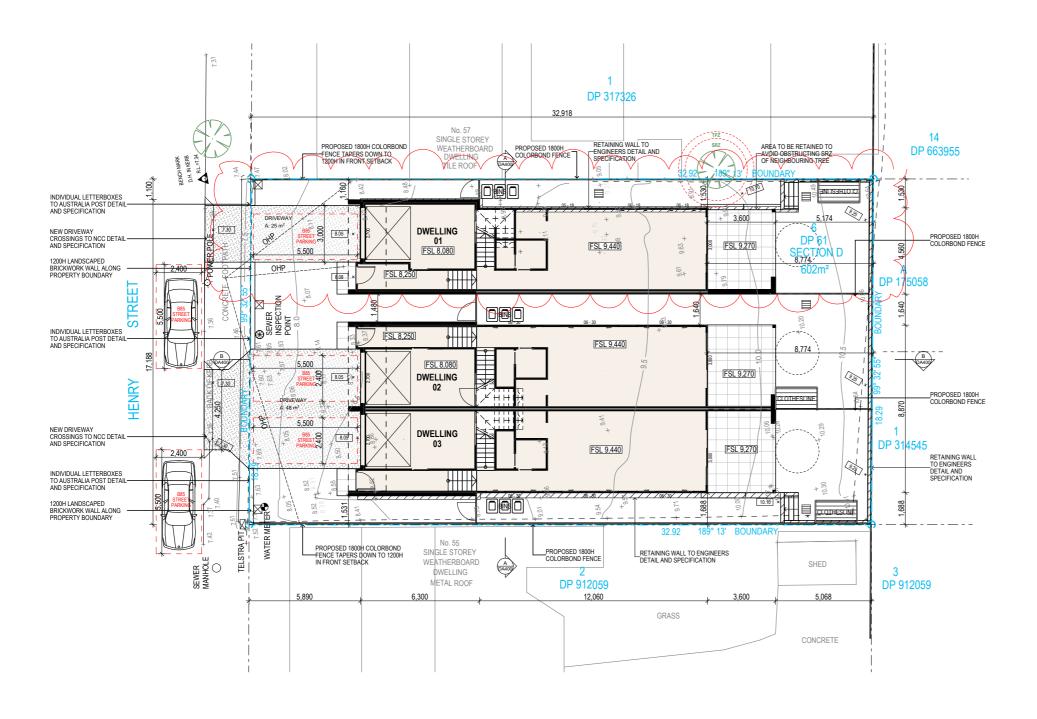

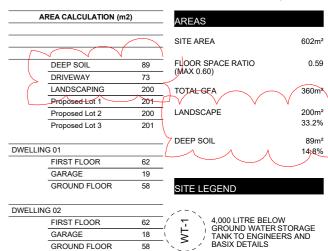

DWELLING 03 RW FIRST FLOOR 62 RETAINING WALLS TO ENGINEERS SPECIFICATIONS & DETAILS GARAGE 18 GROUND FLOOR 58



EXISTING TREE TO BE RETAINED



PROPOSED BUILDING FOOTPRINT

SITE NOTES

1. GFA (GROSS FLOOR AREA) AS DEFINED BY THE LOCAL COUNCIL

2 PLEASE REFER TO CONSULTING ENGINEERS
DRAWINGS FOR STORMWATER
DETAILS

3. FOR ROADWAY, DRIVEWAY AND RETAINING WALL DESIGN & LEVELS REFER TO CIVIL ENGINEERS DOCUMENTATION

4. DOWNPIPE POSITIONS ARE INDICATIVE ONLY, POSITION OF DOWNPIPES TO BE CONFIRMED BY HYDRAULIC ENGINEER OR BUILDER.

5. FOR LANDSCAPE DESIGN & FENCE LOCATIONS REFER TO LANDSCAPE DESIGNERS DOCUMENTATION

PRELIMINARY

FOR AUTHORITY APPROVAL ONLY NOT FOR CONSTRUCTION

PO Box 601 Kotara NSW 2289 Ph 49524425 Nominated Architect: Daniel Hadley 8209

mation contained in the document is copyright and may not be used or ed for any other project or purpose. dimensions and levels on site and report any discrepancies prior to the cement of work and any ordering of materials. are to be read in conjunction with all contract documents.



Consultants

n: 02 4964 4886

Evergreen Energy Consultants p: (02) 4975 5350 m: 0407 886 275

Civil Engineer MPC Consulting Engineers p: 02 4927 5566 e: admin@mpceng.com.au

Abacus Tree Services

e: abacustrees@gmail.com

m: 0425 203 049

p: 0412582966 Town Planner Piper Planning Pty Ltd p: 0401660152



Description RFI Amendments For Information RFI Amendments RFI Amendments RFI Amendments RFI Amendments

RFI Amendments

7/05/2021 15/07/2021 3/09/2021 6/09/2021 11/10/2021 12/10/2021 19/10/2021


20/10/2021

Multi-Dwelling 57a Henry Street **Tighes Hill Linefront Pty Ltd** SITE PLAN

1:200 @ A3 20/10/2021 QA CHECKED DRAWN TG sv

Drawing Number DA030 Project Numbe




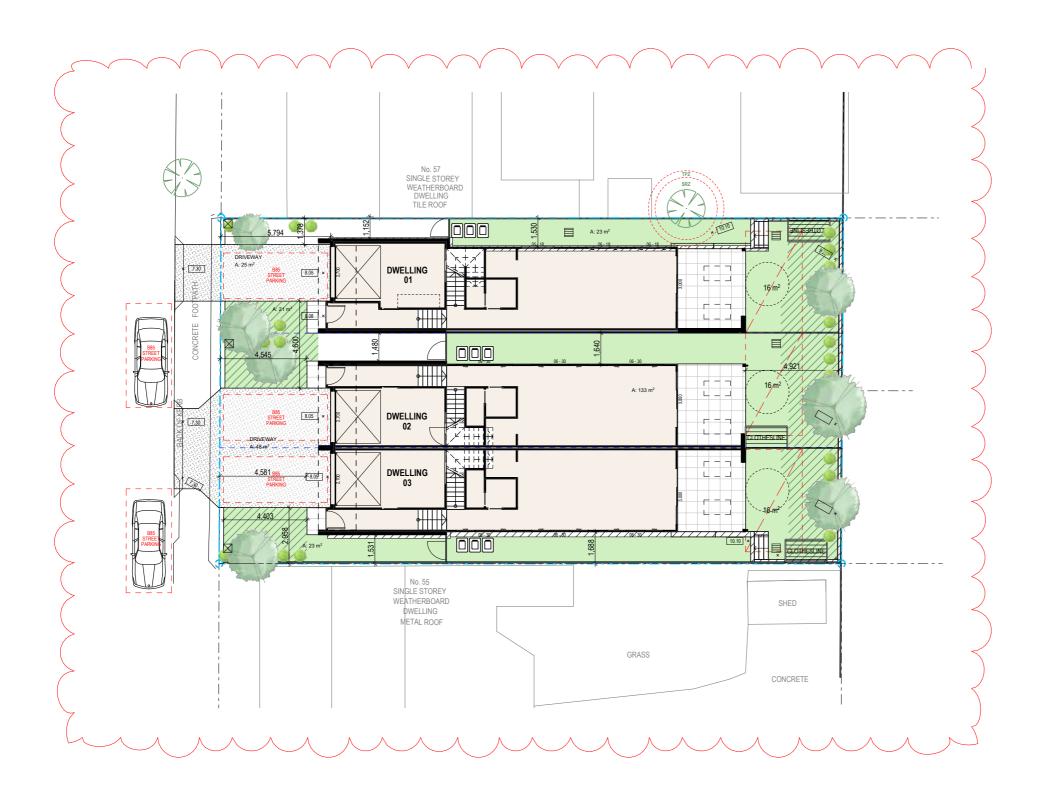

SITE COVERAGE LEGEND

PROPOSED BUILDING FOOTPRINT



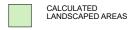



PRIVATE OPEN SPACE



SITE COVERAGE NOTES

1. PLEASE REFER TO CONSULTING ENGINEERS DRAWINGS FOR STORMWATER DETAILS

2. FOR ROADWAY, DRIVEWAY AND RETAINING WALL DESIGN & LEVELS REFER TO CIVIL ENGINEERS DOCUMENTATION

3. FOR LANDSCAPE DESIGN & FENCE LOCATIONS REFER TO LANDSCAPE DESIGNERS DOCUMENTATION

PRELIMINARY

FOR AUTHORITY APPROVAL ONLY NOT FOR CONSTRUCTION

PO Box 601 Kotara

NSW 2289 Ph 49524425

Nominated Architect: Daniel Hadley 8209

Notes

The information contained in the document is copyright and may not be used or reproduced for any other project or purpose

Verify all dimensions and levels on site and report any discrepancies prior to the commencement of work and any ordering of materials.

Drawings are to be read in conjunction with all contract documents.

Use figured dimensions only. Do not scale from drawings.

ELK Designs cannot guarantee the accuracy of content and format for copies of drawin issued electronically.

The completion of the issue details checked and authorised section below is conformati of the status of the drawing had into be used for construction unless endorsed For Construction* and authorised for issue.



Consultants

p: 02 4964 4886

Civil Engineer MPC Consulting Engineers p: 02 4927 5566 e: admin@mpceng.com.au Energy Assessor Evergreen Energy Consultants p: (02) 4975 5350 m: 0407 886 275 Abacus Tree Services m: 0425 203 049 e: abacustrees@gmail.com

Landscape Consultant JK's Gardencreations p: 0412582966 e: gardenflora704@gmail.com

Town Planner Piper Planning Pty Ltd p: 0401660152 e: piperplanning.com.au



Description RFI Amendments For Information RFI Amendments RFI Amendments

RFI Amendments

RFI Amendments

RFI Amendments

3/09/2021 6/09/2021 19/10/2021 20/10/2021

7/05/2021 15/07/2021 11/10/2021 12/10/2021

Multi-Dwelling 57a Henry Street Tighes Hill

Linefront Pty Ltd

SITE COVERAGE PLAN 1:200 @ A3

TG

20/10/2021 DRAWN QA CHECKED

sv

Drawing Number DA035

20071

Project Number





VIEW FROM HENRY STREET



VIEW FROM HENRY STREET

PRELIMINARY

FOR AUTHORITY APPROVAL ONLY NOT FOR CONSTRUCTION

PO Box 601 Kotara NSW 2289 Ph 49524425 Nominated Architect: Daniel Hadley 8209

n contained in the document is copyright and may not be used or rany other project or purpose. issions and levels on site and report any discrepancies prior to the nt of work and any ordering of materials. to be read in conjunction with all contract documents.

Surveyor Delfs Lascelles p: 02 4964 4886 e: admin@delacs.com.au

Energy Assessor Evergreen Energy Consultants p: (02) 4975 5350 m: 0407 886 275 e: joseph@evergreenec.com.au

Civil Engineer MPC Consulting Engineers p: 02 4927 5566 e: admin@mpceng.com.au

Arborist Abacus Tree Services m: 0425 203 049 e: abacustrees@gmail.com

Town Planner Piper Planning Pty Ltd p: 0401660152 e: piperplanning.com.au



For Review For Review For Authority Approval

RFI Amendments

15/07/2021 6/09/2021 RFI Amendments

10/09/2020 14/09/2020 1/10/2020 9/11/2020

Multi-Dwelling

57a Henry Street Tighes Hill Client
Linefront Pty Ltd

Drawing PERSPECTIVES


TG


20/10/2021 @ A3 QA CHECKED DRAWN


Drawing Number DA040

Issue D Project Number 20071



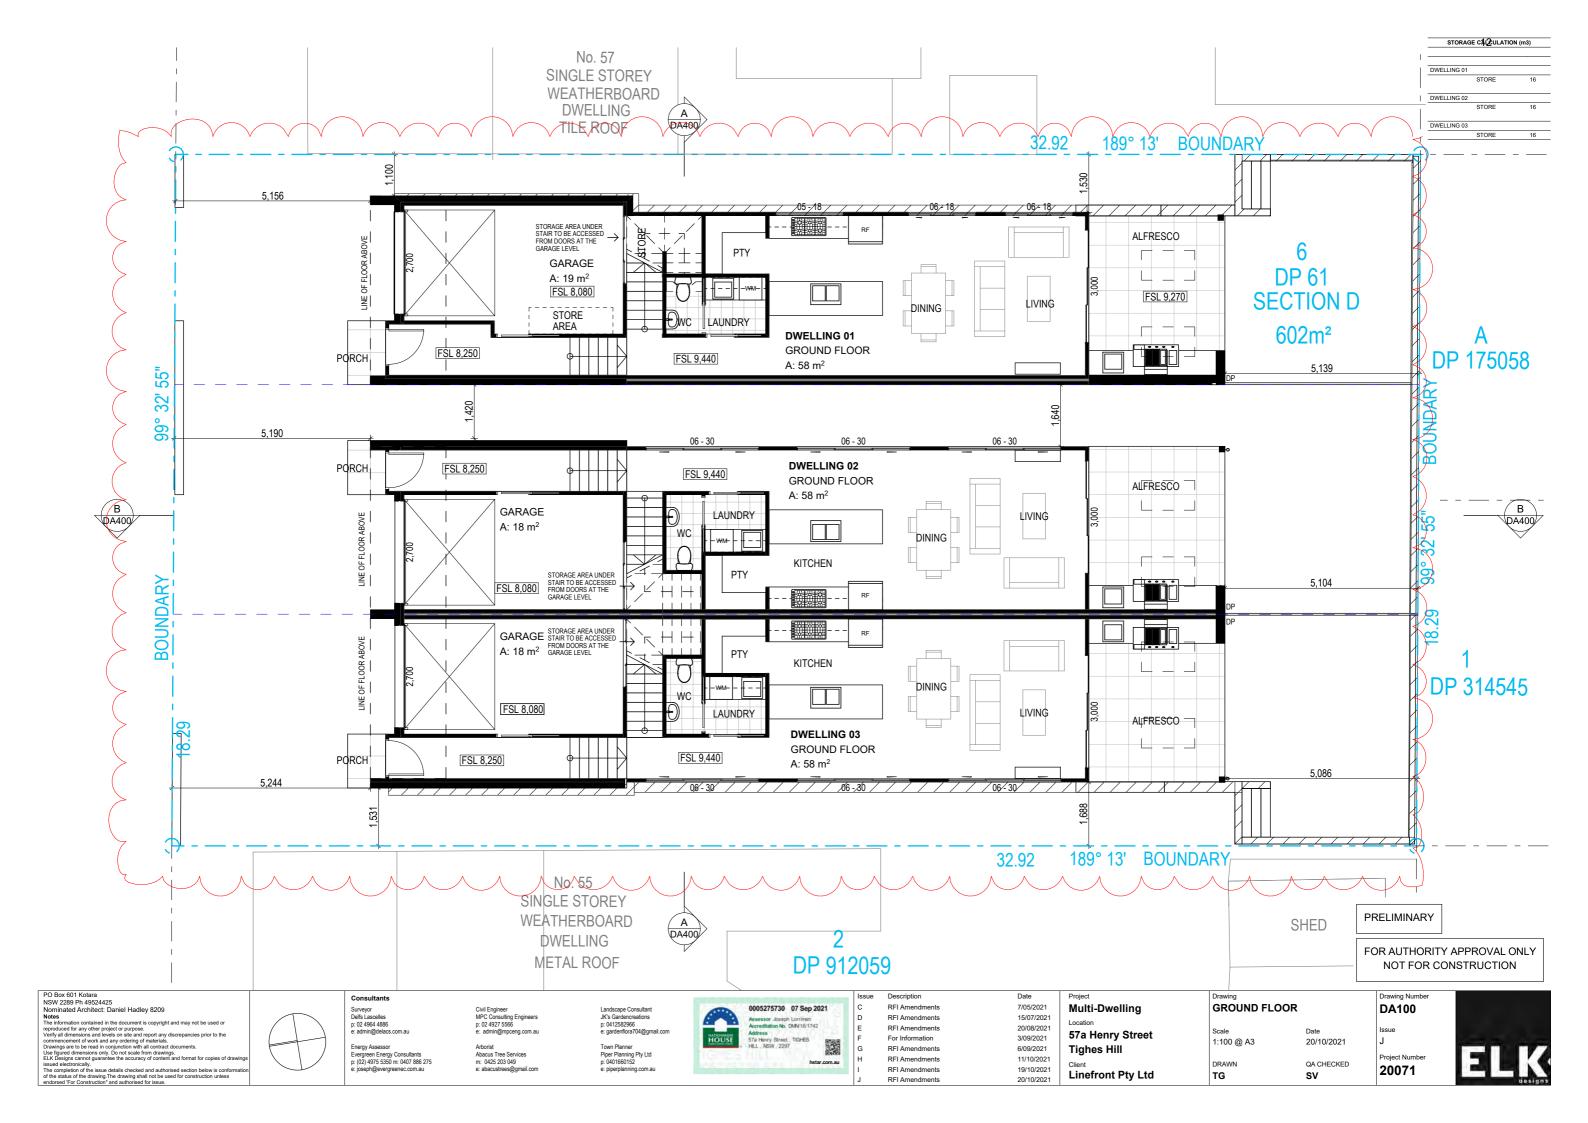

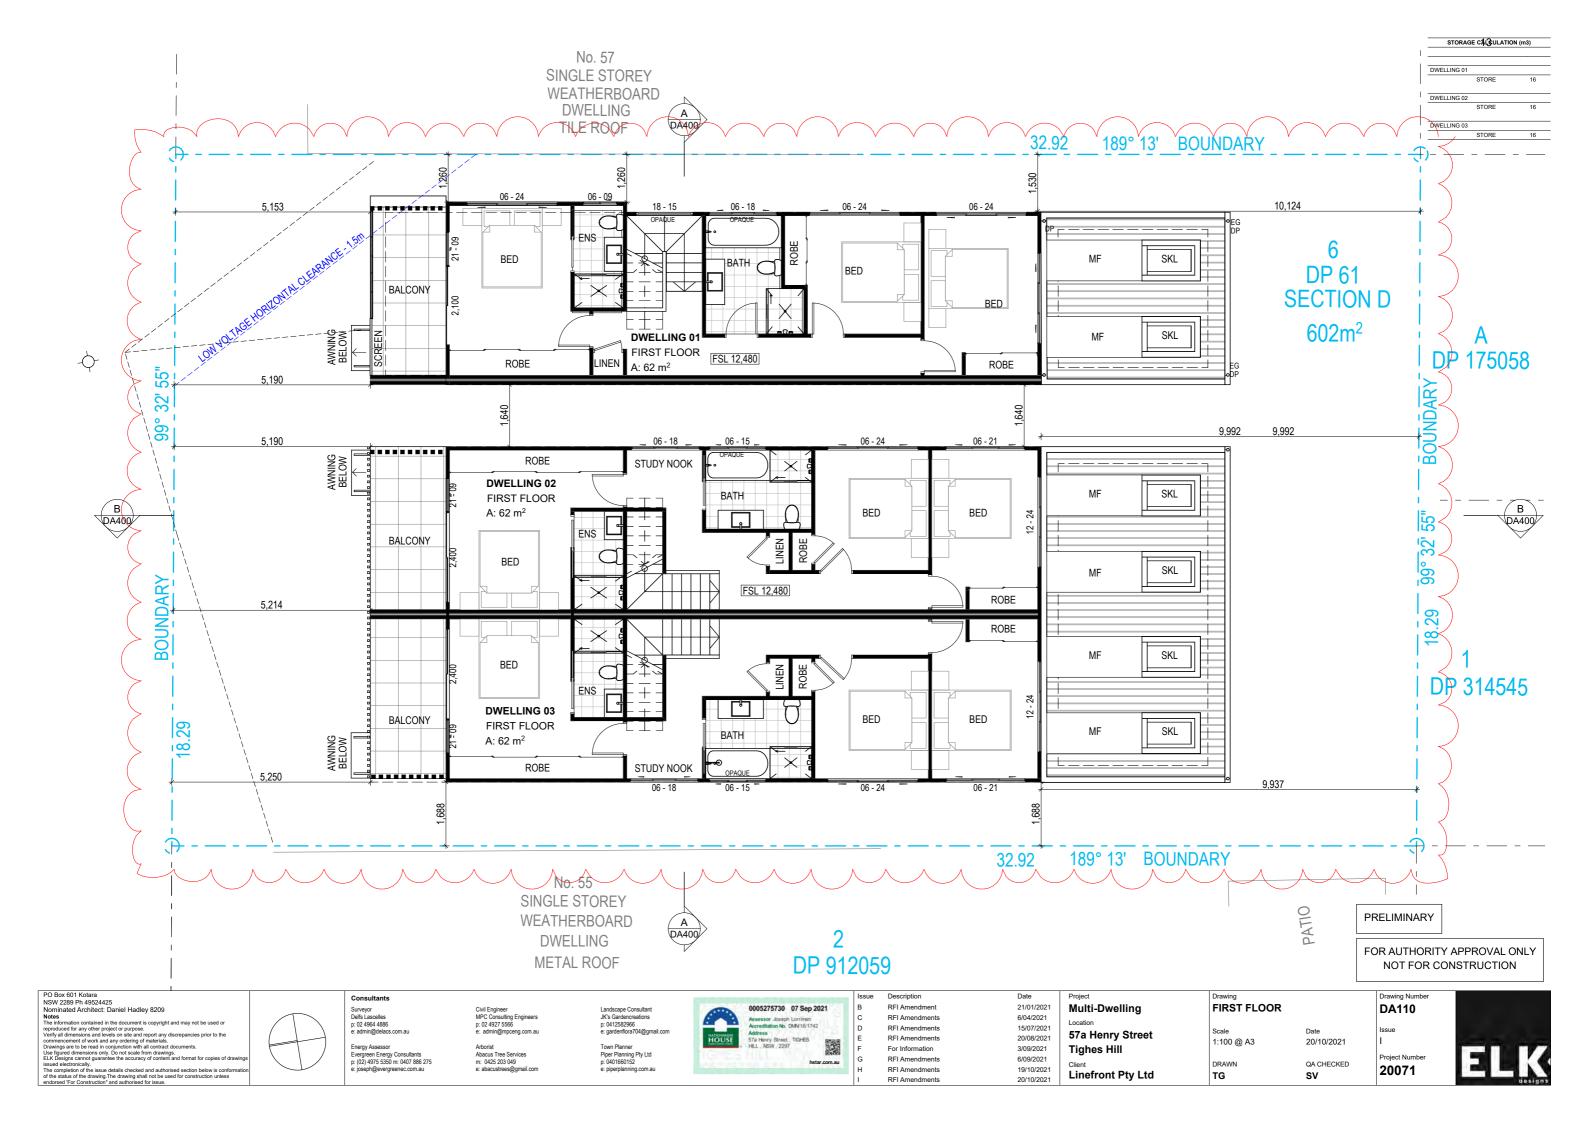

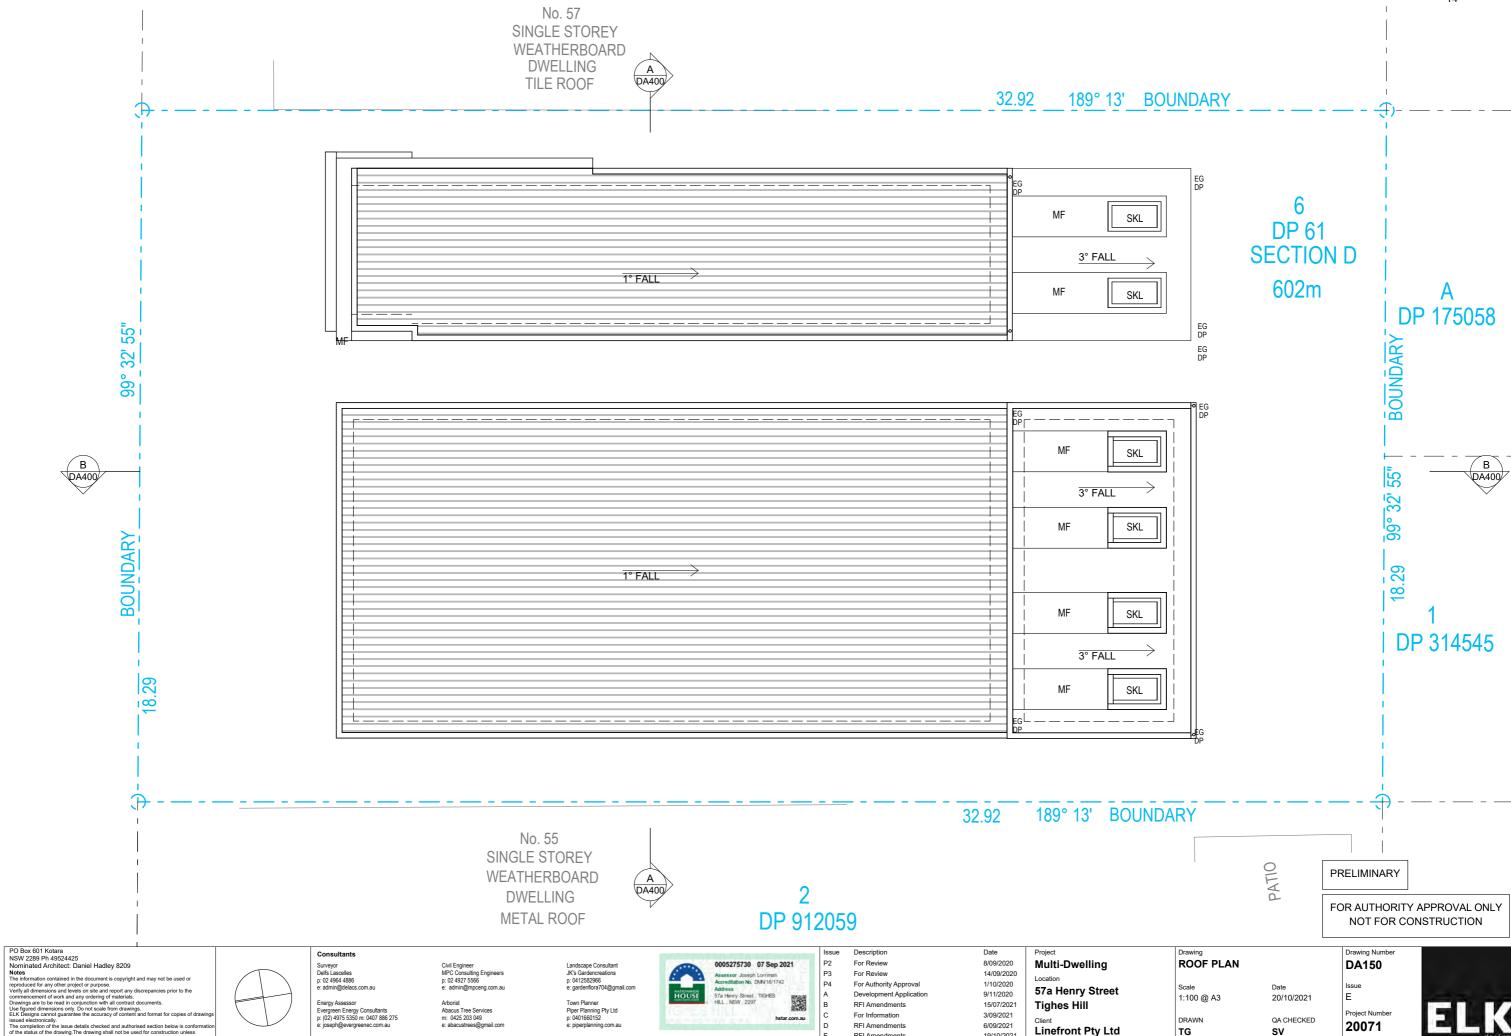

RFI Amendments

19/10/2021









PRELIMINARY

FOR AUTHORITY APPROVAL ONLY NOT FOR CONSTRUCTION

PO Box 601 Kotara NSW 2289 Ph 49524425 Nominated Architect: Daniel Hadley 8209

Notes
The information contained in the document is copyright and may not be used or reproduced for any other project or purpose.
Verify all dimensions and levels on site and report any discrepancies prior to the commencement of work and any ordering of materials.
Drawings are to be read in conjunction with all contract documents.
Use figured dimensions only. Do not safe from drawings.

Live figured dimensions only. Do not soft order order and format for copies of drawing services of the contract of content and format for copies of drawings.

Surveyor Delfs Lascelles p: 02 4964 4886 e: admin@delacs.com.au

Energy Assessor Evergreen Energy Consultants p: (02) 4975 5350 m: 0407 886 275 e: joseph@evergreenec.com.au

Civil Engineer MPC Consulting Engineers p: 02 4927 5566 e: admin@mpceng.com.au

Landscape Consultant JK's Gardencreations p: 0412582966 e: gardenflora704@gmail.com Arborist Abacus Tree Services m: 0425 203 049 e: abacustrees@gmail.com

Town Planner Piper Planning Pty Ltd p: 0401660152 e: piperplanning.com.au



Description For Review

RFI Amendments

For Authority Approval Development Application RFI Amendments RFI Amendments For Information

2/09/2020 1/10/2020 9/11/2020 6/04/2021 15/07/2021 3/09/2021

6/09/2021

Multi-Dwelling

57a Henry Street Tighes Hill

Linefront Pty Ltd

EXTERNAL FINISHES


TG

1:100 @ A3 20/10/2021 QA CHECKED DRAWN


sv


Drawing Number DA350 E


Project Number

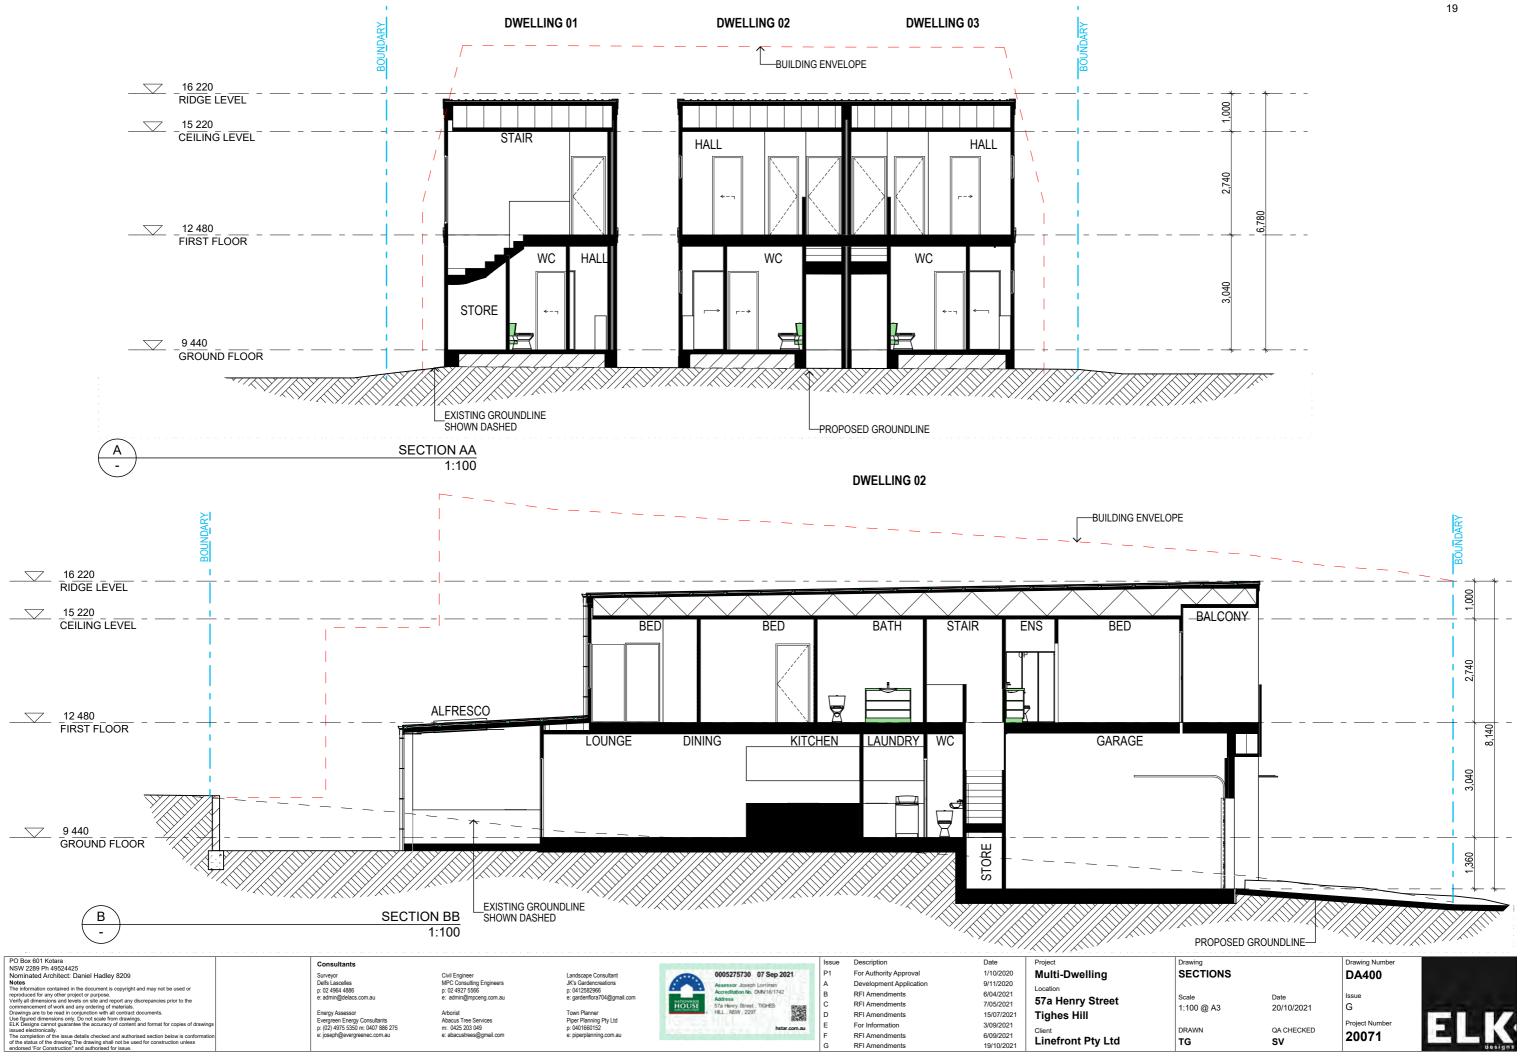

	SHADOW DIAGRAMS (SOLAR ACCESS ACHIEVED TO OPEN SPACE m2)									
UNIT	AREA REQUIRED	09:00	10:00	10:30	11:00	12:00	13:00	14:00	15:00	COMPLIANCE
DWELLING 01	8m2	14m2	15m2	15m2	15m2	14m2	14m2	11m2	5m2	YES
DWELLING 02	8m2	2m2	4m2	8m2	13m2	13m2	13m2	12m2	12m2	YES
DWELLING 03	8m2	0m2	2m2	6m2	12m2	17m2	17m2	16m2	14m2	YES

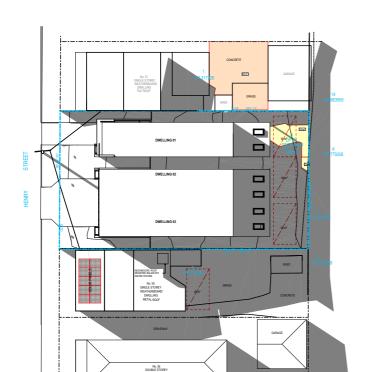

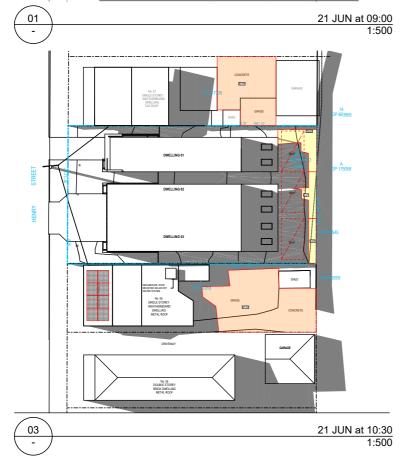

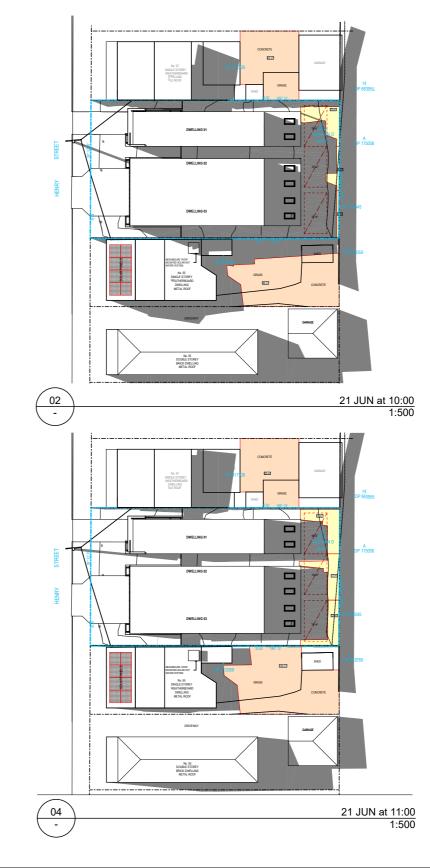

AREA OF NEIGHBOURS OPEN SPACE ACHIEVING SOLAR ACCESS

AREA OF OPEN SPACE ACHIEVING SOLAR ACCESS

SHADOW DIAGRAM LEGEND

PRELIMINARY

FOR AUTHORITY APPROVAL ONLY NOT FOR CONSTRUCTION

PO Box 601 Kotara NSW 2289 Ph 49524425 Nominated Architect: Daniel Hadley 8209 Notes The information contained in the document is copyright

Notinitated Architect. Darlier Inactivey 2029

Notes

Notes

Notes

Architects declared to document is copyright and may not be used or reportized for any other project or purpose.

Yorkiy all dimensions and levels on site and report any discrepancies prior to the commencement of work and any ordering of materials.

Drawings are to be read in conjunction with all contract documents.

Use figured dimensions only. Do not scale from drawings.

ELK Designs cannot guarantee the accuracy of content and format for copies of drawin issued electronically.

Issued electronically.

To the states of the drawing The drawing shall not be used for construction unless endorsed "For Construction" and authorised for issue.



Consultants

Surveyor Delfs Lascelles p: 02 4964 4886 e: admin@delacs.com.au

Civil Engineer MPC Consulting Engineers p: 02 4927 5566 e: admin@mpceng.com.au

Energy Assessor Evergreen Energy Consultants p: (02) 4975 5350 m: 0407 886 275 Arborist Abacus Tree Services m: 0425 203 049 e: abacustrees@gmail.com Landscape Consultant JK's Gardencreations p: 0412582966 e: gardenflora704@gmail.com

Town Planner Piper Planning Pty Ltd p: 0401660152 e: piperplanning.com.au



Description RFI Amendments RFI Amendments For Information

RFI Amendments

RFI Amendments RFI Amendments RFI Amendments 14/01/2021 6/04/2021 15/07/2021 3/09/2021 6/09/2021

12/10/2021

19/10/2021

Tighes Hill 11/10/2021

Multi-Dwelling 57a Henry Street

Linefront Pty Ltd

EXTERNAL SHADOW DIAGRAMS 1:500 @ A3

TG

20/10/2021 QA CHECKED DRAWN

sv

Drawing Number DA900

Project Number





SHADOW DIAGRAM LEGEND


AREA OF OPEN SPACE ACHIEVING SOLAR ACCESS

AREA OF NEIGHBOURS OPEN SPACE ACHIEVING SOLAR ACCESS

	SHADOW DIAGRAMS (SOLAR ACCESS ACHIEVED TO OPEN SPACE m2)									
UNIT	AREA REQUIRED	09:00	10:00	10:30	11:00	12:00	13:00	14:00	15:00	COMPLIANCE
DWELLING 01	8m2	25m2	20m2	18m2	17m2	14m2	14m2	11m2	5m2	YES
DWELLING 02	8m2	2m2	4m2	8m2	13m2	13m2	13m2	12m2	12m2	YES
DWELLING 03	8m2	0m2	2m2	6m2	12m2	19m2	23m2	26m2	27m2	YES

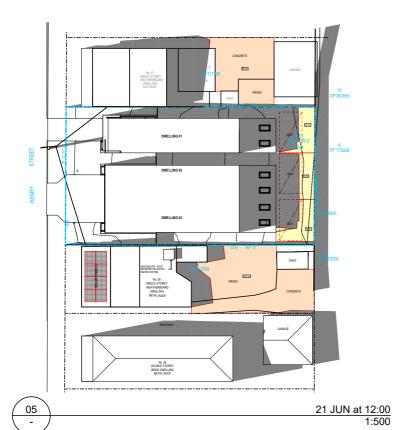

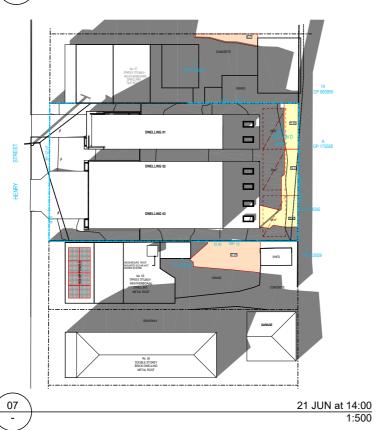

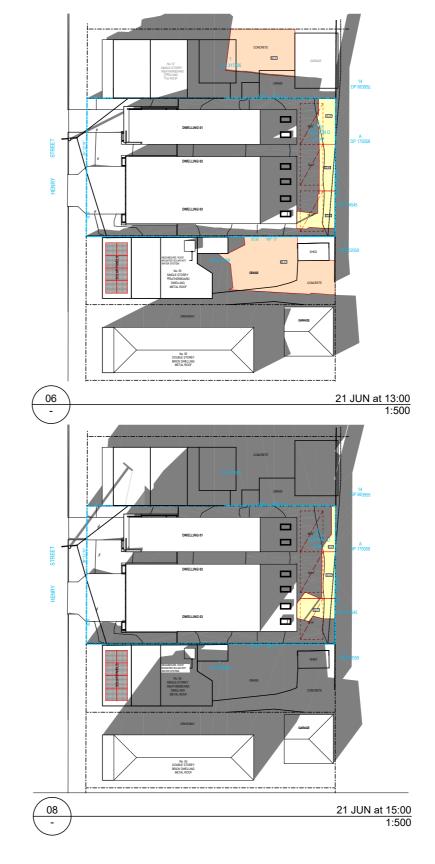

PRELIMINARY

FOR AUTHORITY APPROVAL ONLY NOT FOR CONSTRUCTION

PO Box 601 Kotara NSW 2289 Ph 49524425 Nominated Architect: Daniel Hadley 8209 Notes The information contained in the document is copyright Notinitated Architect. Dafine Inabilety 2019

Notes

Notes

Notes

The Notes

Notes

The Notes

Note



Consultants

Surveyor Delfs Lascelles p: 02 4964 4886 e: admin@delacs.com.au

Energy Assessor Evergreen Energy Consultants p: (02) 4975 5350 m: 0407 886 275

Civil Engineer MPC Consulting Engineers p: 02 4927 5566 e: admin@mpceng.com.au

Arborist Abacus Tree Services m: 0425 203 049 e: abacustrees@gmail.com

Landscape Consultant JK's Gardencreations p: 0412582966 e: gardenflora704@gmail.com

Town Planner Piper Planning Pty Ltd p: 0401660152 e: piperplanning.com.au



Description RFI Amendments RFI Amendments For Information

RFI Amendments RFI Amendments RFI Amendments RFI Amendments

14/01/2021 6/04/2021 15/07/2021 3/09/2021 6/09/2021 11/10/2021 12/10/2021

19/10/2021

Multi-Dwelling 57a Henry Street

Tighes Hill Linefront Pty Ltd **EXTERNAL SHADOW**

TG

DIAGRAMS 1:500 @ A3 20/10/2021 QA CHECKED DRAWN

sv

Drawing Number DA901

Project Number



Sediment and erosion control

All erosion and sediment control measures to be installed prior to site disturbance.

The project manager to inform all contractors and sub-contractors of their obligations under the erosion and sediment control plan.

Topsoil from all areas that will be disturbed to be stripped and stockpiled at the nominated site.

All sediment control structures to be inspected by site supervisor after each rainfall event for structural damage and all trapped sediment to be removed to a nominated stockpile site.

Sediment and erosion control shall be effectively maintained at all times during the course of construction and shall not be removed until the site has been stabilised or landscaped to the superintendent's satisfaction.

A single all weather access way will be provided at the front of the property consisting of 50-75 aggregate or similar material at a minimum thickness of 150 laid over needle-punched geotextile fabric and constructed prior to commencement of works.

The contractor shall ensure that no spoil or fill encroaches upon adjacent areas for the duration of works.

The contractor shall ensure that kerb inlets and drains receiving stormwater shall be protected at all times during development. Kerb inlet sediment traps shall be installed along the immediate vicinity along the street frontage.

Sediment fencing shall be secured by post (where metal star pickets are used plastic safety caps shall be used) at 3000 intervals with geotextile fabric embedded 200 in soil.

All topsoil stripped from the site and stockpiled does not interfere with drainage lines and stormwater inlets and will be suitably covered with an impervious membrane material and screened by sediment fencing.

Soil conservation

Prior to commencement of construction provide 'sediment fence,' 'sediment trap' and washout area to ensure the capture of water borne material generated from the site.


Maintain the above during the course of construction, and clear the 'sediment trap after each storm.


Sediment trap

1000 x 1000 wide 500 deep pit, located at the lowest point to the trap sediment.

Sediment fence

Provide sediment fence on down slope boundary as shown on plan. Fabric to be buried below ground at lower edge.

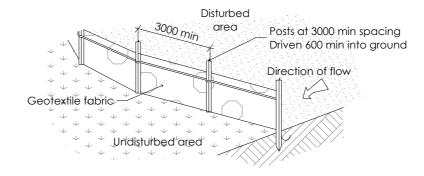


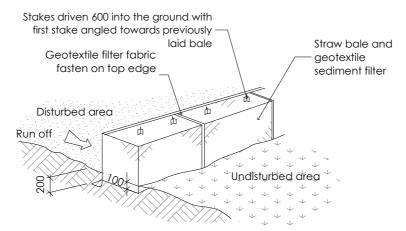

Drainage area 0.5 ha. max. slope gradient 1:2 max. slope length 50m.


Washout area

to be 1800 x 1800 allocated for the washing of tool and equipment

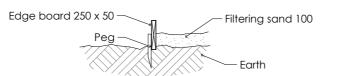


Vehicle access to site

Vehicle access to the building site should be restricted to a single point so as to reduce the amount of soil deposited on the street pavement.

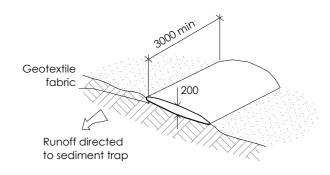


Building material stockpiles

All stockpiles of building material such as sand and soil must be protected to prevent scour and erosion. they should never be placed in the street gutter where they will wash away with the first rainstorm.

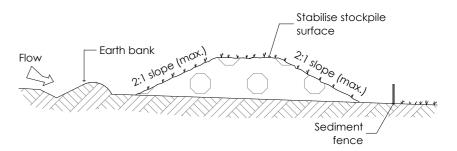

Sandbag kerb sediment trap

In certain circumstances extra sediment trapping may be needed in the street gutter.

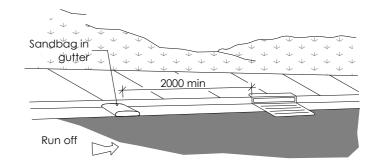

PRELIMINARY

FOR AUTHORITY APPROVAL ONLY NOT FOR CONSTRUCTION

PO Box 601 Kotara ted Architect: Daniel Hadley 8209

ined in the document is copyright and may not be used o other project or purpose. is and levels on site and report any discrepancies prior to the work and any ordering of materials. read in conjunction with all contract documents.

n: 02 4964 4886

Evergreen Energy Consultants p: (02) 4975 5350 m: 0407 886 275

Civil Engineer MPC Consulting Engineers p: 02 4927 5566 : 0412582966

Piper Planning Pty Ltd p: 0401660152

n: 0425 203 049



Description For Authority Approval RFI Amendments

1/10/2020 9/11/2020 6/09/2021

Multi-Dwelling 57a Henry Street **Tighes Hill**

Linefront Pty Ltd

@ A3

SEDIMENT CONTROL 20/10/2021

QA CHECKED

DA960 Project Numbe 20071



D.P.

REGISTERED

(A2)

7

PLAN FORM

HENRY

99°32′55"

6.125

3 201 m²

189°13′

32.92

STREET

99°32′55" 6.09 200 m²

189°13' FACE OF WALL ON BOUNDARY

99°32′55"

6.075

2 200 m²

CENTRE OF PARTY WALL

9°13′

32.92

D.P.377326

PRELIMINARY ONLY


THIS PLAN IS PRELIMINARY ONLY AND IS SUBJECT TO COUNCIL APPROVAL, FINAL DESIGN, CONSTRUCTION, FINAL SURVEY AND REGISTRATION AT THE LAND AND PROPERTY INFORMATION, SYDNEY.


DRAWING NOTE

THIS PLAN HAS BEEN PREPARED USING PLANS PROVIDED BY: COMPANY: ELK DESIGNS DRAWING REFERENCE: 20071 SITE PLAN DA030 REVISION: H DATE: 12.10.2021 DWELLING 1 MOVED 130MM EAST AS PER CIENT REQUEST

SURVEYOR		PLAN OF SUBD
Name:	TIMOTHY R. RHEINBERGER	
Date:	19.10.2021	
Reference:	20553_DRAFT_R3	

LGA: NEWCASTLE	Locality: TIGHES HILL	Reduction Ratio 1:100	
PLAN OF SUBDIVISION OF LOT 6 SECTION D D.P.61			

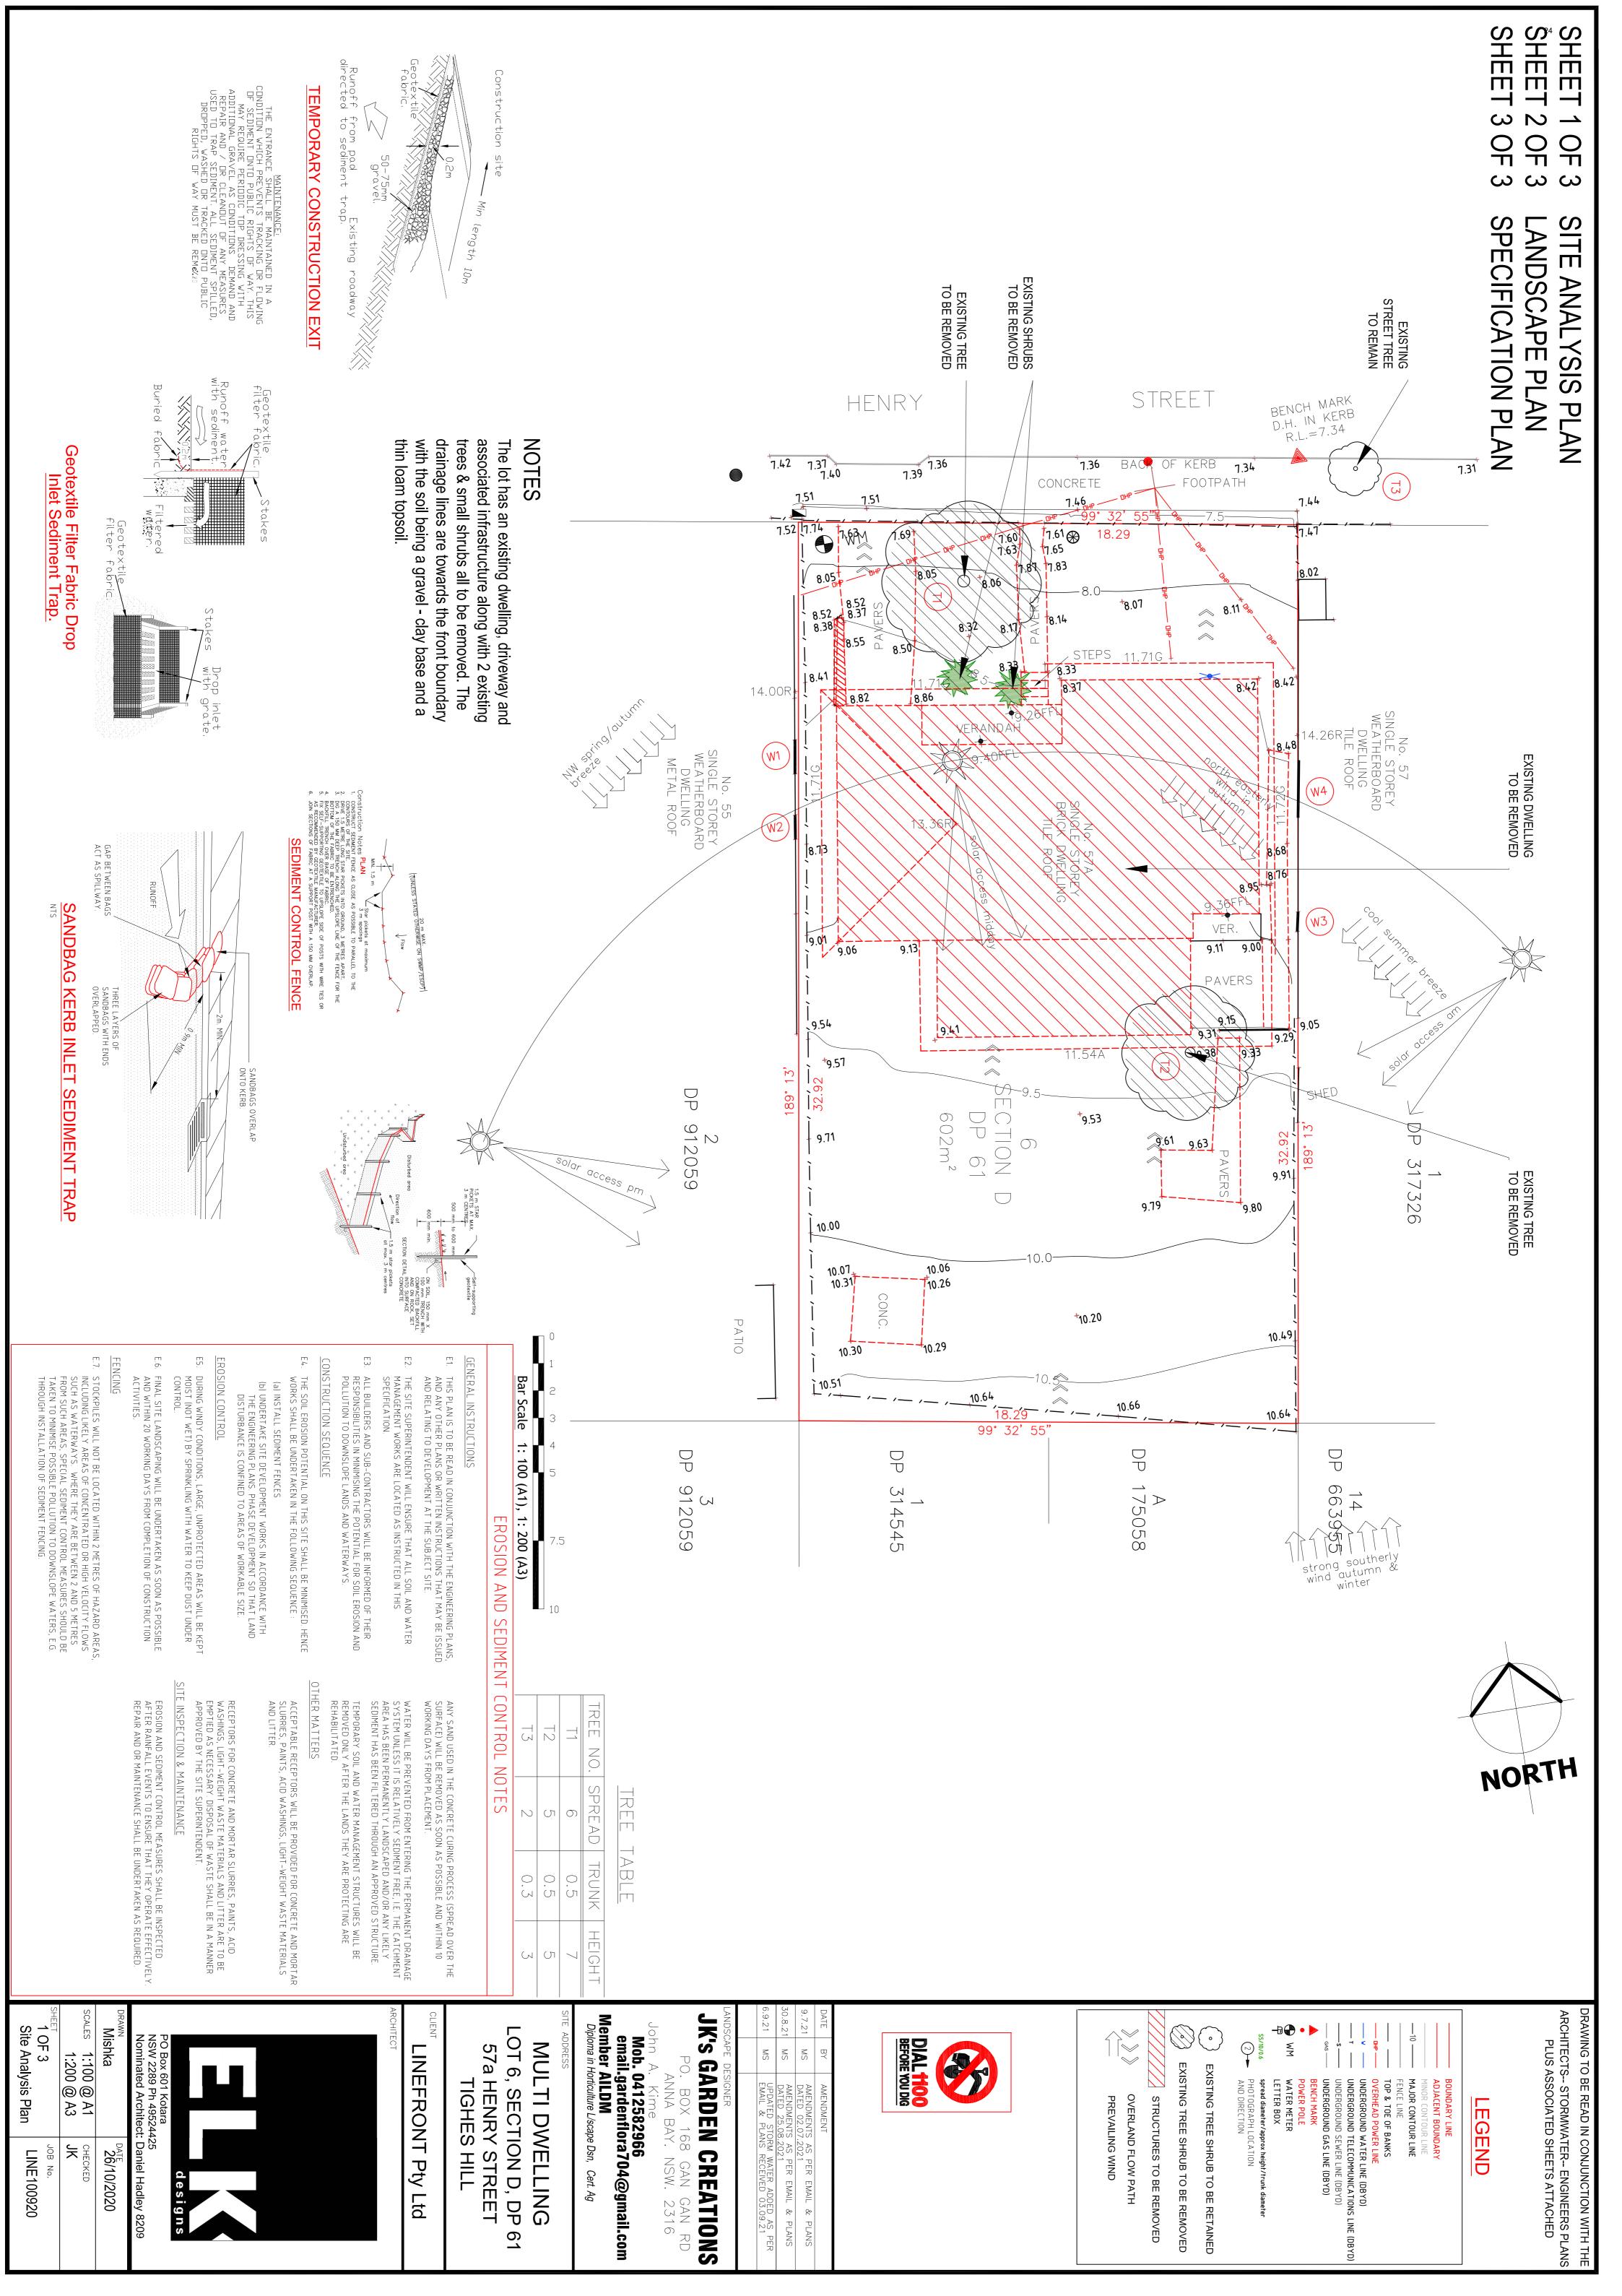

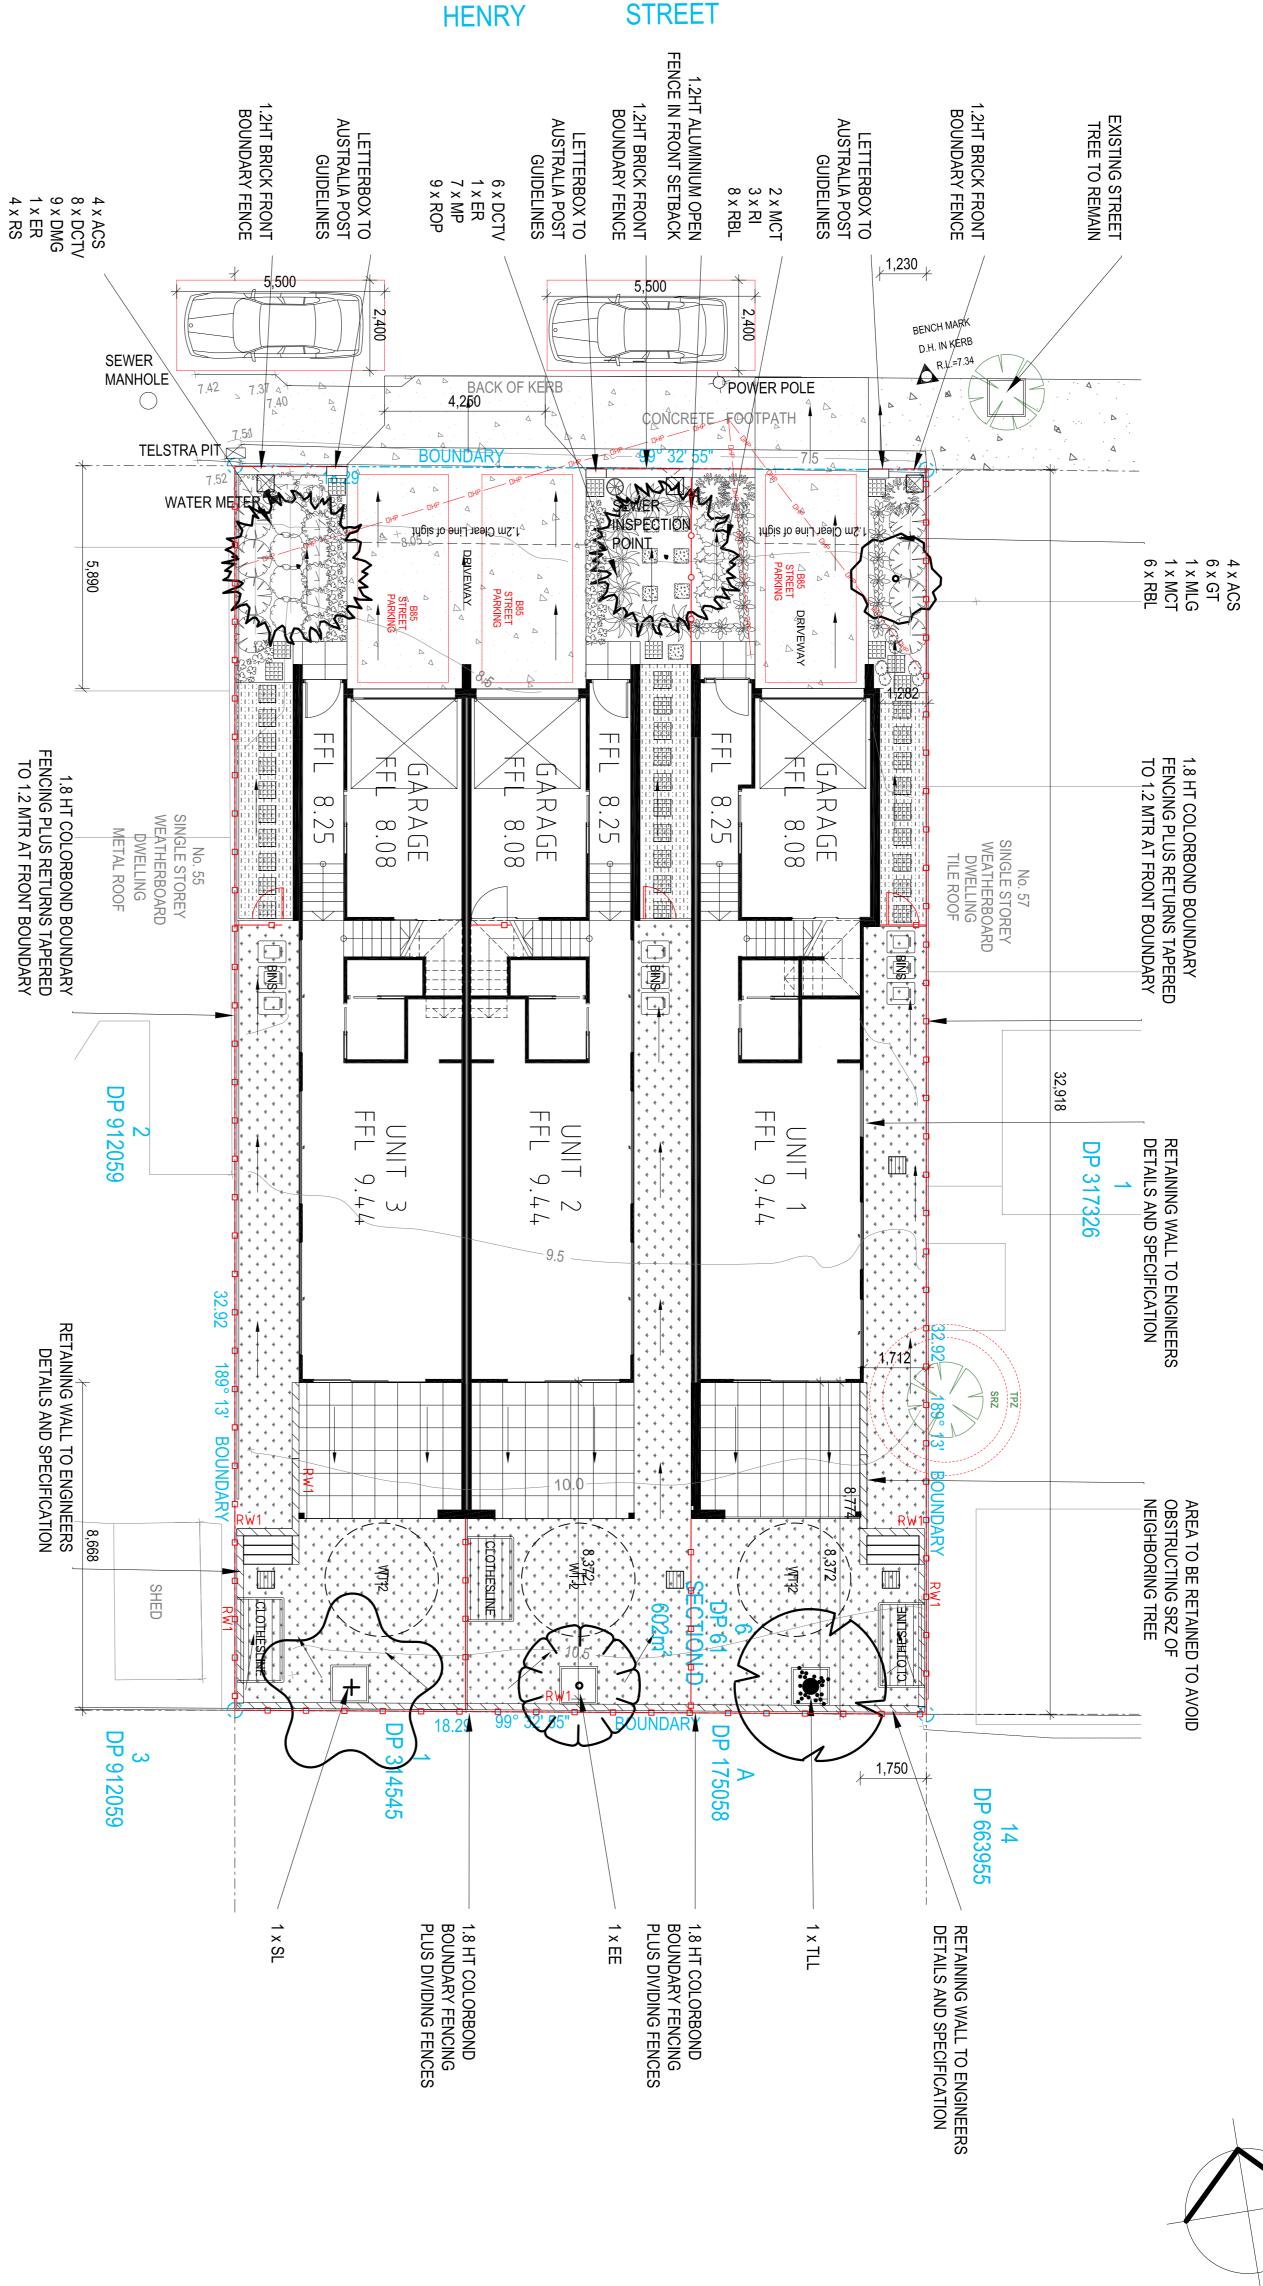

MLG MAGNOLIA LITTLE GEM RBL ROSMARINUS BLUE LAGOON RS RAPHIOLEPSIS SPRINGTIME ROP RAPHIOLEPSIS ORIENTAL PEARL MP MYOPORUM PARVIFOLIUM DCTV DIANELLA CAERULEA CTV RI RAPHIOLEPSIS INTERMEDIA MCT MELALEUCA CLARET TOPS ER ELEOCARPUS RETICULATUS EE ELAEOCARPUS EUMUNDI SL SYZYGIUM LEUHMANNII GT GAZANIA TOMENTOSA DMG DURANTA MINI GOLD ACS ACMENA CHERRY SURPRISE PLANT LEGEND

TRISTANIOPSIS LAURINA LUCSIOUS

Bar Scale 100 (A1), ... 200 (A3) ■ 10

John A. Kime
Mob. 0412582966
email.gardenflora704@gmail.com
Member AILDM
Diploma in Horticulture L/scape Dsn, Cert. Ag

LOT 6, SECTION D, DP 61

MULTI DWELLING

57a HENRY STREET

TIGHES HILL

LINEFRONT Pty Ltd

JK'S GARDEN CREATIONS

BAY. 00 00

ZSX.

GAN RD 2316

AMENDMENTS AS PER EMAIL & PLANS
DATED 02.07.2021

AMENDMENTS AS PER EMAIL & PLANS
DATED 25.08.2021

UPDATED STORM WATER ADDED AS PER
EMAIL & PLANS RECEIVED 03.09.21

DIAL 1100 BEFORE YOU DIG

for Refer to ELK Site Coverage Plan Landscape Calculations

	PLANT SCHEDULE			
				Pot Size
	TREES, SHRUBS & GROUNDCOVERS	COVERS		mm/ltr
Đ	Botanical Name	Common Name	Qty	
ACS	Acmena smithii 'Cherry Surprise'	Red tipped lilly pilly	∞	200mm
DCTV	Dianella caerula cultivar	Cultivar flax lillies	14	200mm
DMG	Duranta mini gold		9	200mm
EE	Eleocarpus eumundi	Eumundi quongdong	ь	251tr
ER	Eleocarpus reticulatus	Blue berry ash	2	25ltr
GT	Gazania tomentosa		6	200mm
MLG	Magnolia grandiflora 'little gem'	Dwarf bullbay	1	25ltr
MCT	Melaleuca claret tops	Dwarf red tipped snow in summer	ω	200mm
MP	Myoporum parvifolium	Creeping boobialla	7	200mm
RI	Raphiolepsis intermedia		3	200mm
ROPW	Raphiolepsis oriental pearl (white)		9	200mm
RS	Raphiolepsis 'Springtime'		4	200mm
RBL	Rosmarinus blue lagoon	Dwarf rosemary	14	200mm
SL	Syzygium luehmannii	Weeping lilly pilly	1	25ltr
TLL	Tristaniopsis laurina 'Luscious'	Watergum	1	25ltr
ALL HE	ALL HEIGHTS ARE AVERAGE DEPENDENT ON SOIL, CLIMATE, MAINTENANCE, ETC.	SOIL, CLIMATE, MAINTENANCE, ETC.		

NORTH DRAWING TO BE READ IN CONJUNCTION WITH THE ARCHITECTS-- STORMWATER-- ENGINEERS PLANS PLUS ASSOCIATED SHEETS ATTACHED CONCRETE PATHS & DRIVEWAY LEGEND

100mm COMPACTED RHYOLITE TO SHADED AREAS - REFER TO SHEET 3 FOR DETAILS

TURF - REFER TO SHEET 3 FOR DETAILS

WT-2

WATER TANKS

CLOTHESLINE

GARBAGE BINS

EXTERNAL YARD TAP

LETTERBOX

TO ENGINEERS DETAILS 450 × 450 STEPPING PAVERS

PRIVATE OPEN SPACE

DENOTES DESIGN SPOT LEVELS

 $_{
m Z}$ DENOTES RETAINING WALL

1.2M HIGH BRICK FRONT BOUNDARY FENCE TO ARCHITECTURAL DETAIL

1.2M HIGH ALUMINUM OPEN FENCE

4.8M HIGH COLOURBOND BOUNDARY FENCE AND DIVIDING FENCES PLUS RETURNS

25

O Box 601 Kotara ISW 2289 Ph 49524425 Iominated Architect: Daniel Hadley 8209	designs
-------------------------------------------------------------------------------------	---------

Mishka

26/10/2020

ALES 1:100 @ A1 1:200 @ A3

CHECKED

2 OF 3

Landscape Plan

LINE100920

INITIAL PREPARATION

controls to contain all within confines of the site. Spray with approved herbicide weed killer to all species list, will be true to plant schedule. The trees and shrubs recommended may sometimes be commencement of any site works are carried and throughout the contract so as to suppress any proposed lawn and garden areas to manufactures directions. Spray all weeds before site guidelines in reference to erosion and sediment control regulations and other environmental no damage occurs to them throughout the contract. Comply with the requirements of the Council early so arrangements to substitute can be made. Excess soils and contaminated soil are to difficult to source due to times of year, weather, disease etc, this being the case, please inform weeds that may arise. Source all plants before start of job so the time factor to purchase from Werify all dimensions on site prior to commencement, locate all underground services and ensure

removed within the guidelines of the council requirements to approved sites.

Cultivate to the minimum depth of 200mm in all garden areas and 100mm depth in all lawn areas; allow for the addition of turf and mulches to specified requirements. all lawn and garden areas drain sufficiently (both surface and subsurface), are at required finished where fill is required, gain required levels using a premium soil mix. Where excavation is required levels and have sufficient soil depths to enable lawn and plants to thrive and grow. Soil levels are to drain satisfactorily. It is the contractor's responsibility to ensure the end result of the project is that soil to garden areas and 100-300mm depth of topsoil to lawn areas. Undertake all required action as with clay excavate as required to allow for addition of 200-400mm depth of premium garden add a clay breaker to all garden areas, before the addition of garden soil is added. In all areas to ensure that no root balls of proposed plants sit in clay wells and that all garden and lawn areas PREPARATION

GARDEN EDGING

existing turfed areas. Use 38x150mm treated pine edging with 50x50 pegs at 1200 centres finished EDGING: 30mm below top of edging. Timber edging shall be located to all planter bed edges where meeting new or

PLANTING

soil of plant and surrounding soil so as to allow roots to adjust, do not allow drying out. Water the width and 100mm deeper than the plant root balls that they are to receive. Add fertilizer, Purchase plants from an approved nursery that supplies plants that are true to type and species, stem shall finish flush with finished soil level. Thoroughly water all plants on first planting to soak Remove plant from container install and backfill with garden soil and firmed into place. Base of being delivered. Set out plants as indicated on plan. Plant holes shall be dug approximately twice healthy and able to store at nursery to maintain vigor before planting. Plant within 24hrs of plants followed by 100mm of garden soil shall be placed into the base of hole and lightly consolidated.

regular over the first 3-4 weeks.

Use slow release fertilizers such as osmocote and or agriform tablets on all plants

MULCHING

Install 100mm minimum of Forest mulch as a mulch over all gardens. Shaded areas mulch with 10-25mm pebble mulch with weedmat under.

GRAVEL AREAS

gardens & gravel with timber edging. RETAINING WALLS Consolidated crushed rhyolite, 100mm thick, over a compacted road base. Contain areas between

<u></u>

50mm HWD

STAKES

Grassed Detail.

QFeq:

using imported

Not.To.Scale.

boundary. Erection of masonry block retaining walls treated timber retaining walls to be as per retaining wall specification guidelines . All retaining walls and footings to remain within the confines of

edging and paths. Prepare for, level and lay cultivated Buffalo turf to all areas nominated on the plan as being lawn. To be layed within 24 hrs of delivery on site, making sure all areas are level for drainage, garden


council that all landscaping work has been undertaken in strict accordance with council's Prior to practical completion removal from site all unwanted debris occurring from work. Satisfy andscape codes and guide lines.

COMPLETION

Completion. At the completion of landscape works and prior to the issue of the Certificate of Practical

shall include but not limited to watering, weeding, fertilizing, pest and disease control, returfing, staking and tying, replanting, cultivation, pruning, aerating, renovation, top dressing and the like. EXISTING TREES Carry out the following during the maintenance period(determined by Builder). These works

allowing the trees to grow the optimum growth once all works have been finalized. machinery, vehicles or site sheds. With this preparation is to protect the existing tree and its critical roots to be retained until all building works are completed. The enclosed area is to remain free of materials, from mechanical damage, compaction or any other adverse impacts resulting from construction activity and fence 3.00m from the base of the tree. This fence is to be erected prior to works commencing on site and is The existing trees to be retained on site are to be protected by surrounding with a 1.8m high chainmesh

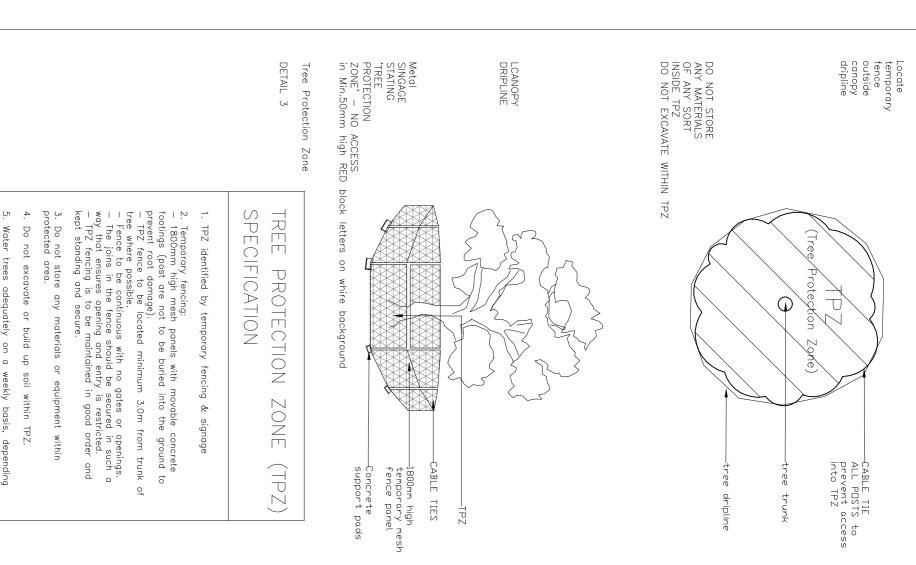

** 75

150/

area mix Excavate deeper &

planting hole 200mm wider t

100mm than r

rootball

Cultivate

subgrade to 150mm

Install plant flush with existing level Backfill hole with cultivated plo

anting


Dish mulch to base of plant

Typical detail - Gravel area profile

Planting

 \equiv .


Not.To.Scale

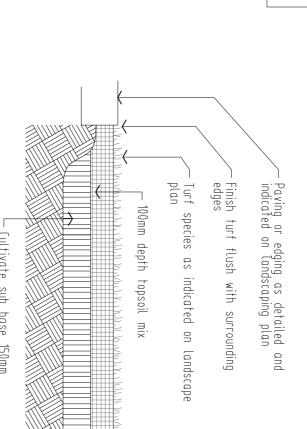


TREES

STAKE

DIAGRAM

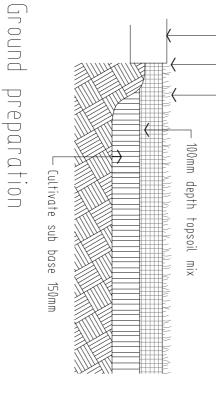

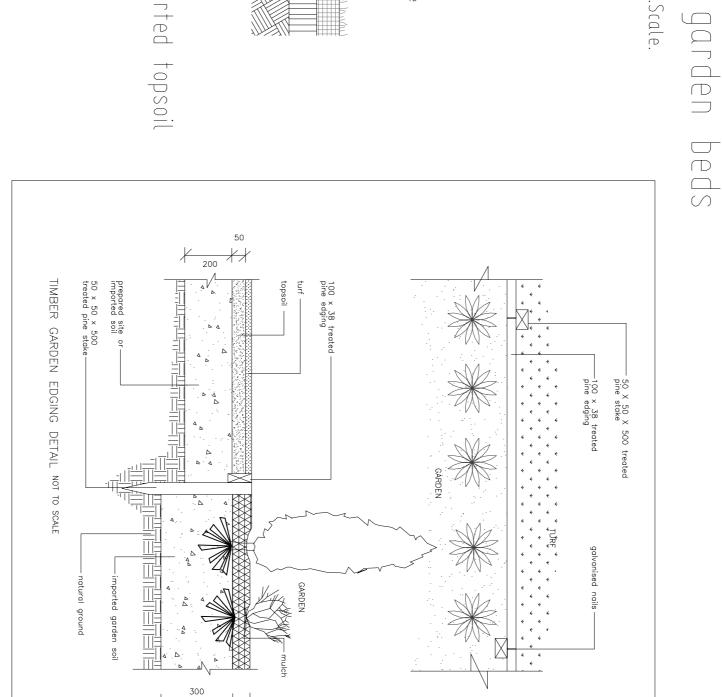

		000 000 000 000 000 000 000 000 000 00		
251-1001	FERTILIZER IN SIDE	BACKFILL WITH TOPSOIL MIXTURE	75mm MULTCH AS SPECIFIED DECREASE AT BASE OF TRUNK	HESSIAN WEBBING TIED In Figure 8 Pattern

	PLANT SCHEDULE				
^	TREES. SHRUBS & GROUNDCOVERS	COVERS		Pot Size mm/ltr	Mature Sia
ō	Botanical Name	Common Name	Qty		
ACS	Acmena smithii 'Cherry Surprise'	Red tipped lilly pilly	8	200mm	2 x 2.5m
DCTV	Dianella caerula cultivar	Cultivar flax lillies	14	200mm	.7 x .7m
DMG	Duranta mini gold		9	200mm	1 x 1m
EE	Eleocarpus eumundi	Eumundi quongdong	1	25ltr	4 x 9m
ER	Eleocarpus reticulatus	Blue berry ash	2	25ltr	5 x 9m
GT	Gazania tomentosa		6	200mm	G/cover
MLG	Magnolia grandiflora 'little gem'	Dwarf bullbay	1	25ltr	3 x 6m
MCT	Melaleuca claret tops	Dwarf red tipped snow in summer	ω	200mm	1.5x1.5m
M₽	Myoporum parvifolium	Creeping boobialla	7	200mm	G/cover
꼰	Raphiolepsis intermedia		ω	200mm	1.5x1.5m
ROPW	Raphiolepsis oriental pearl (white)		9	200mm	1 x 1m
RS	Raphiolepsis 'Springtime'		4	200mm	1.2 x 1.2m
RBL	Rosmarinus blue lagoon	Dwarf rosemary	14	200mm	1 x .7m
SL	Syzygium luehmannii	Weeping lilly pilly	1	25ltr	6 x 9m
TLL	Tristaniopsis laurina 'Luscious'	Water gum	1	25ltr	5 x 9m
ALL HE	ALL HEIGHTS ARE AVERAGE DEPENDENT ON SOIL, CLIMATE, MAINTENANCE, ETC.	SOIL, CLIMATE, MAINTENANCE, ETC.			

DRAWING TO BE READ IN CONJUNCTION WITH THE ARCHITECTS-- STORMWATER-- ENGINEERS PLANS PLUS ASSOCIATED SHEETS ATTACHED

100MM DEEP CONSC



6.9.21	30.8.21 MS	9.7.21	DATE	
MS S	M S	MS	ВҮ	
UPDATED STORM WATER ADDED AS PEI EMAIL & PLANS RECEIVED 03.09.21	AMENDMENTS AS PER EMAIL & PLANS DATED 25.08.2021	AMENDMENTS AS PER EMAIL & PLANS DATED 02.07.2021	AMENDMENT	

JK's **GARDEN CREATIONS**

 ∞ 2316 77

Member AILDM Diploma in Horticulture I Mob. 0412582966 email.gardenflora704@gmail.com


e L/scape Dsn,

Cert. Ag

7 U <u>ග</u>

HIGHES HILL	e Size
57a HENRY STREET	
LOT 6, SECTION D, DF	
MULTI DWELLII	
SIE ACCAESO	

-	LINEFRONT Pty Ltd
	ARCHITECT

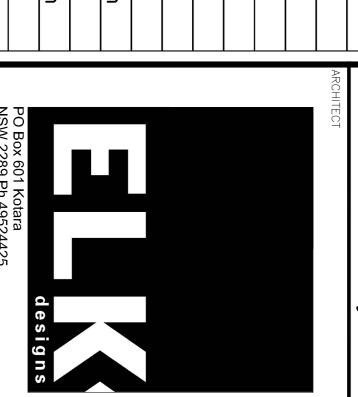


Mishka	DRAWN	NSW 2289 Ph 49524425 Nominated Architect: Daniel Hadley 8209	PO Box 601 Kotara			
26/10/2020	DATE	25 : Daniel Hadley 8209	designs			

3 OF 3

Specification Plan

LINE 100920

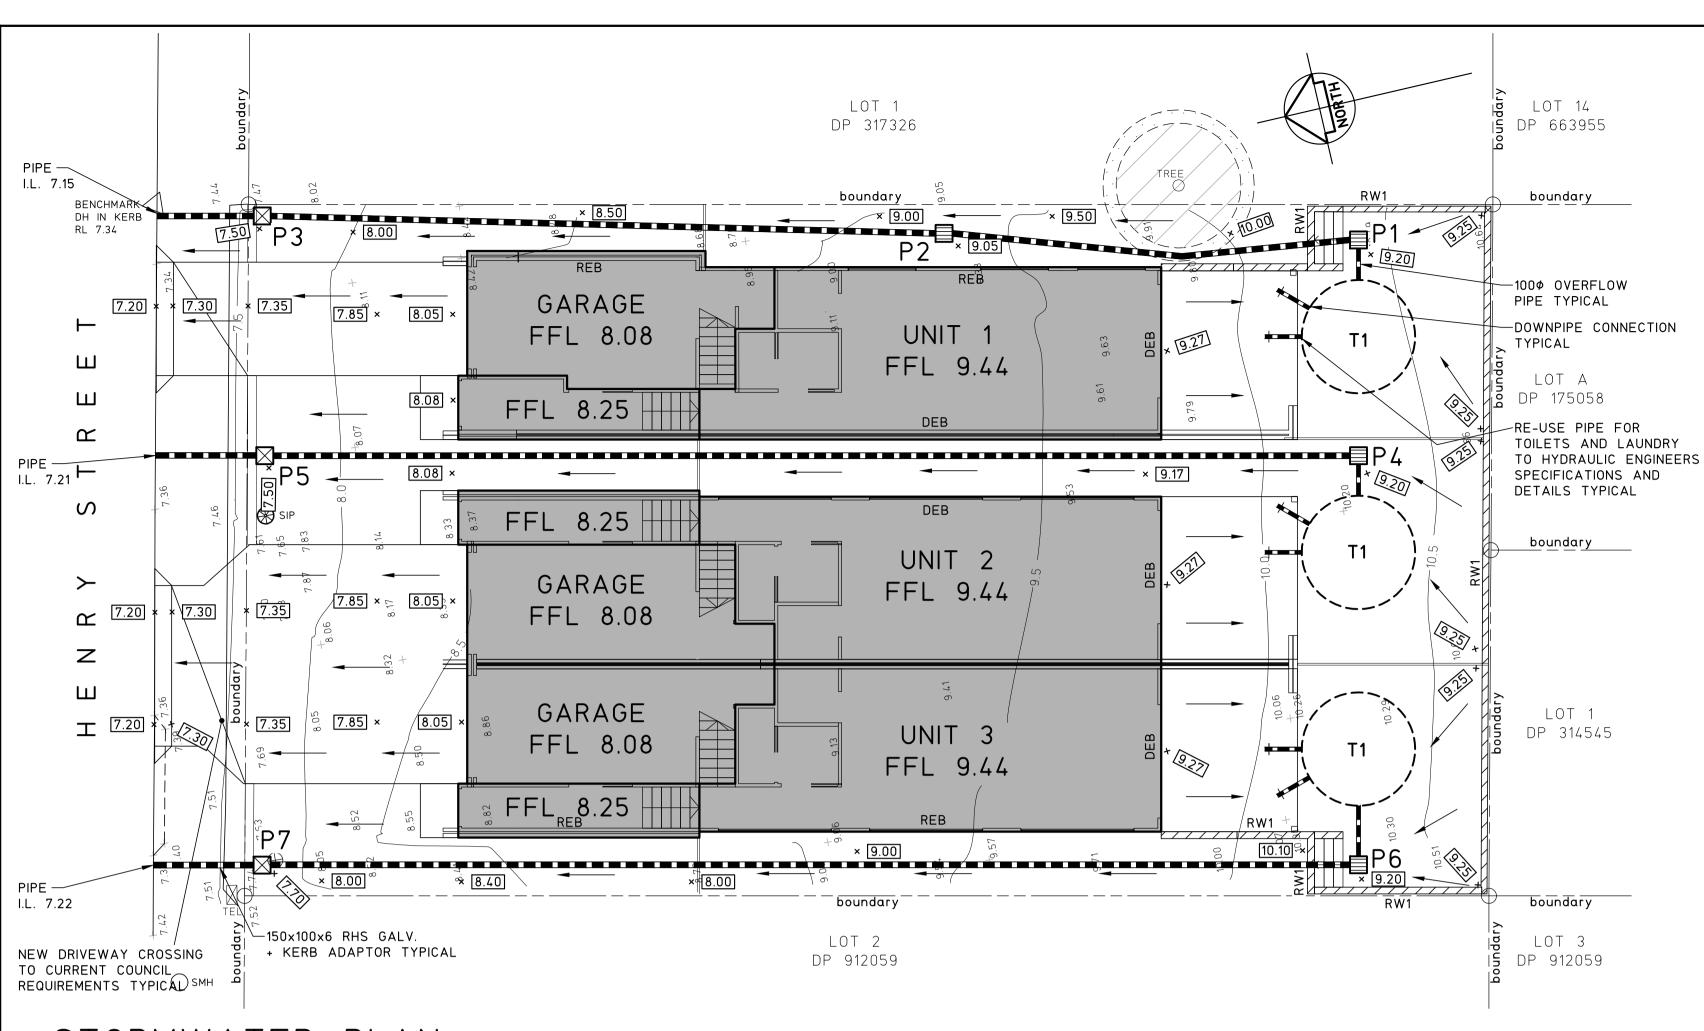

STORMWATER PLAN

SCALE 1:100 STORMWATER NO

- STORMWATER NOTES

 1. ALL WORKS TO BE IN ACCORDANCE WITH AS3500.3.
- 2. ALL PIPES TO HAVE A 1% MINIMUM FALL U.N.O.
 3. ALL DOWNPIPES (DP) TO BE SPECIFIED BY ARCHITECT. FOR EXACT LOCATION OF DOWNPIPES, REFER TO ARCHITECTURAL DRAWINGS.
- 4. ALL PIPES TO BE UPVC U.N.O
 5. ALL UPVC PIPES TO BE SEWER GRADE AND TO AS1260.
- 6. ALL REINFORCED CONCRETE PIPES (RCP) TO BE SPIGOT AND SOCKET TYPE WITH RUBBER RINGS CLASS 2 TO AS4058.
- 7. PITS TO BE CI&D REINFORCED PRE-CAST CONCRETE PITS OR EQUIVALENT PROPRIETARY PITS.
 8. ALL LIDS AND GRATES TO BE PROPRIETARY HEAVY DUTY IN AREAS OF VEHICULAR TRAFFIC, LIGHT DUTY ELSEWHERE, IN ACCORDANCE WITH AS3996.
- 9. MINIMUM COVER TO STORMWATER PIPES TO BE AS FOLLOW U.N.O: TRAFFICABLE AREAS - 450mm, LANDSCAPED AREAS - 300mm.
- PIPES TO BE CONCRETE ENCASED IF MINIMUM COVERS CANNOT BE OBTAINED IN TRAFFICABLE AREAS, REFER TO CLAUSE 3.8 AS3500.3. ALTERNATIVELY USE UPVC SEWER GRADE PIPES UNDER ROAD AND BUILDINGS.
- 10.PROVIDE 100¢ AG DRAINS IN FILTER SOCKS TO ALL LANDSCAPED AREAS, PLANTER BEDS AND STORMWATER PIPE TRENCHES. ALL AG DRAINS TO BE BEDDED IN COARSE AGGREGATE AND TO BE CONNECTED TO STORMWATER SYSTEM.
- 11. ALL PITS, DETENTION TANKS AND PROPRIETARY POLLUTION CONTROL DEVICES TO BE CLEANED OF SEDIMENT AT 3 MONTH MAXIMUM INTERVALS.
- 12. ALL EXISTING SERVICES TO BE LOCATED PRIOR TO COMMENCEMENT OF WORK.
- 13. ANY FOOTPATHS, KERB AND GUTTER OR ROADWAY DISTURBED BY WORKS TO BE REINSTATED TO CURRENT COUNCIL REQUIREMENTS.
 14. PROVIDE ACCESS LADDER TO TANK AS REQUIRED, REFER TO AS1657.

PIT SCHEDULE					
PIT No.	SIZE	TYPE	SURFACE LEVEL S.L.	INVERT LEVEL I.L.	
P1	450×450	GRATED PIT	9.20	8.80 (PIPE IL)	
P2	450×450	GRATED PIT	9.05	8.65	
Р3	450×450	GRATED PIT	7.50	7.23	
P4	450×450	GRATED PIT	9.20	8.80 (PIPE IL)	
P5	450×450	GRATED PIT	7.50	7.26	
Р6	450×450	GRATED PIT	9.20	8.80 (PIPE IL)	
P7	450×450	GRATED PIT	7.70	7.27	

DENOTES EXISTING LEVELS DENOTES DESIGN SPOT LEVELS DENOTES RETAINING WALL DENOTES RETAINING EDGE BEAM TO BUILDING SLAB OR PAVEMENT DENOTES DROPPED EDGE BEAM TO BUILDING SLAB OR PAVEMENT DENOTES DIRECTION OF SURFACE FLOWS DENOTES 4000 LITRE UNDERGROUND WATER STORAGE TANK STORING ROOF RAINWATER TO MANUFACTURERS SPECIFICATION. TANK SHALL BE FITTED WITH A FIRST FLUSH SYSTEM, PUMP TO SUPPLY TOILETS AND LAUNDRY AND A DIVERSION SWITCH TO MAINS SUPPLY ON TANK BEING EMPTY. BACK FLOW PREVENTION TO MAINS WATER SHALL BE PROVIDED. TANK TO OVERFLOW TO STORMWATER SYSTEM.

DENOTES 100¢ PIPE U.N.O.

DENOTES EXISTING CONTOUR

NOTE SETOUT AND ALIGNMENT OF WALLS TO BOUNDARY TO ARCHITECTS DETAILS TYPICAL

LEGEND

ALL SETOUT, DIMENSIONS
AND RL'S TO ARCHITECTS
SPECIFICATION & DETAILS

NOTE
ALL DOWNPIPES FROM EACH UNIT TO CONNECT
TO EACH UNITS SLIMLINE ABOVE GROUND

WATER STORAGE TANK TYPICAL

NOTE
BUILDER TO PROVIDE ADEQUATE SHORING
IN ORDER TO MAINTAIN STABILITY
OF EXISTING NEIGHBOURING STRUCTURES
AND FENCES DURING EXCAVATION WORKS
TYPICAL

NOTE
DRIVEWAY GRADES TO CURRENT COUNCIL
REQUIREMENTS. BUILDER TO CONFIRM GRADES
PRIOR TO CONSTRUCTION OF DRIVEWAY

NOTE
ALL STRIP DRAINS RETAINING
WALLS (RW1) TO CONNECT TO
STORMWATER SYSTEM
TYPICAL

OVERFLOW PIPE — 4000 LITRE UNDERGROUND AND SUBSOIL PIPE WATER STORAGE TANK TO DRAINAGE SYSTEM TO MANUFACTURERS SPECIFICATION LOCKED GRATE LID < TANK RISER -AND LID BEYOND OVERFLOW PIPE ∕ĎOWNPIÝE INLEŤ-PIPE BEYOND ´OPÉRATING´ RE-USE WATER 3500L RÁINWATÉR RETICULATIÓN TO HYDRAULIC ENGINEERS /DETAILS RAÍNSÁVEŔ SÚBMÉRSÍBLE PRESSURE PUMP TO HYDRAULIC ENGINEERS DETAILS `PERMANENT\ WATER 500L

NOT FOR CONSTRUCTION

			© Copyright MPC Consulting Engineers as date of issue		
			USED FOI	THIS DRAWING IS NOT TO BE R CONSTRUCTION UNLESS ENDORSED BE	LOW
2	REVISED DEVELOPMENT APPLICATION	3.9.21			
1	REVISED DEVELOPMENT APPLICATION	6.7.21			
0	DEVELOPMENT APPLICATION	22.10.20			
ISSUE	REASON FOR ISSUE	DATE	DATE OF RELEASE	RESPONSIBLE PRINCIPAL SIGNATURE	ISSUE

COPYRIGHT

he concepts and information contained
this document are the copyright of
PC Consulting Engineers
se or copying of the document in whole
r in part without the written permission
f MPC Consulting Engineers constitutes
n infringement of copyright.

Consulting engineers civil+structural

Level 1,
16 Telford Street,
NEWCASTLE EAST, NSW 2300
PO BOX 553
THE JUNCTION, NSW 2291
Tel: (02) 4927 5566
Fax: (02) 4927 5577
Email: admin@mpceng.com.au
Web: www.mpceng.com.au
A.C.N. 098 542 575

STORMWATER PLAN
LINEFRONT PTY LTD
CLIENT

AND DETAILS

PROJECT
PROPOSED MULTI-DWELLING AT;
PROPOSED MULTI-DWELLING AT; LOT 6, DP 61, SEC. D
No.57A HENRY STREET,
TIGHES HILL

TYPICAL TANK (T1) DETAIL

SCALE 1:20

	DO NOT SCALE DRAWING				
	DRAWN	ENGINEER	No in SET	SHEET	
	L.C.	P.M.	1	A1	
	SCALES	JOB No	DRAWING No	ISSUE	
	1:100, 20	210151	C01	2	
/	5 6 7 8	3 9 10 1	1 12 13 1	/. 15 cm	

FULL SIZE ON ORIGINAL 0 1 2 3 4 5 6 7 8 9 10 11 12 13 14 15 cn



ATTACHMENTS DISTRIBUTED UNDER SEPARATE COVER

DAC 16/11/21 - 57A Henry Street Tighes Hill - DA2020/01328 - Multi Dwelling housing – demolition of existing structures, erection of three storey dwellings and 1 into 3 lot subdivision.

ITEM-22 Attachment B: Draft Schedule of Conditions

Development Applications Committee Meeting 16 November 2021



DRAFT SCHEDULE OF CONDITIONS



Application No: DA2020/01328

Land: Lot 6 Sec D DP 61

Property Address: 57A Henry Street Tighes Hill, NSW 2297

Proposed Development: Multi dwelling housing - demolition of existing structures,

erection of three two storey dwellings and one into three lot

subdivision

SCHEDULE 1

APPROVED DOCUMENTATION

1. The development is to be implemented in accordance with the plans and supporting documents set out in the following table except where modified by any conditions of this consent.

Plan No / Supporting	Reference /	Prepared by	Dated
Document	Version		
Demolition Plan	DA020 Issue B	ELK Designs	20/10/2021
Site Plan	DA030 Issue J	ELK Designs	20/10/2021
Ground Floor Plan	DA100 Issue J	ELK Designs	20/10/2021
First Floor Plan	DA110 Issue I	ELK Designs	20/10/2021
Roof Plan	DA150 Issue E	ELK Designs	20/10/2021
Elevations (North & Dwelling 1 East)	DA300 Issue H	ELK Designs	20/10/2021
Elevations (South & Dwelling 3 West)	DA301 Issue I	ELK Designs	20/10/2021
Elevations (Dwelling 3 East & Dwelling 2 West)	DA302 Issue G	ELK Designs	20/10/2021
External Finishes	DA350 Issue E	ELK Designs	20/10/2021
Sections	DA400 Issue G	ELK Designs	20/10/2021
Sediment & Erosion Control	DA960 Issue B	ELK Designs	20/10/2021
Landscape Plan	Sheet 2 of 3	JK'sGarden Creations	26/10/2020
Landscape Specification Plan	Sheet 3 of 3	JK'sGarden Creations	26/10/2020
Draft Plan of Subdivision	Sheet 1 of 1	Timothy R. Rheinberger	19.10.2021
Stormwater Management	Drg. C01 issue 2	MPC Consulting	3/09/2021
Plan	Sheet A1	Engineers	
BASIX Certificate	No. 1141310M_02	Evergreen Energy Consultants Pty Ltd	07/09/2021
Arborist Report	57a Henry Street, Tighes Hill	Abacus Tree Services	29/09/2020

In the event of any inconsistency between conditions of this development consent and the plans/supporting documents referred to above, the conditions of this development consent prevail.

CONDITIONS TO BE SATISFIED PRIOR TO THE ISSUE OF A CONSTRUCTION CERTIFICATE

2. A total monetary contribution of \$9,000.00 is to be paid to the City of Newcastle, pursuant to Section 7.12 of the *Environmental Planning and Assessment Act 1979*, such contribution to be payable prior to the issue of a Construction Certificate in respect of the proposed development.

Note:

- i) This condition is imposed in accordance with the provisions of the City of Newcastle's Section 7.12 Newcastle Local Infrastructure Contributions Plan 2019.
- ii) The City of Newcastle's Section 7.12 Newcastle Local Infrastructure Contributions Plan 2019 permits deferred or periodic payment of levies in certain circumstances. A formal modification of this condition will be required to enter into a deferred or periodic payment arrangement.
- iii) The amount of contribution payable under this condition has been calculated on the basis of the current rate as at the date of consent and is based on the most recent quarterly Consumer Price Index (CPI) release made available by the Australian Bureau of Statistics (ABS). The CPI index rate is expected to rise at regular intervals and therefore the actual contribution payable is indexed and recalculated at the CPI rate applicable on the day of payment.

CPI quarterly figures are released by the ABS on a date after the indexation quarter and, as a guide, these approximate dates are as follows:

Indexation quarters	Approximate release date
September	Late October
December	Late January
March	Late April
June	Late July

Any party intending to act on this consent should contact City of Newcastle's Customer Enquiry Centre for determination of the indexed amount of contribution on the date of payment.

- 3. Roof water from the proposed new work is to be directed to the proposed water tanks with a minimum capacity of 4,000 litres per dwelling and being reticulated to any new toilet cisterns and cold-water washing machine taps, with a mains water top up being installed to maintain between 10% and 15% of the tank capacity. Alternatively, an electronically activated mechanical valve device is to be installed to switch any new toilet cisterns and laundry taps to mains water when the tank falls below 10% capacity. The water tanks and plumbing is to be designed in accordance with the Plumbing Code of Australia (National Construction Code Volume 3). Full details are to be included in documentation for a Construction Certificate application.
- 4. Overflows from the roof water tank and any additional discharge controls (if required) are to be directed to City of Newcastle's drainage system by means of an interallotment drainage line or underground pipe directly to the street gutter. Details are to be included in documentation for a Construction Certificate application.
- 5. All new impervious surfaces, including driveways and paved areas are to be drained to the nominated discharge controls. Details are to be included in documentation for a

Construction Certificate application.

- 6. All proposed planting and landscape elements indicated on the submitted landscape concept plan or otherwise required by the conditions of this consent are to be detailed on a comprehensive landscape plan and specification. The plan and specification are to be prepared in accordance with the provisions of Newcastle Development Control Plan 2012 and is to include details of the following:
 - a) cross sections through the site
 - b) proposed contours or spot levels
 - c) botanical names
 - d) quantities and container size of all proposed trees
 - e) shrubs and ground cover
 - f) details of proposed soil preparation
 - g) mulching and staking
 - h) treatment of external surfaces and retaining walls where proposed
 - i) drainage, location of taps and
 - j) maintenance periods.

The plan and specification are to be prepared by a qualified landscape designer and be included in documentation for a Construction Certificate application.

- 7. The applicant is to comply with all requirements of the Hunter Water Corporation regarding the connection of water supply and sewerage services, including the payment of any required cash contribution towards necessary amplification of service mains in the locality as a result of the increased intensity of land use proposed. A copy of the Corporation's compliance certificate (refer Section 50 *Hunter Water Act 1991*) is to be included in documentation for a Construction Certificate application.
- 8. Facilities are to be provided within the proposed individual private courtyards, or in another screened location, for the storage of garbage. Full details are to be included in documentation for a Construction Certificate application.
- 9. Erosion and sediment control measures are to be implemented prior to the commencement of works and be maintained during the period of construction in accordance with the details set out on an Erosion and Sediment Control Plan that is to be submitted for approval with the Construction Certificate application. Controls are not to be removed until the site is stable with all bare areas supporting an established vegetative cover.
- 10. A residential vehicular crossing is to be constructed across the road reserve to each dwelling, in accordance with the following criteria:
 - Constructed in accordance with City of Newcastle's A1300 Driveway Crossings Standard Design Details.
 - b) The driveway crossing, within the road reserve, is to be a maximum of 3m wide.
 - c) Letterboxes, landscaping and any other obstructions to visibility are to be kept clear of or limited in height to 1.2m, in the 2.0m by 2.5m splay within the property boundary, each side of the driveway entrance.

- d) The proposed driveway is to be a minimum of 3.0m clear of the trunk of any tree within the road reserve.
- e) The proposed driveway is to be a minimum of 750mm clear of the centre of any pole or obstruction within the road reserve and 1.0m clear of any drainage pit.

These works are not approved until consent under Section 138 of the *Roads Act 1993* has been granted by the City of Newcastle.

- 11. A separate application is to be lodged and consent obtained from the City of Newcastle for all works within the road reserve pursuant to Section 138 of the *Roads Act 1993*. The consent is to be obtained, or other satisfactory arrangements confirmed in writing from the City of Newcastle, before the issue of a Construction Certificate.
- 12. All stormwater runoff from the proposed development is to be managed in accordance with the requirements of Element 7.06 'Stormwater' of Newcastle Development Control Plan 2012, the associated Technical Manual and AS/NZS 3500.3 Plumbing and drainage Part 3 Stormwater drainage, as indicated on the stormwater management concept plan prepared by MPC Consulting Engineers (Job. No. 210152, Drg. No. C01, dated 3/09/2021) Details are to be included in documentation for a Construction Certificate application.

CONDITIONS TO BE SATISFIED PRIOR TO THE COMMENCEMENT OF WORK AND DURING THE CONSTRUCTION PHASE

- 13. A Registered Surveyor's certificate detailing the setting out of the proposed building on the site, including the relationship of the set out building to property boundaries, is to be submitted to the Principal Certifier before construction is commenced.
- 14. A survey certificate prepared by a Registered Surveyor is to be submitted to the Principal Certifier upon completion of the floor slab formwork, before concrete is poured, to verify that the siting of the building in relation to adjacent boundaries is in accordance with the development consent.
- 15. Certification is to be prepared by a Registered Surveyor and submitted to the Principal Certifier on completion of the retaining wall construction, confirming that the location of the wall/walls is consistent with the approved location.
- 16. Certification is to be prepared by a Registered Surveyor and submitted to the Principal Certifier on completion of the retaining wall construction, verifying that finished levels are consistent with the approved levels.
- 17. Toilet facilities are to be available or provided at the work site before works begin and be maintained until the works are completed, at a ratio of one toilet plus one additional toilet for every 20 persons employed at the site.

Each toilet is to:

- a) Be a standard flushing toilet connected to a public sewer, or
- b) Have an on-site effluent disposal system approved under the *Local Government Act 1993*, or
- c) Be a temporary chemical closet approved under the Local Government Act 1993.
- 18. Building demolition is to be planned and carried out in accordance with *Australian Standard* 2601:2001 The Demolition of Structures.

- 19. A Hazardous Substances Management Plan is to be prepared by a competent person for the building(s) or parts of the building(s) proposed to be demolished in accordance with *Australian Standard 2601:2001 The Demolition of Structures*. A copy of the Hazardous Substances Management Plan is to be provided to the City of Newcastle and to the demolisher prior to commencement of work.
- 20. Demolition works are to be undertaken in accordance with *Australian Standard* 2601:2001 The Demolition of Structures and the following requirements:
 - Demolition works are to be conducted in accordance with the submitted Hazardous Substances Management Plan and a copy of the Hazardous Substances Management Plan is to be kept on site for the duration of the proposed development;
 - b) The removal, handling and disposal of any asbestos material is to be undertaken only by an asbestos removal contractor who holds the required class of Asbestos Licence, issued by SafeWork NSW;
 - A copy of all waste disposal receipts are to be kept on site for the duration of the proposed development and made available to authorised City of Newcastle officers upon request;
 - d) Seven working days' notice in writing is to be given to the City of Newcastle and the owners/occupiers of neighbouring premises prior to the commencement of any demolition work. Such written notice is to include the date demolition will commence and details of the name, address, contact telephone number(s) and licence details (type of licences held and licence numbers) of any asbestos removal contractor and demolition contractor. Notification to owners/occupiers of neighbouring premises is also to include City of Newcastle's contact telephone number (4974 2000) and the SafeWork NSW telephone number (4921 2900); and
 - e) On sites where asbestos materials are to be removed, a standard commercially manufactured sign containing the words 'DANGER ASBESTOS REMOVAL IN PROGRESS' measuring not less than 400mm x 300mm is to be erected in a prominent position during asbestos removal works.
- 21. The demolisher is to ensure that all services (ie water, telecommunications, gas, electricity, sewerage etc), are disconnected in accordance with the relevant authority's requirements prior to demolition.
- 22. Any waste containers used in association with the proposed demolition are to be located on the site where possible.

Note: Where this is not feasible, an application is to be made for the City of Newcastle's approval to position the container on the adjacent public road in accordance with City of Newcastle's adopted Building Waste Container Policy.

23. All demolition material incapable of being re-used in future redevelopment of the site is to be removed from the site and the site being cleared and levelled.

Note: Where reusable building materials are to be stored on site for use in future building works, such materials are to be neatly stacked at least 150 mm above the ground.

- 24. The demolisher is to ensure that all demolition material is kept clear of the public footway and carriageway as well as adjoining premises.
- 25. Waste management is to be implemented in accordance with the approved Waste

Management Plan. At a minimum, the following measures are to be implemented during the construction phase:

- A waste container of at least one cubic metre capacity is to be provided, maintained and regularly serviced from the commencement of operations until the completion of the building, for the reception and storage of waste generated by the construction of the building and associated waste;
- b) The waste container is to be, at minimum, constructed with a 'star' picket (corners) and weed control mat (sides), or equivalent. The matting is to be securely tied to the pickets;
- c) Provision is to be made to prevent windblown rubbish leaving the site; and
- d) Footpaths, road reserves and public reserves are to be maintained clear of rubbish, building materials and all other items.

Note: Fines may be issued for pollution/littering offences under the *Protection of the Environment Operations Act 1997*.

- 26. A rigid and durable sign is to be erected on any site on which building work, subdivision work or demolition work is being carried out, before the commencement of the work:
 - a) showing the name, address and telephone number of the Principal Certifier for building work and subdivision work, and
 - b) showing the name, address and telephone number of the Principal Contractor for any building work and also including a telephone number on which the Principal Contractor may be contacted at any time for business purposes, and
 - c) stating that unauthorised entry to the work site is prohibited, and
 - d) being erected in a prominent position that can be read easily by anyone in any public road or other public place adjacent to the site.

Any such sign is to be maintained while the building work, subdivision work or demolition work is being carried out.

- 27. All excavations and backfilling are to be executed safely and excavations are to be properly guarded and protected to prevent them from being dangerous to life and property.
- 28. All building materials, plant and equipment is to be placed on the site of the development, to ensure that pedestrian and vehicular access in public places is not restricted and to prevent damage to the road reserve. The storage of building materials on City of Newcastle reserves, including the road reserve, is not permitted.
- 29. Any alteration to natural surface levels on the site is to be undertaken in such a manner as to ensure that there is no increase in surface water runoff to adjoining properties or that runoff is impounded on adjoining properties, as a result of the development.
- 30. Construction/demolition work that generates noise that is audible at residential premises is to be restricted to the following times:
 - Monday to Friday, 7:00 am to 6:00 pm and
 - Saturday, 8:00 am to 1:00 pm.

No noise from construction/demolition work is to be generated on Sundays or public holidays.

31. City of Newcastle's 'Prevent Pollution' sign is to be erected and maintained in a conspicuous location on or adjacent to the property boundary, so it is clearly visible to the public, or at other locations on the site as otherwise directed by the City of Newcastle, for the duration of demolition and construction work.

The sign can be obtained by presenting your development application receipt at City of Newcastle's Customer Enquiry Centre, Wallsend Library or the Master Builders Association Newcastle.

- 32. Erosion and sediment control measures are to be implemented prior to the commencement of works and maintained during the period of demolition and/or construction in accordance with the requirements of Managing Urban Stormwater: Soils and Construction 4th Edition Vol. 1 (the 'Blue Book') published by Landcom, 2004. Controls are not to be removed until the site is stable with all bare areas supporting an established vegetative cover.
- 33. Where the proposed development involves the destruction or disturbance of any survey monuments, those monuments affected are to be relocated, at no cost to the City of Newcastle, by a Surveyor registered under the Surveying and Spatial Information Act 2002.
- 34. All public trees that are required to be retained are to be protected in accordance with the City of Newcastle *Urban Forest Technical Manual*, Part B *Public Trees*.

The tree protection fencing is to remain in place and be maintained until all works have been completed, with no waste materials, washouts, equipment or machinery to be stored within the fenced area.

- 35. All building work is to be carried out in accordance with the provisions of the National Construction Code.
- 36. In the case of residential building work for which the *Home Building Act 1989* requires there to be a contract of insurance in force, such a contract of insurance is to be in force before any building work authorised to be carried out by this consent commences.
- 37. If the soil conditions require it, retaining walls associated with the erection or demolition of a building or other approved methods of preventing movement of the soil are to be provided. Any proposed paving works within the Henry Street public footway are to be in accordance with City of Newcastle's specification (Form PLE/SOO9).

Note: It will be necessary for the developer to notify water, telecommunications, gas and electricity authorities of the proposed paving works, before such works are commenced, in order to enable the various authorities to carry out and complete any necessary repairs and/or amplification to their respective services.

- 38. All roof and surface waters are to be conveyed to the street gutter by way of a sealed pipe system, extending through the footway to City of Newcastle requirements, in accordance with Element 7.06 'Stormwater' of Newcastle Development Control Plan 2012.
- 39. Prior to the commencement of work, a 3.0m wide all-weather vehicle access is to be provided from the kerb and gutter to the building under construction, to reduce the potential for soil erosion. Sand or soil is not to be stockpiled on the all-weather vehicle access.
- 40. All necessary measures are to be undertaken to control dust pollution from the site. These measures are to include, but are not limited to:

- a) Restricting topsoil removal;
- b) Regularly and lightly watering dust prone areas (note: prevent excess watering as it can cause damage and erosion);
- c) Alter or cease construction work during periods of high wind; and
- d) Erect green or black shadecloth mesh or similar products 1.8m high around the perimeter of the site and around every level of the building under construction.

CONDITIONS TO BE SATISFIED PRIOR TO THE ISSUE OF AN OCCUPATION CERTIFICATE, A SUBDIVISION CERTIFICATE OR A STRATA CERTIFICATE

- 41. Any redundant existing vehicular crossing is to be removed at no cost to the City of Newcastle. The road reserve and kerb is to be restored to the City of Newcastle's satisfaction. Works are to be completed prior to the issuing of an Occupation Certificate for the proposed development.
- 42. All public footways, footpaving, kerbs, gutters and road pavement damaged during the works are to be immediately repaired following the damage, to a condition that provides for safe use by pedestrians and vehicles. Full restoration of the damage is to be carried out to City of Newcastle's satisfaction prior to the completion of demolition work or prior to the issue of any Occupation Certificate in respect of development involving building work.
- 43. All commitments listed in the relevant BASIX certificate for the development are to be satisfactorily completed prior to the issue of an Occupation Certificate. Should there be any changes to the specifications of the dwelling that have implications for compliance with the approved certificate, except where restricted or excluded by any other condition of consent, an amended BASIX Certificate can be relied upon as having complied with this condition. A copy of any amended BASIX Certificate is to be provided to the City of Newcastle with Occupation Certificate documentation.
- 44. All works within the road reserve required by this consent are to be completed prior to the issue of a Occupation Certificate.
- 45. A Landscape Practical Completion Report is to be submitted to the Principal Certifier prior to the issue of an Occupation Certificate. The report is to verify that all landscape works have been carried out in accordance with the comprehensive landscape design plan and specifications that were required to be included in documentation for a Construction Certificate application and is to verify that an effective maintenance program has been commenced.
- 46. The premises are to be identified by the provision of house numbers on the building exterior and mailbox such that they are clearly visible from the road frontage.
 - The minimum numeral height is to be 75mm.
- 47. An application is to be made for a Subdivision Certificate. The application is to be supported by a survey plan of subdivision, the Administration Sheet and a Section 50 Certificate from the Hunter Water Corporation.
- 48. An instrument under Section 88B of the *Conveyancing Act 1919*, setting out the terms of easements as required by this consent, along with related notations on the plan of subdivision, are to be submitted to the City of Newcastle for certification. The City of Newcastle is to be identified as a party whose consent is required to release, vary or modify easements.

- 49. Written evidence of arrangements having been made with the Hunter Water Corporation for the provision of water supply and sewerage and with the electricity authority for the provision of overhead or underground electricity supply is to be submitted to the Principal Certifier prior to the issue of a Subdivision Certificate.
- 50. Written evidence of arrangements having been made with the telecommunications authority for the provision of underground telecommunications services to the lots is to be submitted to the Principal Certifier prior to the issue of a Subdivision Certificate.
- 51. The approved multi dwelling housing development on the site is to be completed to at least lock-up stage prior to the issue of the Subdivision Certificate.

Lock-up stage is taken to mean the stage at which a building's external wall cladding and roof covering is fixed and external doors and windows are fixed (even if those doors and windows are only temporary).

CONDITIONS TO BE SATISFIED DURING THE OPERATION AND USE THE DEVELOPMENT

- 52. A Landscape Establishment Report is to be submitted to the City of Newcastle following completion of a three month maintenance period, verifying that satisfactory maintenance of the landscape works has been undertaken and any necessary rectification measures have been carried out.
- 53. The premise/s is/are allocated the following street address/es in accordance with City of Newcastle's *House Numbering Policy* and the *Surveying and Spatial Regulation*.

City of Newcastle allocated street address/es					
Unit/ dwelling number on plan	Unit	Street number	Street name	Street type	Suburb
1	3	57A	Henry	Street	Tighes Hill
2	2	57A	Henry	Street	Tighes Hill
3	1	57A	Henry	Street	Tighes Hill

ADVISORY MATTERS

- It is recommended that, prior to commencement of work, the free national community service 'Dial before you Dig' be contacted on 1100 or by fax on 1200 652 077 regarding the location of underground services in order to prevent injury, personal liability and even death. Inquiries should provide the property details and the nearest cross street/road.
- Any necessary alterations to public utility installations are to be at the developer/demolisher's expense and to the requirements of the City of Newcastle and any other relevant authorities. City of Newcastle and other service authorities should be contacted for specific requirements prior to the commencement of any works.
- It is an offence under the provisions of the *Protection of the Environment Operations Act 1997* to act in a manner causing, or likely to cause, harm to the environment. Anyone allowing material to enter a waterway or leaving material where it can be washed off-site may be subject to a penalty infringement notice (ie 'on-the-spot fine') or prosecution.
- Failure to comply with the conditions of consent constitutes a breach of the

Environmental Planning and Assessment Act 1979, which may be subject to a penalty infringement notice (ie 'on-the-spot fine') or prosecution.

- Retaining walls not clearly noted on the approved plans or outside of the parameters of 'exempt development', as specified in State Environmental Planning Policy (Exempt and Complying Development Codes) 2008, are to be subject to a separate development application. An application in this regard is to be approved prior to any works relating to such a retaining wall taking place.
- An application is to be submitted to the City of Newcastle for the removal or pruning of any trees located more than three metres from the dwelling wall, measured from the centre of the trunk to the footings of the dwelling, excluding carports and pergolas.
- Any approval for fences on side boundaries, common to other private properties, is independent of any consent or agreement which may be required from any adjoining owner under the provisions of the *Dividing Fences Act 1991*.
- Prior to commencing any building works, the following provisions of Part 6 of the *Environmental Planning and Assessment Act 1979* are to be complied with:
 - a) A Construction Certificate is to be obtained; and
 - b) A Principal Certifier is to be appointed for the building works and the City of Newcastle is to be notified of the appointment; and
 - c) The City of Newcastle is to be given at least two days notice of the date intended for commencement of building works.
- Prior to the occupation or use of a new building, or occupation or use of an altered portion of, or an extension to a building, an Occupation Certificate is to be obtained from the Principal Certifier appointed for the proposed development. An application for an Occupation Certificate is to contain the information set out in Clause 149 of the Environmental Planning and Assessment Regulation 2000.

END OF CONDITIONS

SCHEDULE 2

REASONS FOR THE DETERMINATION & CONSIDERATION OF COMMUNITY VIEWS

The determination decision was reached for the following reasons:

- The proposed development, subject to the recommended conditions, is consistent with the objectives of the applicable environmental planning instruments, being; Newcastle Local Environmental Plan 2012 (NLEP) and applicable State Environmental Planning Policies
- The proposed development is, subject to the recommended conditions, consistent with the objectives of the Newcastle Development Control Plan 2012 (NDCP).
- The proposed development is considered to be of an appropriate scale and form for the site and the character of the locality.
- The proposed development has appropriate management and mitigation of impacts through conditions of consent.
- The proposed development, subject to the recommended conditions, will not result in unacceptable adverse impacts upon the natural or built environments.
- The proposed development is a suitable and planned use of the site and its approval is within the public interest.

REASONS WHY THE CONDITIONS HAVE BEEN IMPOSED

The following conditions are applied to:

- Confirm and clarify the terms of Council's determination;
- Identify modifications and additional requirements that will result in improved compliance, development and environmental outcomes;
- Prevent, minimise, and/or offset adverse environmental impacts including economic and social impacts;
- Set standards and measures for acceptable environmental performance; and
- Provide for the ongoing management of the development.



ATTACHMENTS DISTRIBUTED UNDER SEPARATE COVER

DAC 16/11/21 - 57A Henry Street Tighes Hill - DA2020/01328 - Multi Dwelling housing – demolition of existing structures, erection of three storey dwellings and 1 into 3 lot subdivision.

ITEM-22 Attachment C: Processing Chronology

Development Applications Committee Meeting 16 November 2021





PROCESSING CHRONOLOGY

DA2020/01328 - 57A Henry Street Tighes Hill

18 November 2020	Application lodged
23 November 2020 - 7 December 2020	Public notification
14 December 2020	Additional information requested
14 January 2021	Amended shadow plans submitted
9 February 2021	Additional information requested
19 March 2021	Amended information submitted
6 April 2021	Amended information submitted
13 April - 27 April 2021	Public notification of amended plans
7 May 2021	Amended plans submitted
23 May 2021	Application called into Council
15 July 2021	Public Voice Committee Meeting
19 July 2021	Amended Documentation and Response to PV
7 September 2021	Character Analysis & Amended Documentation