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DAC 21/02/2023 – 13 WILTON STREET MEREWETHER – DA2022/00438 - SEMI-DETACHED DWELLING - INCLUDING DEMOLITION OF EXISTING STRUCTURES

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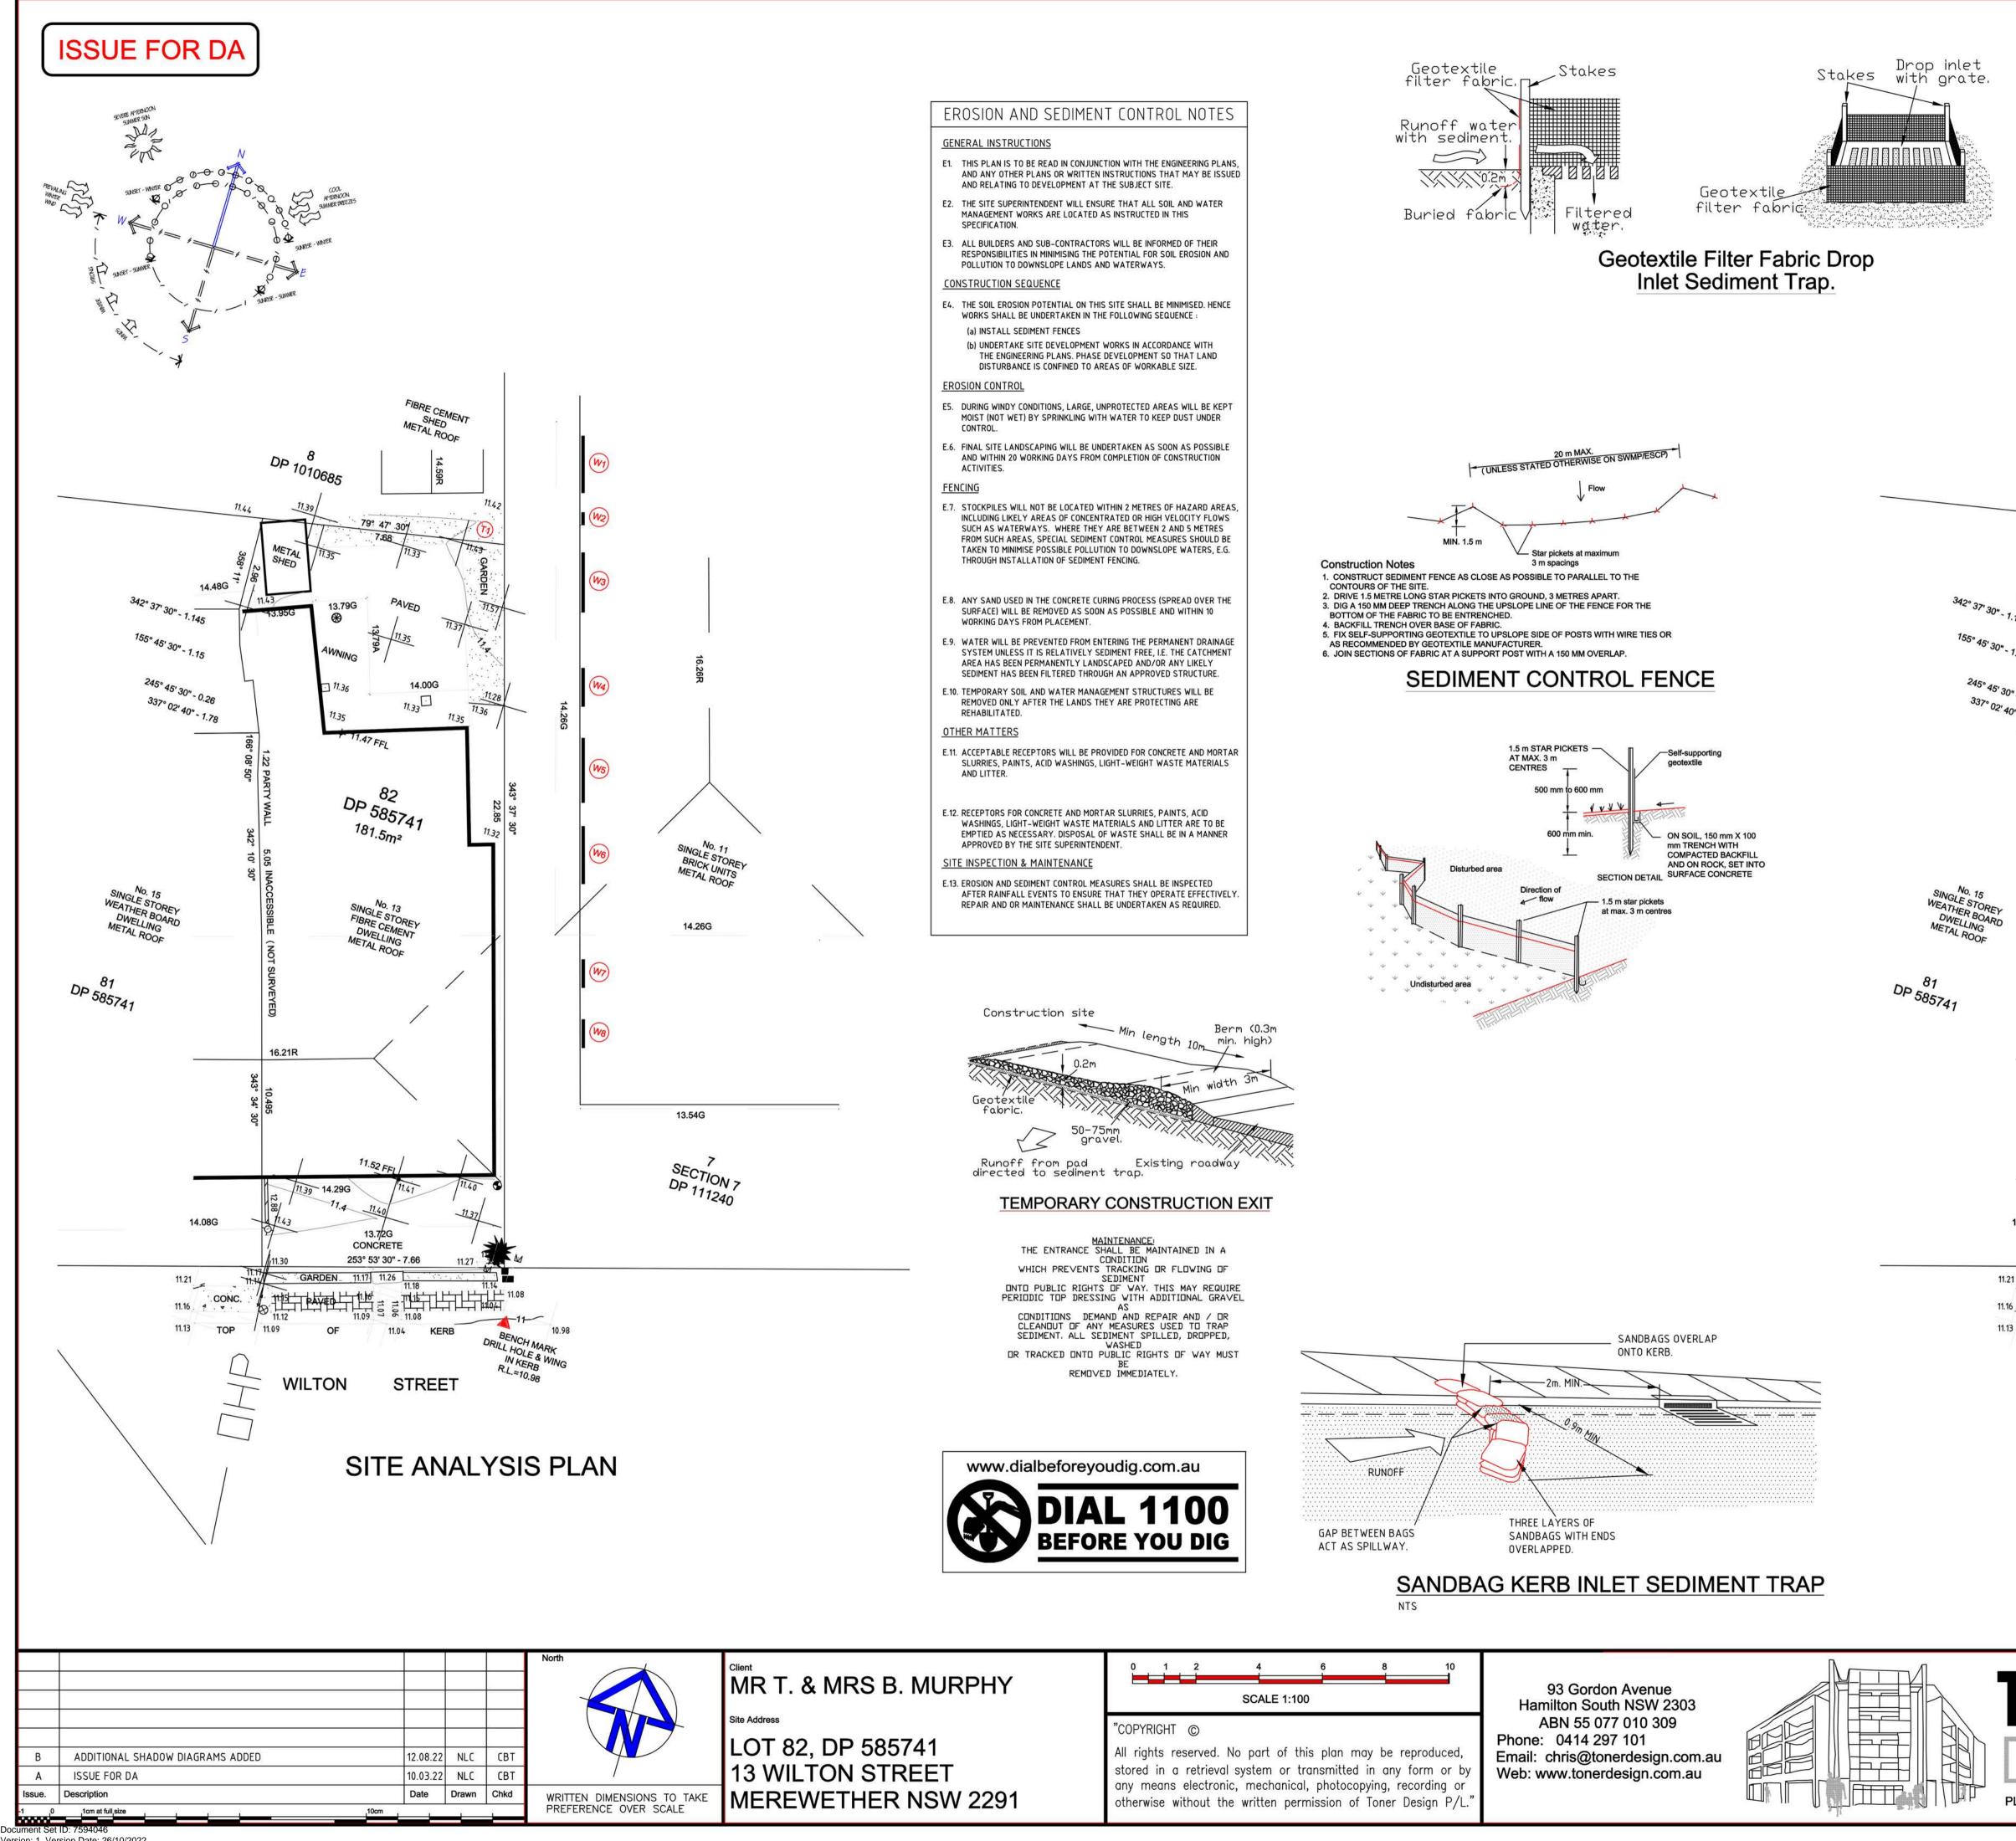
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DAC 21/02/2023 – 13 WILTON STREET MEREWETHER – DA2022/00438 - SEMI-DETACHED DWELLING - INCLUDING DEMOLITION OF EXISTING STRUCTURES

ITEM-1 Attachment A: Submitted Plans



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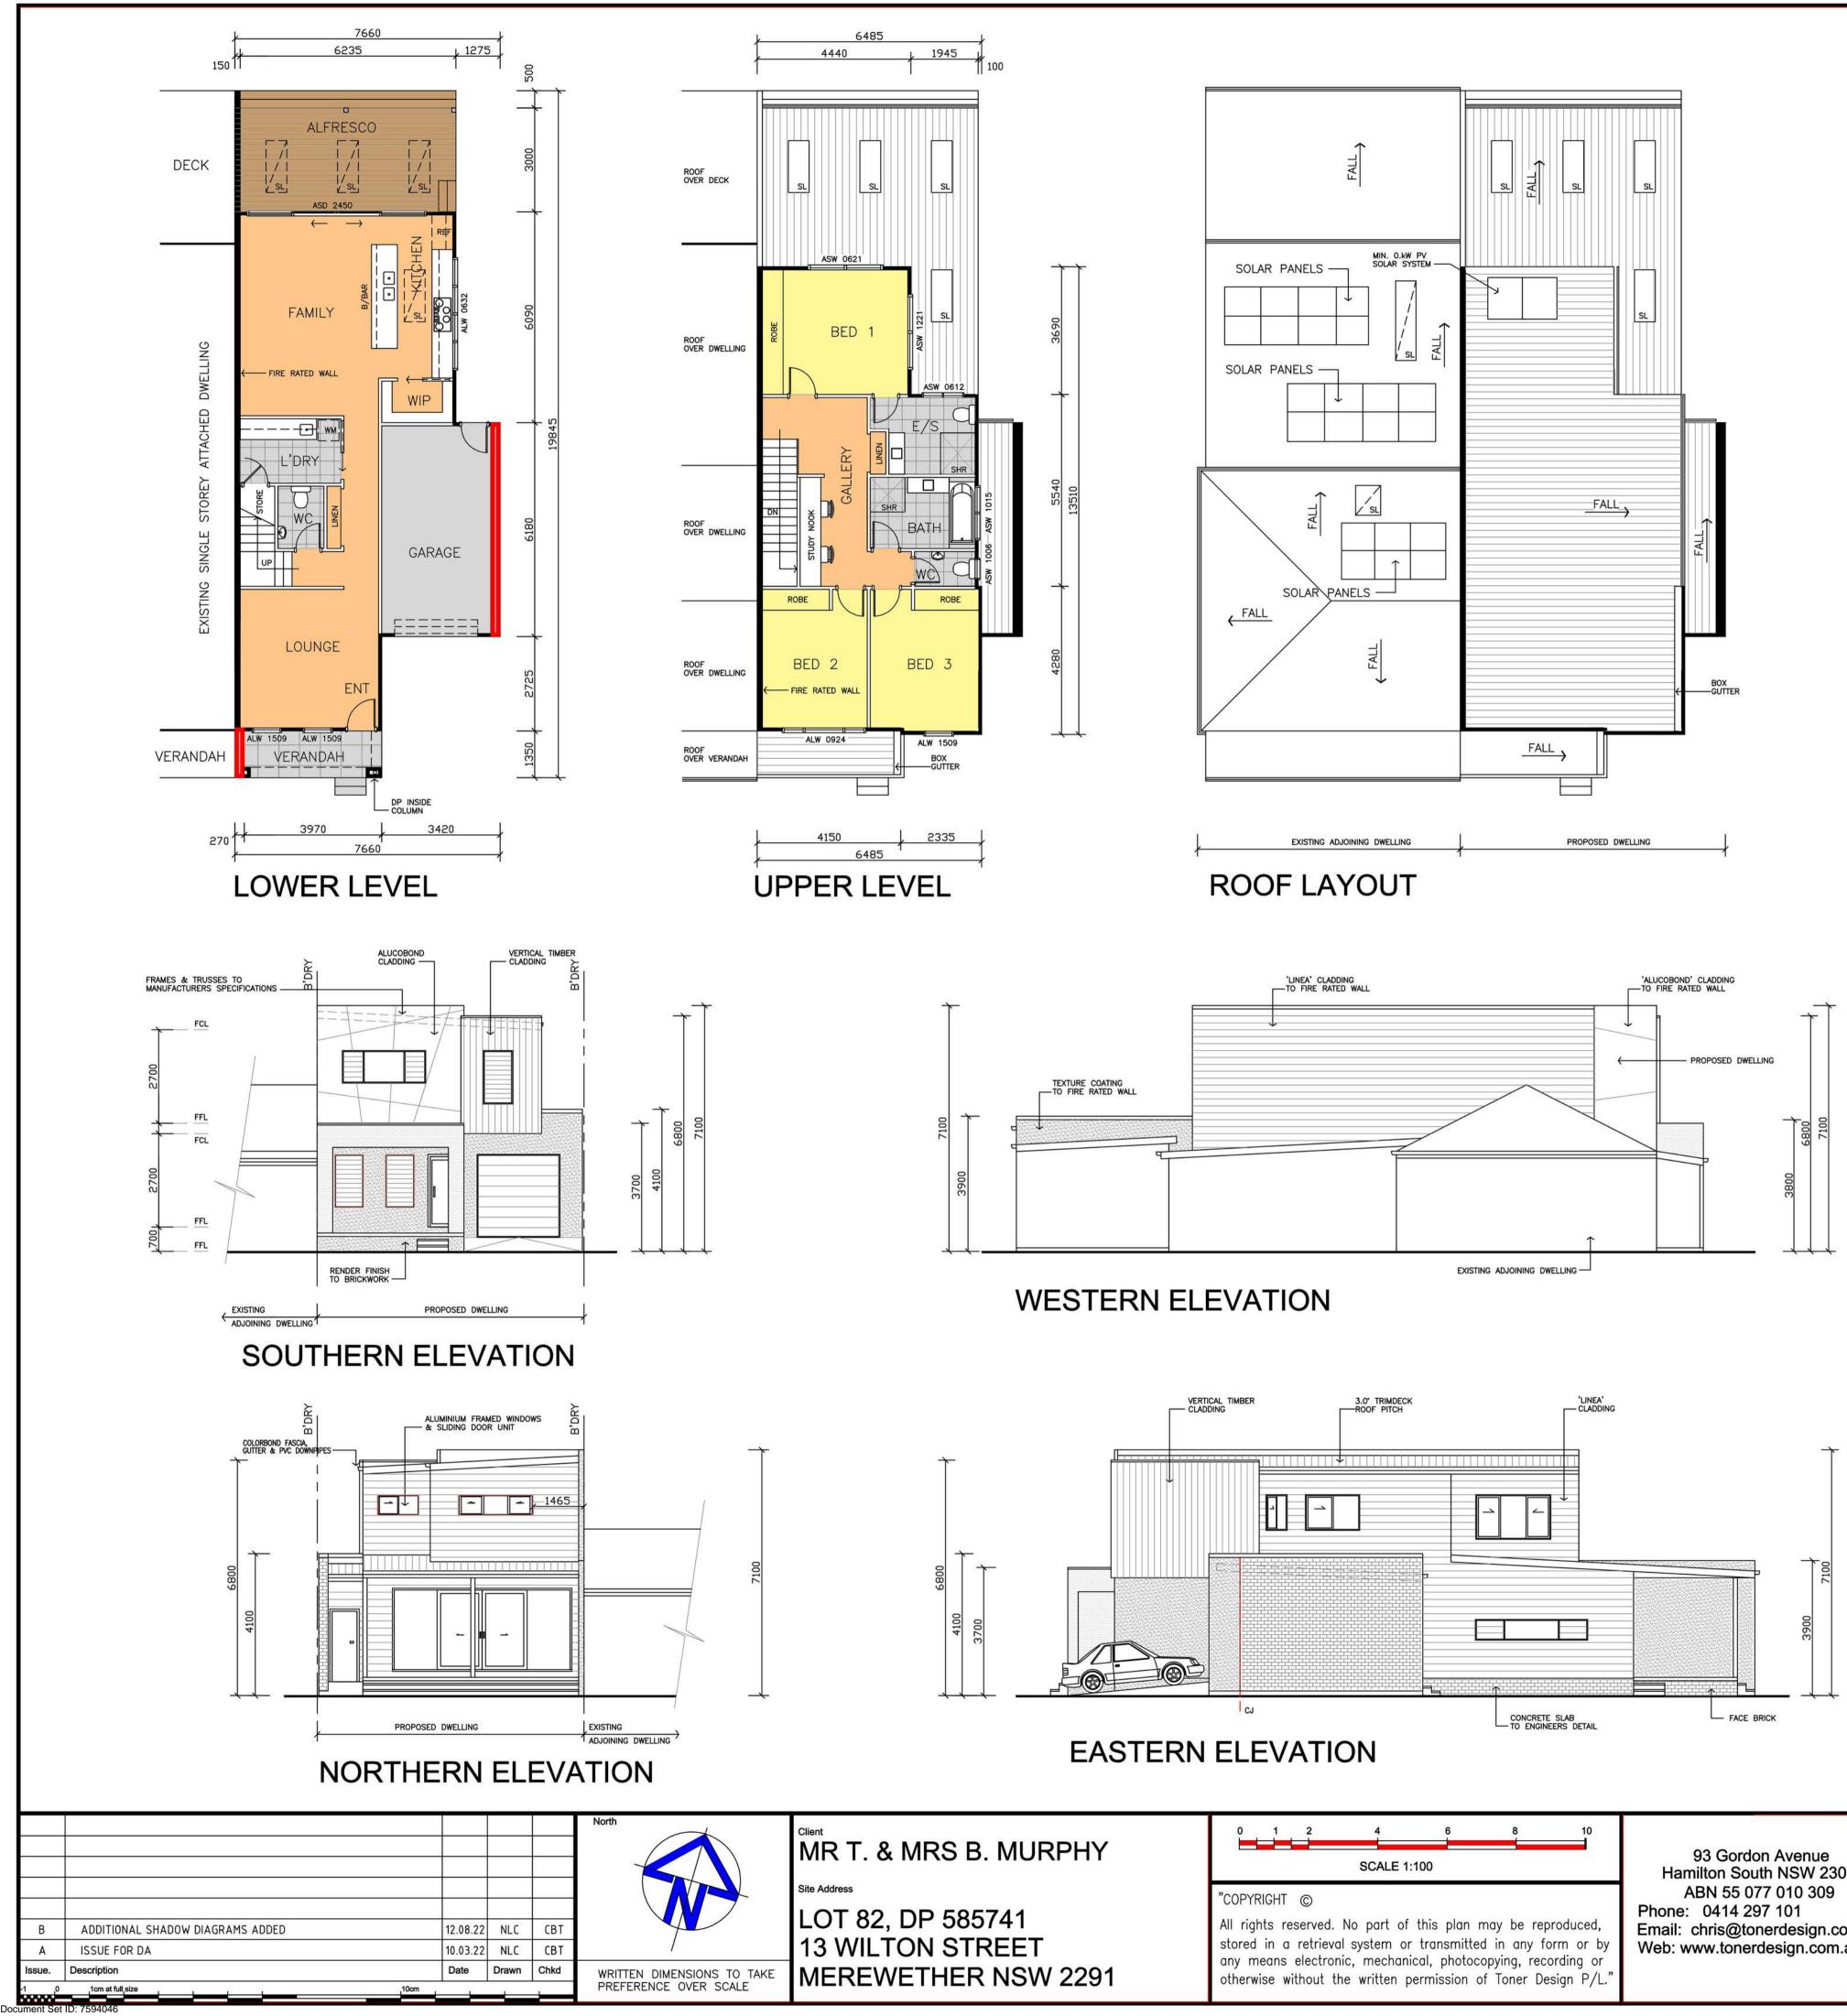
Version: 1, Version Date: 26/10/2022

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91	stored in a retrieval system or transmitted in any form or by any means electronic, mechanical, photocopying, recording or otherwise without the written permission of Toner Design P/L."

TONER	Drawing Title SITE ANA SITE PLA		PLAN/	
SITE PLAN				
WILTON STREET	BENCH MARK DRILL HOLE & WING IN KERB R.L.=10.98			
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11.21 11.21 11.21 11.21 GARDEN. 11.17 11.26 11.18	27 11.29 Ad			
14.08G	1.40 O 1.37		7 SECTION 7 DP 111240	
4000LTR WA CONNECTED WATER WASH			13.54G	
195118 1967018 19770 198701 197701			12.540	
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GARAC	E /		14.26G	
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PROPOSED RESIDENCE	343° 37' 30" 22.85	WS		
	11.36 1275			
"- 1.15 RL:14.928 11.36	11.28	Wa	16.26R	
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Drawn	Date	Scale A1	Checked	Date
NLC	10.08.2022	1:100	CBT 12.0	08.2022
Designed CBT	Project No.	22/032	Dwg. No. DA_01	lssue B

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Α


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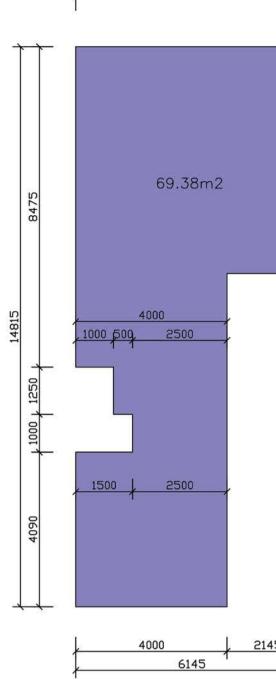
93 Gordon Avenue Hamilton South NSW 2303 Email: chris@tonerdesign.com.au Web: www.tonerdesign.com.au




FSR LOWER LEVEL


LOWER LEVEL UPPER LEVEL GARAGE: PATIO: ALFRESCO: TOTAL:



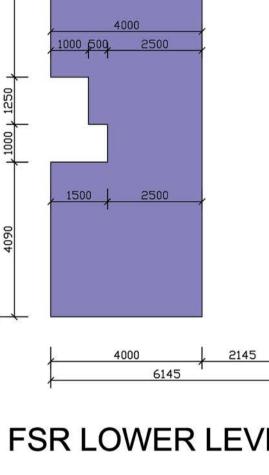

6145

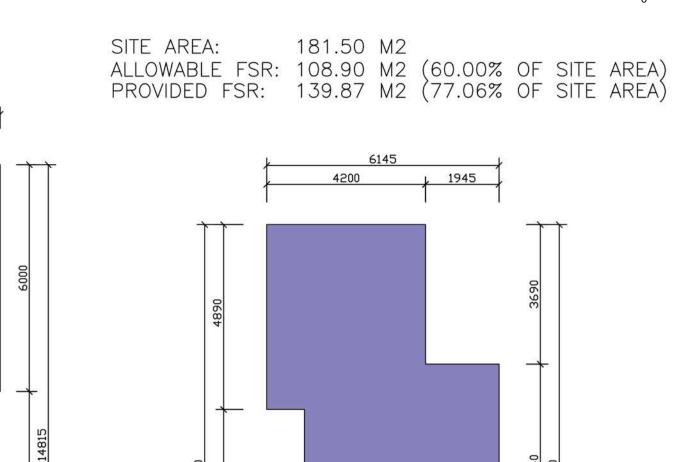

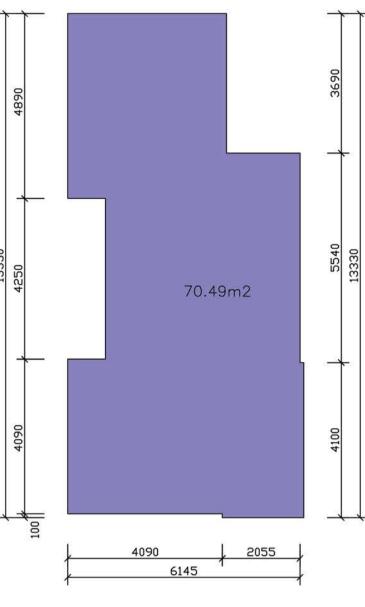

FSR UPPER LEVEL

EL:	76.83	M2
EL:	79.10	М2
	20.94	M2
	5.73	М2
	19.15	М2
	201.75	М2

Internal Wall Construction Added Insulation Plasterboard on studs R2.0 to walls adjacent to roofspace and gara Ceiling Construction Added Insulation Plasterboard R3.5 to ceilings adjacent to roof space Roof Construction Colour (Solar Absorptance) Metal Any Floor Construction Covering Added Insulation Concrete As drawn (if not noted default values used) Non Timber As drawn (if not noted default values used) Rimber As drawn (if not noted default values used) R2.0 to floors where open below Timber As drawn (if not noted default values used) R2.0 to floors adjacent to gara Windows Glass and frame type U value SHGC Range Area sq ALM-001-01 A Aluminium Type A Single clear 6.70 0.51 - 0.63 As draw	April 2022		BSA Ref	ference: 16972
The following specification was used to achieve the thermal performance values indicated of the Assessor Certificates. If the proposed construction varies to those detailed below than the Assessor and NatHERS certificates will no longer be valid. Assessments assume that the BCA provisions for building sealing & vertilation are complied with a construction. In NSW both BASIX & the BCA variations must be complied with, in particular the following: - Thermal construction in accordance with Vol 1 Section J1.2 or Vol 2 Part 3.12.1.1 - Thormal breaks for Class 1 dwellings in accordance with Part 3.12.1.5(g)(ii), (ii) & (e) or (c). (d) & (e) - Floor insulation for Class 1 dwellings as per Part 3.12.1.5(g)(ii), (iii) & (e) or (c). (d) & (e) - Building sealing in accordance with Section J3 or Part 3.12.3.1 to 3.12.3.6. Thermal Vall Construction Added Insulati Plasterboard on studs R2.0 to walls adjacent to roofspace and gara Ceiling Construction Added Insulati Plasterboard on studs R3.5 to ceilings adjacent to roof space Roof Construction Colour (Solar Absorptance) Added Insulati Metal Any Foil + R1.0 blank Floor Construction Covering Added Insulati Concrete As drawn (if not noted default values used) Nor Timber As drawn (if not noted default values used) R2.0 to floors where open beld <				
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Plasterboard R3.5 to cellings adjacent to roof spa Roof Construction Colour (Solar Absorptance) Added Insulati Metal Any Foil + R1.0 blank Floor Construction Covering Added Insulati Concrete As drawn (if not noted default values used) Non Timber As drawn (if not noted default values used) R2.0 to floors where open below Timber As drawn (if not noted default values used) R2.0 to floors adjacent to gara Windows Glass and frame type U value SHGC Range Area sq ALM-001-01 A Aluminium Type A Single clear 6.70 0.51 - 0.63 As draw Type A windows are awning windows, bifolds, casements, tilt 'n 'turn' windows, entry doors, french door Type A windows are double hung windows, sliding windows & doors, fixed windows, stacker doors, louv Skylights Glass and frame type U SHGC Area sq Detail Double glazed in aluminium frames 4.20 0.72 As drawn U U and SHGC values are according to AFRC. Alternate products may be used if the U value is lower & to SHGC is within the range specified Shade elements (eaves, verandahs, awnings of All shade elements	Plasterboard on studs	R2.0 to wa	lls adjacent to roofspa	ice and garage
Type B windows are double hung windows, sliding windows & doors, fixed windows, stacker doors, louv Skylights Glass and frame type U SHGC Area sq m Detail Double glazed in aluminium frames 4.20 0.72 As drawn U U SHGC slues are according to AFRC. Alternate products may be used if the U value is lower & to SHGC is within the range specified Shade elements (eaves, verandahs, awnings of All shade elements modelled as drawn	Plasterboard Roof Construction Colour (Solar Abs Metal Metal Any Floor Construction Covering Concrete As drawn (if not noted defaul Timber As drawn (if not noted defaul Timber As drawn (if not noted defaul Windows Glass and frame type ALM-001-01 A Aluminium Type A Single	sorptance) It values used It values used) It values used) <i>U value</i> clear 6.70	5.5 to ceilings adjacen Ad Foil R2.0 to floors whe R2.0 to floors adja SHGC Range 0.51 - 0.63	t to roof space ded Insulation + R1.0 blanket dded Insulation None re open below
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			(eaves, verandah	s, awnings etc)
Ceiling Penetrations (downlights, exhaust fans, flues e	All shade elements modelled as drawn			
	Ceiling Penetrations		(downlights, exhaust	fans, flues etc)
Modelled as drawn and/or to comply with the ventilation and sealing requirements of the BO				
Ducting is modelled at 150mm. No insulation losses from downlighting have been modelle Additional Notes	Ducting is modelled at 150mm. No insulati			

		13	Wilton St	reet Merew	vether			
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	fer to the C	URRE	NT BASIX		letailed in the for Complete sw.gov.au			nte.
WATER CO	MMITME	NTS						
Fixtures								
3 Star Showe			Yes					
3 Star Kitche		Taps	Yes		3 Star To	ilet	Yes	
Alternative W								
Minimum Tan			2000	Collected	from Roo	Are	a (m2)	30
Tank Connec	ted To:			1				
All Toilets		Yes		Laundr	y W/M Cold	d Tap	Yes	
One Outdoor	1. S.	Yes						
THERMAL CO	DMFORT	COMN	AITMENT	'S - Refer	to TPA Sp	ecifi	cation or	n plans
ENERGY CO	MMITMEN	TS						
Hot Water	Gas Insta	antane	ous 6 St	ar				
Cooling	Living		1 Phase	A/C Zoned			EER 3.	0 - 3.5
System	Bedrooi	ns	1 Phase	A/C Zoned			EER 3.	0 - 3.5
Heating	Living	Living 1 Phase A/C Zoned					EER 3.	0 - 3.5
System	Bedroor	ns	1 Phase	A/C Zoned	1		EER 3.	0 - 3.5
	1 x Bath	room	Fan duct	Fan ducted to exterior			Manual o	on/off
Ventilation	Kitchen		Fan ducted to exterior				Manual on/off	
	Laundry	1	Fan ducted to exterior				Manual on/off	
Natural	and the state of the second		ight in Kitchen			Yes		
Lighting	Window	/Skyli	ght in Ba	throoms/	Toilets	Y	es to	3
Artificial	Number	of bec	frooms		All	De	dicated	Yes
Lighting	Number	of Livi	ing/Dinin	g rooms	All	De	dicated	Yes
rooms to be	Kitchen				Yes	De	dicated	Yes
primarily lit by Juorescent or	All Bath	rms/T	oilets		Yes	De	dicated	Yes
LED lights)	Laundry				Yes	De	dicated	Yes
1977 - 19			Yes	De	dicated	Yes		
OTHER COM	MITMENT	S						
Outdoor cloth	es line		Yes	Ventilate	d refrigerat	or sp	bace	Yes
Stove/Oven		(Gas cooktop & electric oven					
Alternative Er	nergy Ph	otovolt	aic Syster	m: 0.2kW				


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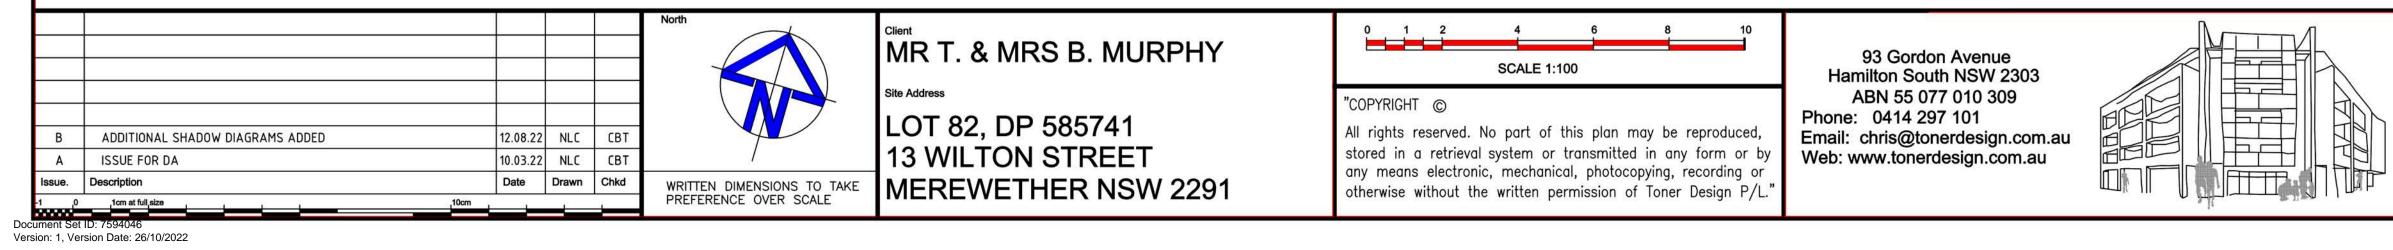
ISSUE FOR DA

FLOOR PLANS, ELEVATIONS & BASIX REQUIREMENTS

Drawn	Date	Scale A	Checked	Date
NLC	10.08.2022	1:100		12.08.2022
Designed	Project No.		Dwg. No.	Issue
CBT	TD_	22/032	DA	_02 B



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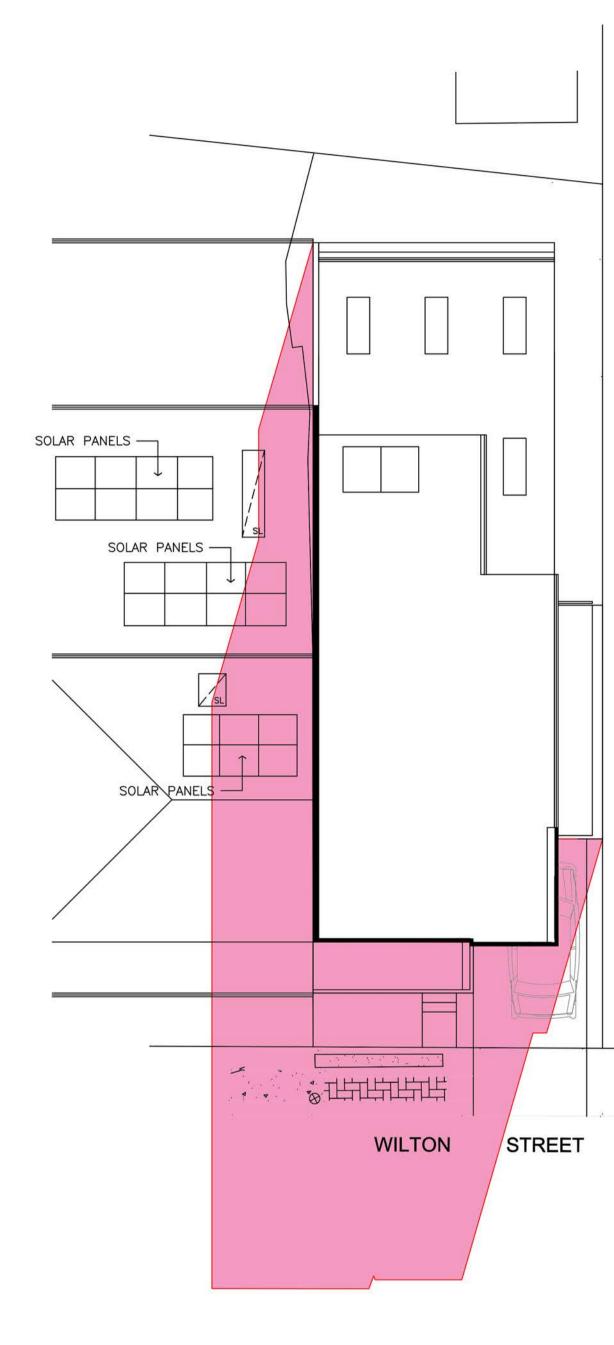

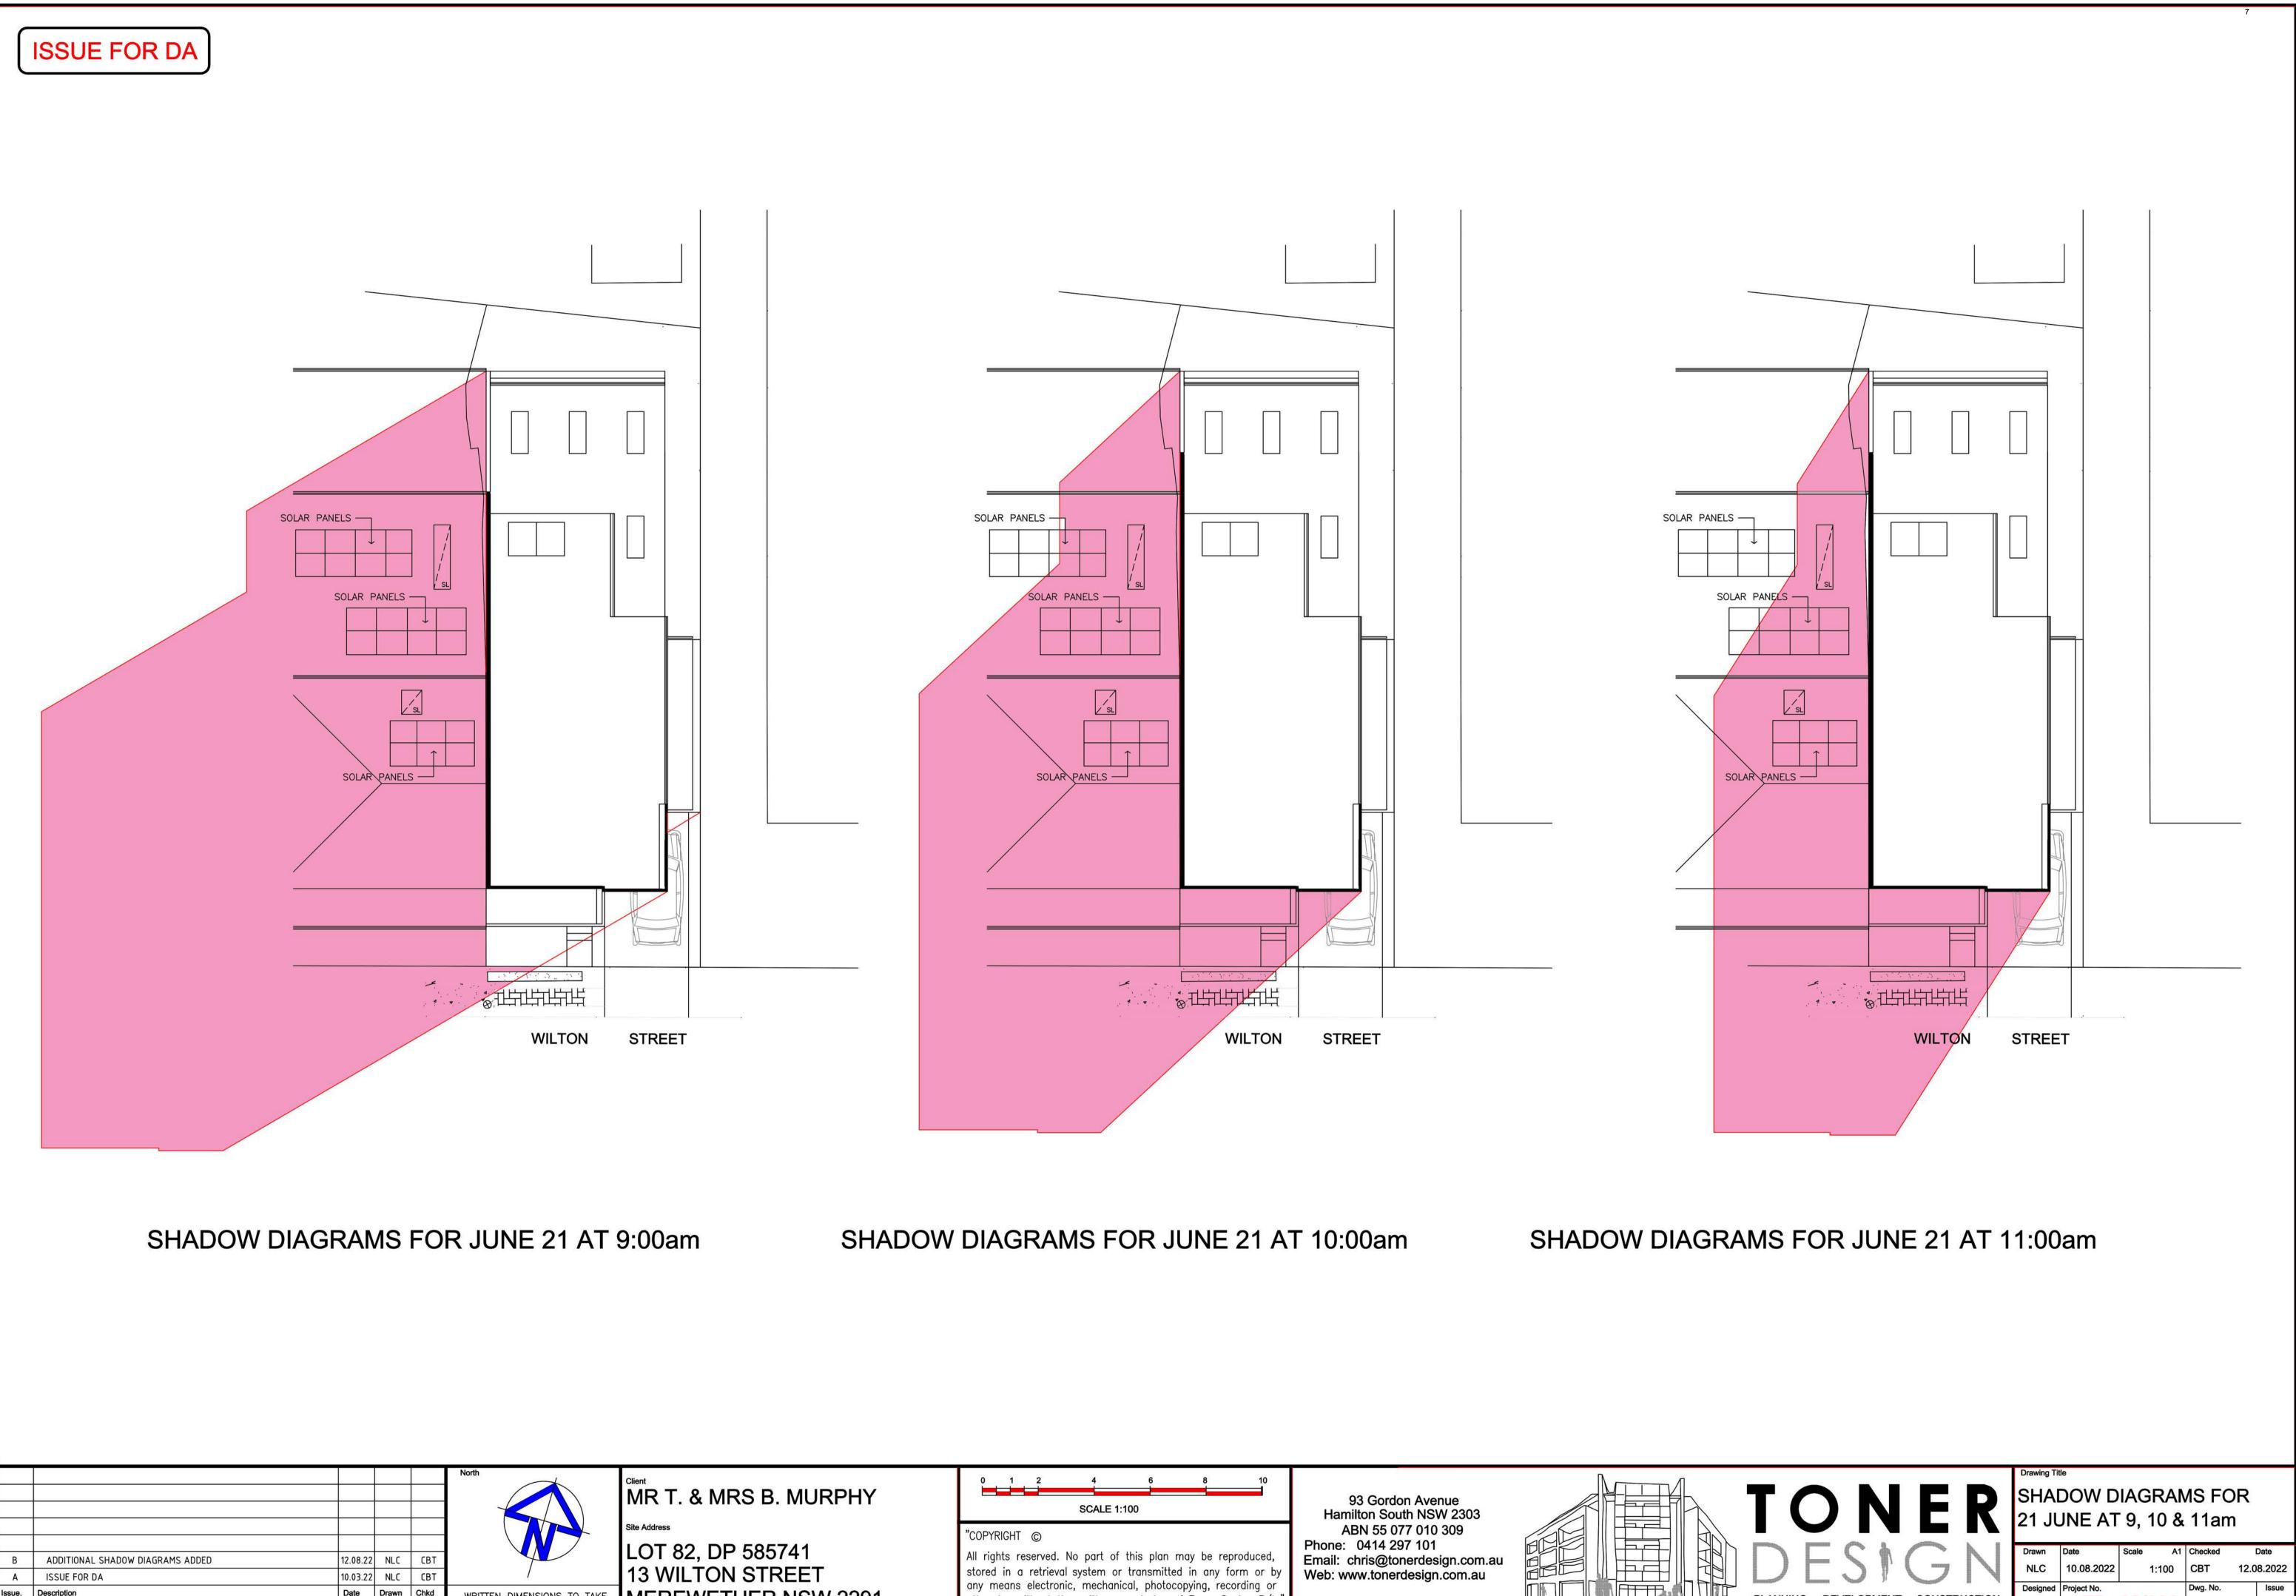
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TD_22/032 DA_03 B

СВТ






SHADOW DIAGRAMS FOR JUNE 21 AT 12:00pm

	ID: 7594046 sion Date: 26/10/2022					
1 0	1cm at full size	10cm			PREFERENCE OVER SCALE	
lssue.	Description	Date	Drawn	Chkd	WRITTEN DIMENSIONS TO TAKE	MEREWETHER NSW 22
Α	ISSUE FOR DA	10.03.22	NLC	CBT	/	13 WILTON STREET
В	ADDITIONAL SHADOW DIAGRAMS ADDED	12.08.22	NLC	CBT		LOT 82, DP 585741
						Site Address
						MR T. & MRS B. MURPH
					North	Client



SHADOW DIAGRAMS FOR JUNE 21

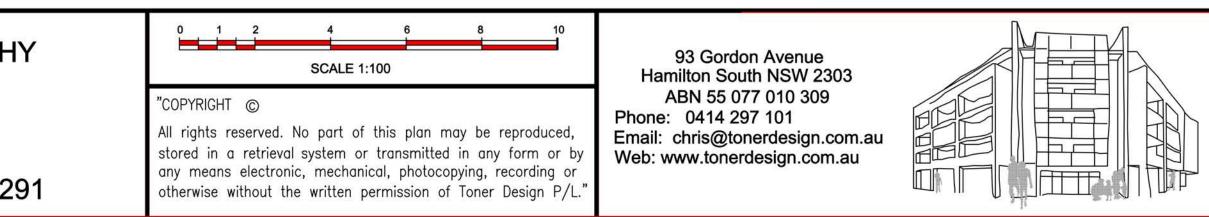

٨т	1	:00pm
AI		.00pm

Т	0		V	Ε	R
D		S		G	Ν
PLANN	NG • DE	VELOP	MENT	• CONSTR	RUCTION

SHADOW DIAGRAMS FOR 21 JUNE AT 12 & 1pm

Drawing Title


Drawn	Date	Scale	A1	Checked	I	Date
NLC	10.08.2022		1:100	СВТ	12.0	8.2022
Designed	Project No.			Dwg. No.		Issue
СВТ	TD	22/	032	DA_	04	В



SHADOW DIAGRAMS FOR JUNE 21 AT 2:00pm

					North	Client MR T. & MRS B. MURPH
						Site Address
19496				a a		LOT 82, DP 585741
В	ADDITIONAL SHADOW DIAGRAMS ADDED	12.08.22	NLC	CBT		
Α	ISSUE FOR DA	10.03.22	NLC	CBT	/	13 WILTON STREET
Issue.	Description	Date	Drawn	Chkd	WRITTEN DIMENSIONS TO TAKE	MEREWETHER NSW 229
-1 0	10cm		0	-	PREFERENCE OVER SCALE	

ISSUE FOR DA

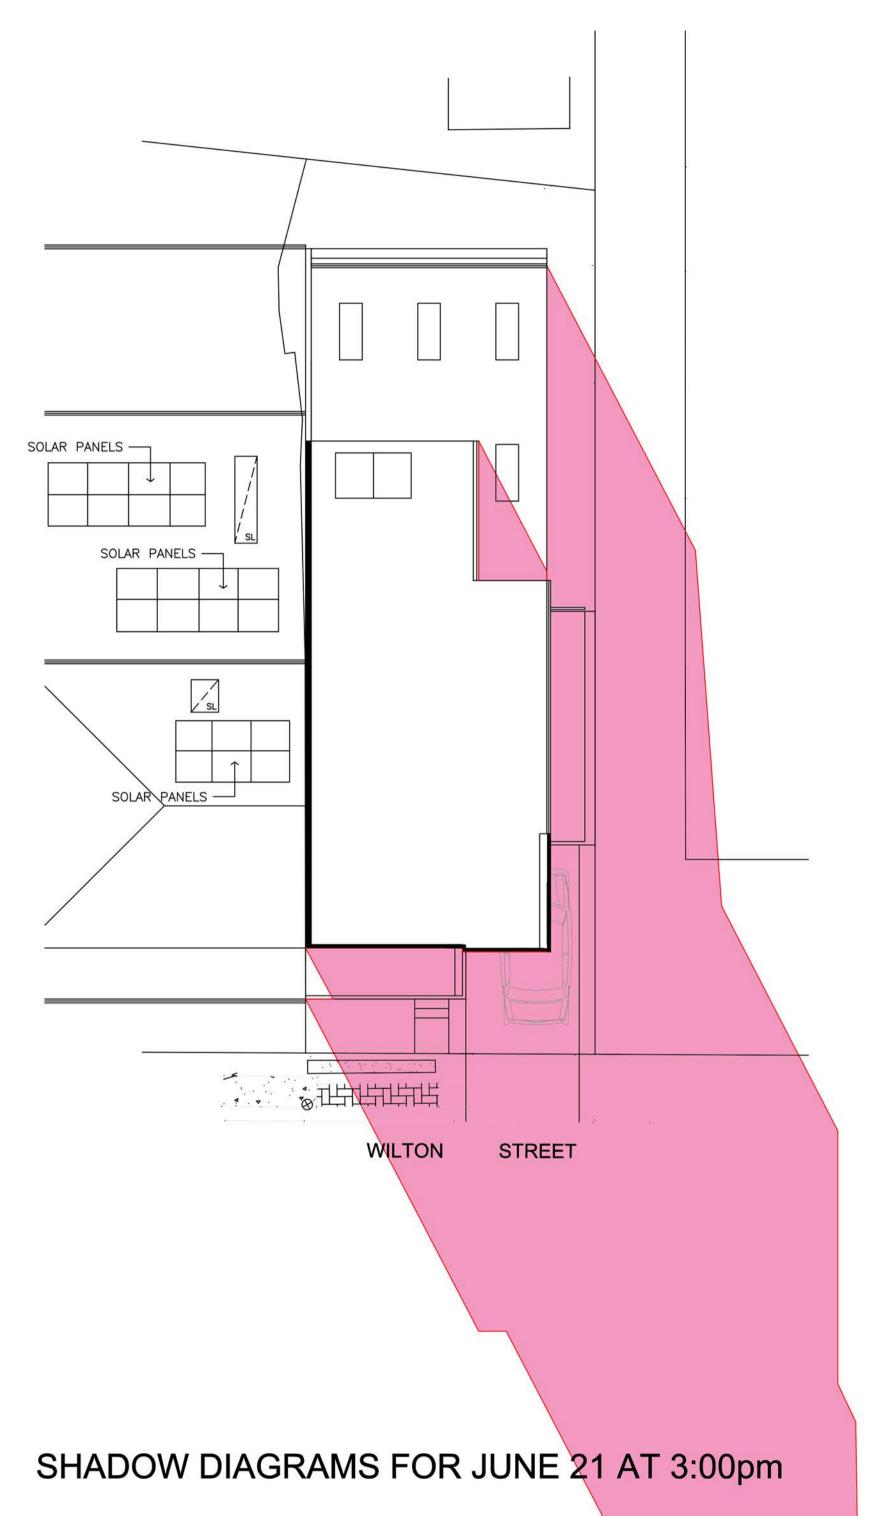

HY	0 1 2 4 6 8 10 SCALE 1:100	93 Gordon Avenue	
291	"COPYRIGHT © All rights reserved. No part of this plan may be reproduced, stored in a retrieval system or transmitted in any form or by any means electronic, mechanical, photocopying, recording or otherwise without the written permission of Toner Design P/L."	Hamilton South NSW 2303 ABN 55 077 010 309 Phone: 0414 297 101 Email: chris@tonerdesign.com.au Web: www.tonerdesign.com.au	DES*GN PLANNING • DEVELOPMENT • CONSTRUCTION

SHADOW DIAGRAMS FOR 21 JUNE AT 2 & 3pm

Drawing Title

Drawn	Date	Scale	A1	Checked	[Date
NLC	10.08.2022		1:100	CBT	12.0	8.2022
Designed CBT	Project No.	22/	032	Dwg. No.	05	lssue B

ATTACHMENTS DISTRIBUTED UNDER SEPARATE COVER

DAC 21/02/2023 – 13 WILTON STREET MEREWETHER – DA2022/00438 - SEMI-DETACHED DWELLING - INCLUDING DEMOLITION OF EXISTING STRUCTURES

ITEM-1 Attachment B: Draft Schedule of Conditions





Application No:	DA2022/00438
Land:	Lot 82 DP 585741
Property Address:	13 Wilton Street Merewether NSW 2291
Proposed Development:	Semi-detached dwelling - including demolition of existing structures

SCHEDULE 1

Approved Documentation

1. The development is to be implemented in accordance with the plans and supporting documents set out in the following table except where modified by any conditions of this consent.

Plan No / Supporting Document	Reference / Version	Prepared by	Dated
Site Analysis Plan / Site Plan	DA_01, Issue B	Toner Design	12/08/2022
Floor Plans, Elevations and Basix Requirements	DA_02, issue B	Toner Design	12/08/2022
BASIX Certificate	1191180S_02	Building Sustainability Assessments	19/04/2022

In the event of any inconsistency between conditions of this development consent and the plans/supporting documents referred to above, the conditions of this development consent prevail.

CONDITIONS TO BE SATISFIED PRIOR TO THE ISSUE OF A CONSTRUCTION CERTIFICATE

- 2. Roof water from the proposed new work is to be directed to the proposed water tank with a minimum capacity of 4000 litres and being reticulated to any new toilet cisterns and cold water washing machine taps, with a mains water top up being installed to maintain between 10% and 15% of the tank capacity. Alternatively, an electronically activated mechanical valve device is to be installed to switch any new toilet cisterns and laundry taps to mains water when the tank falls below 10% capacity. The water tank and plumbing is to be designed in accordance with the Plumbing Code of Australia (National Construction Code Volume 3). Full details are to be included in documentation for a Construction Certificate application.
- 3. The upper floor level window openings on the northern elevation are to be amended to highlight window openings with a minimum window sill height of 1.5m measured from the finished floor level. Full details are to be included in documentation for a Construction Certificate application.
- 4. The proposed colours and finishes to the boundary wall along the western elevation of the second floor are to be treatment of Linea Cladding and/or Alucobond Cladding in a grey colour palette. Full details are to be included in documentation for a Construction Certificate application.

- 5. Overflows from the roof water tank and any additional discharge controls (if required) are to be directed to City of Newcastle's drainage system by means of an underground pipe directly to the street gutter. Details are to be included in documentation for a Construction Certificate application.
- 6. Consent is not given to undertake works to the party wall. The proposed structures are to be independently supported and a certificate from a qualified and practising Structural Engineer is to be obtained, confirming that the proposed works are able to be supported independently of the party wall, and must be submitted to the Certifying Authority for approval prior to the issue of any Construction Certificate.

The required structural engineers certificate is to state that the design is independently supported and does not rely on the party wall for lateral or vertical support. It is not sufficient for a Structural Engineer to state that the works will impose no additional load on the party wall.

7. A report / certificate from an appropriately qualified and practising structural engineer, certifying the structural adequacy of the adjoining property at No. 15 Wilton Street, Merewether, which certifies ability to withstand the proposed works and outlines any measures required to be implemented to ensure that no damage will occur to adjoining premises during the course of the works, must be submitted to the Certifying Authority for approval prior to the issue of any Construction Certificate. The measures outlined in the certified report must be complied with at all times.

Under no circumstances shall the party or common wall be extended or altered without the prior written consent of the adjoining owner. Any such extension of the party wall shall be noted on title by way of appropriate easement or Section 88B instrument.

- 8. The floor level of all proposed buildings or building additions is to be verified on plans for a Construction Certificate application to be 12.1m AHD dwelling floor levels, 11.8m AHD garage floor level Australian Height Datum.
- 9. The second storey of the proposed building is to be a flood refuge in a Probable Maximum Flood event and is to be structurally certified by a professional engineer, ensuring that the building is able to withstand the hydraulic loading due to flooding from the Probable Maximum Flood (Flood Level reduced level 12.1m Australian Height Datum, Maximum Flow Velocity of floodwaters 1.5m/s). Full details are to be included in documentation for a Construction Certificate application.

CONDITIONS TO BE SATISFIED PRIOR TO THE COMMENCEMENT OF WORK AND DURING THE CONSTRUCTION PHASE

- 10. Certification is to be prepared by a Registered Surveyor and submitted to the Principal Certifier at the stages of construction indicated:
 - a) Prior to works commencing, delineating the location of the party wall.
 - b) On completion of ground floor construction, confirming that the floor levels are in accordance with the approved levels.
- 11. Toilet facilities are to be available or provided at the work site before works begin and be maintained until the works are completed, at a ratio of one toilet plus one additional toilet for every 20 persons employed at the site.

Each toilet is to:

- a) Be a standard flushing toilet connected to a public sewer, or
- b) Have an on-site effluent disposal system approved under the *Local Government Act 1993*, or

- c) Be a temporary chemical closet approved under the *Local Government Act 1993*.
- 12. The demolition works are to be undertaken in accordance with Australian Standard 2601:2001 The Demolition of Structures and the following requirements:
 - a) prior to commencement of demolition works a competent person shall determine the presence of hazardous substances impacted by the proposed demolition works in accordance with Section 1.6.1 of AS2601:2001 and where required produce a Hazardous Substances Management Plan
 - b) demolition works shall be conducted in accordance with any required Hazardous Substances Management Plan. A copy of the Plan shall be kept on-site for the duration of the proposed development and a copy is to be held in the possession of the landowner
 - c) the removal, handling and disposal of any asbestos material is to be undertaken only by an asbestos removal contractor who holds the appropriate class of Asbestos Licence, issued by the WorkCover Authority of NSW
 - d) a copy of all waste disposal receipts are to be kept in the possession of the landowner and made available to authorised Council Officers upon request
 - e) seven working days notice in writing is to be given to the owners/occupiers of neighbouring premises prior to the commencement of any demolition works. Such written notice is to include the date demolition will commence and details of the name, address, contact telephone number(s) and licence details (type of licences held and licence numbers) of any asbestos removal contractor and demolition contractor, and
 - f) on sites where asbestos materials are to be removed, a standard commercially manufactured sign containing the words 'DANGER ASBESTOS REMOVAL IN PROGRESS' measuring not less than 400mm x 300mm is to be erected in a prominent position during asbestos removal works.
- 13. The demolisher is to ensure that all services (ie water, telecommunications, gas, electricity, sewerage etc), are disconnected in accordance with the relevant authority's requirements prior to demolition.
- 14. Any waste containers used in association with the proposed demolition are to be located on the site where possible.

Note: Where this is not feasible, an application is to be made for the approval to position the container on the adjacent public road in accordance with the Council's adopted Building Waste Container Policy.

15. All demolition material incapable of being re-used in future redevelopment of the site is to be removed from the site and the site being cleared and levelled.

Note: Where reusable building materials are to be stored on site for use in future building works, such materials are to be neatly stacked at least 150 mm above the ground.

- 16. The demolisher is to ensure that all demolition material is kept clear of the public footway and carriageway as well as adjoining premises.
- 17. Any demolition/waste building materials that are not suitable for recycling are to be disposed of at City of Newcastle's Summerhill Waste Management Facility or other approved site.
- 18. A rigid and durable sign is to be erected in a prominent position on any site on which

- a) showing the name, address and telephone number of the Principal Certifier for building work and subdivision work, and
- b) showing the name, address and telephone number of the Principal Contractor, if any, for any building work and a telephone number on which the Principal Contractor may be contacted at any time for business purposes, and
- c) stating that unauthorised entry to the work site is prohibited, and
- d) being erected in a prominent position that can be read easily by anyone in any public road or other public place adjacent to the site.

Any such sign is to be maintained while the building work, subdivision work or demolition work is being carried out, and must be removed when the work has been completed.

Note: This does not apply in relation to building work, subdivision work or demolition work carried out inside an existing building, if the work does not affect the external walls of the building, or Crown building work certified to comply with the Building Code of Australia under the Act, Part 6.

- 19. Building work must be carried out in accordance with the requirements of the Building Code of Australia.
- 20. In the case of residential building work for which the Home Building Act 1989 requires there to be a contract of insurance in force in accordance with Part 6 of that Act, that such a contract of insurance is in force before any building work authorised to be carried out by the consent commences.
- 21. All excavations and backfilling are to be executed safely and excavations are to be properly guarded and protected to prevent them from being dangerous to life and property.
- 22. If the soil conditions require it, retaining walls associated with the erection or demolition of a building or other approved methods of preventing movement of the soil are to be provided.
- 23. All building materials, plant and equipment is to be placed on the site of the development, to ensure that pedestrian and vehicular access in public places is not restricted and to prevent damage to the road reserve. The storage of building materials on Council reserves, including the road reserve, is not permitted.
- 24. A residential vehicular crossing is to be constructed across the road reserve, in accordance with the following criteria:
 - a) Constructed in accordance with City of Newcastle's A1300 Driveway Crossings Standard Design Details.
 - b) In the case of a single car garage/parking space, the driveway crossing, within the road reserve, is to be a maximum of 3.0m wide.
 - c) Letterboxes, landscaping and any other obstructions to visibility are to be kept clear of or limited in height to 1.2m, in the 2.0m by 2.5m splay within the property boundary, each side of the driveway entrance.
 - d) The proposed driveway is to be a minimum of 3.0m clear of the trunk of any tree within the road reserve.
 - e) The proposed driveway is to be a minimum of 750mm clear of the centre of any pole or obstruction within the road reserve and 1.0m clear of any drainage pit.

These works are not approved until consent under Section 138 of the Roads Act 1993

has been granted by the City of Newcastle.

- 25. A separate application is to be lodged and consent obtained from the City of Newcastle for all works within the road reserve, pursuant to Section 138 of the *Roads Act 1993*, prior to the commencement of works.
- 26. Any alteration to natural surface levels on the site is to be undertaken in such a manner as to ensure that there is no increase in surface water runoff to adjoining properties or that runoff is impounded on adjoining properties, as a result of the development.
- 27. Construction/demolition work that generates noise that is audible at residential premises is to be restricted to the following times:
 - Monday to Friday, 7:00 am to 6:00 pm and
 - Saturday, 8:00 am to 1:00 pm.

No noise from construction/demolition work is to be generated on Sundays or public holidays.

28. Council's '*Prevent Pollution*' sign is to be erected and maintained in a conspicuous location on or adjacent to the property boundary, so it is clearly visible to the public, or at other locations on the site as otherwise directed by Council, for the duration of demolition and construction work.

The sign can be obtained by presenting your development application receipt at City of Newcastle's Customer Enquiry Centre, Wallsend Library or the Master Builders Association Newcastle.

- 29. Erosion and sediment control measures are to be implemented prior to the commencement of works and maintained during the period of demolition and/or construction in accordance with the requirements of Managing Urban Stormwater: Soils and Construction 4th Edition Vol. 1 (the 'Blue Book') published by Landcom, 2004. Controls are not to be removed until the site is stable with all bare areas supporting an established vegetative cover.
- 30. Where the proposed development involves the destruction or disturbance of any survey monuments, those monuments affected are to be relocated, at no cost to the City of Newcastle, by a Surveyor registered under the *Surveying and Spatial Information Act 2002*.
- 31. All public trees that are required to be retained are to be protected in accordance with the City of Newcastle *Urban Forest Technical Manual*, Part B *Public Trees*.

The tree protection fencing is to remain in place and be maintained until all works have been completed, with no waste materials, washouts, equipment or machinery to be stored within the fenced area.

- 32. The following waste management measures are to be implemented during construction:
 - a) waste container of at least one cubic metre capacity shall be provided, maintained and regularly serviced from the commencement of operations until the completion of the building for the reception and storage of waste generated by the construction of the building and associated waste
 - b) the waste container is to be, at minimum, constructed with a 'star' picket (corners) and weed control mat (sides), or equivalent. The matting is to be securely tied to the pickets
 - c) appropriate provision is to be made to prevent wind blown rubbish leaving the site

and

d) footpaths, road reserves and public reserves are to be maintained clear of rubbish, building materials and all other items.

Note: Fines may be issued for pollution/littering offences under the *Protection of the Environment Operations Act 1997* (NSW)

CONDITIONS TO BE SATISFIED PRIOR TO THE ISSUE OF AN OCCUPATION CERTIFICATE, A SUBDIVISION CERTIFICATE OR A STRATA CERTIFICATE

- 33. All commitments listed in the relevant BASIX certificate for the development are to be satisfactorily completed prior to the issue of an Occupation Certificate. Should there be any changes to the specifications of the dwelling that have implications for compliance with the approved certificate, except where restricted or excluded by any other condition of consent, an amended BASIX Certificate can be relied upon as having complied with this condition. A copy of any amended BASIX Certificate is to be provided to the City of Newcastle with Occupation Certificate documentation
- 34. All public footways, footpaving, kerbs, gutters and road pavement damaged during the works are to be immediately repaired following the damage, to a condition that provides for safe use by pedestrians and vehicles. Full restoration of the damage is to be carried out to City of Newcastle's satisfaction prior to the completion of demolition work or prior to the issue of any Occupation Certificate in respect of development involving building work.
- 35. All works within the road reserve required by this consent are to be completed prior to the issue of an Occupation Certificate.
- 36. The premises are to be identified by the provision of house numbers on the building exterior and mailbox such that they are clearly visible from the road frontage.

The minimum numeral height is to be 75mm.

ADVISORY MATTERS

- It is recommended that, prior to commencement of work, the free national community service 'Dial before you Dig' be contacted on 1100 or by fax on 1200 652 077 regarding the location of underground services in order to prevent injury, personal liability and even death. Inquiries should provide the property details and the nearest cross street/road.
- Any necessary alterations to public utility installations are to be at the developer/demolisher's expense and to the requirements of the City of Newcastle and any other relevant authorities. City of Newcastle and other service authorities should be contacted for specific requirements prior to the commencement of any works.
- Any approval for fences on side boundaries, common to other private properties, is independent of any consent or agreement which may be required from any adjoining owner under the provisions of the *Dividing Fences Act 1991*.
- Prior to commencing any building works, the following provisions of Division 6.2 of the Environmental Planning and Assessment Act 1979 are to be complied with:
 - a) A Construction Certificate is to be obtained; and
 - b) A Principal Certifier is to be appointed for the building works and Newcastle City Council is to be notified of the appointment; and

- c) Newcastle City Council is to be given at least two days notice of the date intended for commencement of building works.
- Prior to the occupation or use of a new building, or occupation or use of an altered portion of, or an extension to an existing building, an Occupation Certificate is to be obtained from the Principal Certifier appointed for the proposed development. An application for an Occupation Certificate must contain the information set out in Section 37 of the *Environmental Planning and Assessment (Development Certification and Fire Safety) Regulation 2021* (NSW).
- It is an offence under the provisions of the *Protection of the Environment Operations Act* 1997 to act in a manner causing, or likely to cause, harm to the environment. Anyone allowing material to enter a waterway or leaving material where it can be washed off-site may be subject to a penalty infringement notice (ie 'on-the-spot fine') or prosecution.
- Failure to comply with the conditions of consent constitutes a breach of the *Environmental Planning and Assessment Act 1979*, which may be subject to a penalty infringement notice (ie '*on-the-spot fine*') or prosecution.
- For the purpose of applying the provisions of the National Construction Code for class 1, 2, 3, 4, 9a (health care) and 9c (aged care) buildings, it is advised that the proposed building is located in a Flood Hazard Area and the:
 - a) Defined Flood Level (DFL) is 11.8m Australian Height Datum (AHD)
 - b) Flood Hazard Level is 12.1m AHD (Freeboard is 300mm above DFL)
 - c) Maximum Flow Velocity of floodwaters for the Defined Flood Event is 1.5m/s
- A person who is aware or believes that he or she has discovered or located a relic not identified and considered in the supporting documents for this approval, in any circumstances (including where works are carried out in reliance on an exception under section 139(4)), excavation or disturbance must cease in the affected area(s) and the Heritage Council must be notified in accordance with section 146 of the *Heritage Act* 1977. Depending on the nature of the discovery, additional assessment and approval under the *Heritage Act* 1977 may be required prior to the recommencement of excavation in the affected area(s).

Note: Heritage NSW can be contacted on 02 9873 8500 or

heritagemailbox@environment.nsw.gov.au. A 'relic' is any deposit, object or material evidence that relates to the settlement of New South Wales, not being Aboriginal settlement, and is of State or local significance. It is an offence under the provisions of the *Heritage Act 1977 (NSW)* for a person to disturb or excavate any land upon which the person has discovered a relic except in accordance with a gazetted exception or an excavation permit issued by the Heritage Council of NSW.

If any Aboriginal objects are discovered which are not covered by a valid Aboriginal Heritage Impact Permit, excavation or disturbance of the area is to stop immediately and Heritage NSW is to be notified in accordance with section 89A of the *National Parks and Wildlife Act 1974* (NPW Act). Depending on the nature of the discovery, additional assessment and approval under the NPW Act may be required prior to works continuing in the affected area(s). Aboriginal objects in NSW are protected under the NPW Act. Unless the objects are subject to a valid Aboriginal Heritage Impact Permit, work must not recommence until approval to do so has been provided by Heritage NSW.

Note: Heritage NSW can be contacted on 02 9873 8500 or

heritagemailbox@environment.nsw.gov.au. An 'Aboriginal object' is any deposit, object or other material evidence (not being a handicraft made for sale) relating to the Aboriginal habitation of an area of New South Wales, being habitation before or concurrent with (or both) the occupation of that area by persons of non-Aboriginal extraction, and includes Aboriginal remains. It is an offence under the provisions of the *National Parks and Wildlife Act 1974* (NPW Act) for a person to harm or desecrate an Aboriginal object, with defence from prosecution and certain activities exempt as prescribed under the NPW Act.

END OF CONDITIONS

SCHEDULE 2

REASONS FOR THE DETERMINATION & CONSIDERATION OF COMMUNITY VIEWS The determination decision was reached for the following reasons:

- The proposed development, subject to the recommended conditions, is consistent with the objectives of the applicable environmental planning instruments, being; *Newcastle Local Environmental Plan 2012* (NLEP) and applicable State Environmental Planning Policies.
- The proposed development is, subject to the recommended conditions, consistent with the objectives of the Newcastle Development Control Plan 2012 (NDCP).
- The proposed development is considered to be of an appropriate scale and form for the site and the character of the locality.
- The proposed development has appropriate management and mitigation of impacts through conditions of consent.
- The proposed development, subject to the recommended conditions, will not result in unacceptable adverse impacts upon the natural or built environments.
- The proposed development is a suitable and planned use of the site and its approval is within the public interest.
- The City of Newcastle has considered and accepted the proposed development standard variation made under Clause 4.4 of the *Newcastle Local Environmental Plan 2012*. The proposed 28% variation is considered acceptable in the particular circumstances of this case as the variation will not significantly obstruct significant view corridors and not result in negative privacy issues.
- Any issues raised in submission have been taken into account in the assessment report and where appropriate conditions of consent have been included in the determination.

REASONS WHY THE CONDITIONS HAVE BEEN IMPOSED

The following conditions are applied to:

- Confirm and clarify the terms of Council's determination;
- Identify modifications and additional requirements that will result in improved compliance, development and environmental outcomes;
- Prevent, minimise, and/or offset adverse environmental impacts including economic and social impacts;
- Set standards and measures for acceptable environmental performance; and
- Provide for the ongoing management of the development.

ATTACHMENTS DISTRIBUTED UNDER SEPARATE COVER

DAC 21/02/2023 – 13 WILTON STREET MEREWETHER – DA2022/00438 - SEMI-DETACHED DWELLING - INCLUDING DEMOLITION OF EXISTING STRUCTURES

ITEM-1 Attachment C: Processing Chronology



DISTRIBUTED UNDER SEPARATE COVER



PROCESSING CHRONOLOGY

DA2022/00438 – 13 Wilton Street Merewether

28 April 2022	-	Application lodged
4 May 2022	-	Application notified in accordance with CN's Community Participation Plan (CPP)
4 August 2022	-	Request for additional information
29 November 2022	-	Follow up Request for additional information
14 December 2022	-	Additional information received