

#### ATTACHMENTS DISTRIBUTED UNDER SEPARATE COVER

#### ITEM- 1 DA2019/01146 - 106 GOSFORD ROAD ADAMSTOWN

Multi dwelling housing – demolition of dwellings and outbuildings, erection 12 attached units and 12 lot strata subdivision

Attachment A: Submitted Plans

Attachment B: Processing Chronology

#### ITEM- 2 DA2019/01255 - 25 LLEWELLYN STREET MEREWETHER

Veterinary Hospital - change of use from a commercial premise

Attachment A: Submitted Plans

**Attachment B:** Processing Chronology

#### ITEM- 3 DA2019/00603 - 26 SMITH STREET HAMILTON SOUTH

Dwelling house - alterations and additions and ancillary structure

Attachment A: Submitted Plans

**Attachment B:** Processing Chronology



### ATTACHMENTS DISTRIBUTED UNDER SEPARATE COVER

ITEM 1 DA2019/01146 - 106 GOSFORD ROAD ADAMSTOWN

Multi dwelling housing – demolition of dwellings and outbuildings, erection 12 attached units and 12 lot strata subdivision

**Attachment A - Submitted Plans** 

**Attachment B** - Processing Chronology

## PUBLIC VOICE COMMITTEE MEETING

#### 17 MARCH 2020

#### PV 17/03/2020

#### DA2019/01146 - 106 GOSFORD ROAD ADAMSTOWN

**Attachment A: Submitted Plans** 



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# The Plan Centre of Newcastle

(02) 4952 7500 153 Lambton Road

www.plancentre.com.au Broadmeadow NSW 2292 mail@plancentre.com.au

The Plan Centre is a member of

BUILDING DESIGNERS

SITE AREA = 1678.3 SqM

Proposed Floor Space Ratio = 0.84 : 1 Ground First Second Floor Floor Total 1 - 3 Bed - 3 Storey 24.9 51.2 48.3 124.4 2 - 3 Bed - 3 Storey 24.9 51.2 48.3 124.4 3 - 3 Bed - 3 Storey 24.9 51.2 48.3 124.4 4 - 3 Bed - 3 Storey 24.9 51.0 48.5 124.4 5 - 3 Bed - 3 Storey 24.9 51.0 48.3 6 - 3 Bed - 2 Storey 47.9 58.6 7 - 3 Bed - 3 Storey 25.1 63.5 32.7 8 - 3 Bed - 3 Storey 25.7 60.4 30.8

= 1.5 : 1

Total Floor Space Area = 1,400.6 SqM

Multi Dwelling

**LOCATION:** 

106 & 108 Gosford Rd, Adamstown Lot 1943 DP.755247 DP.333722


CLIENT: JOB No: Macquarie Edge Pty Ltd | 12131

DRAWING: Site Plans

A01 of 7 1:200 1:500 DA 1

STAGE: ISSUE:

the plan centre

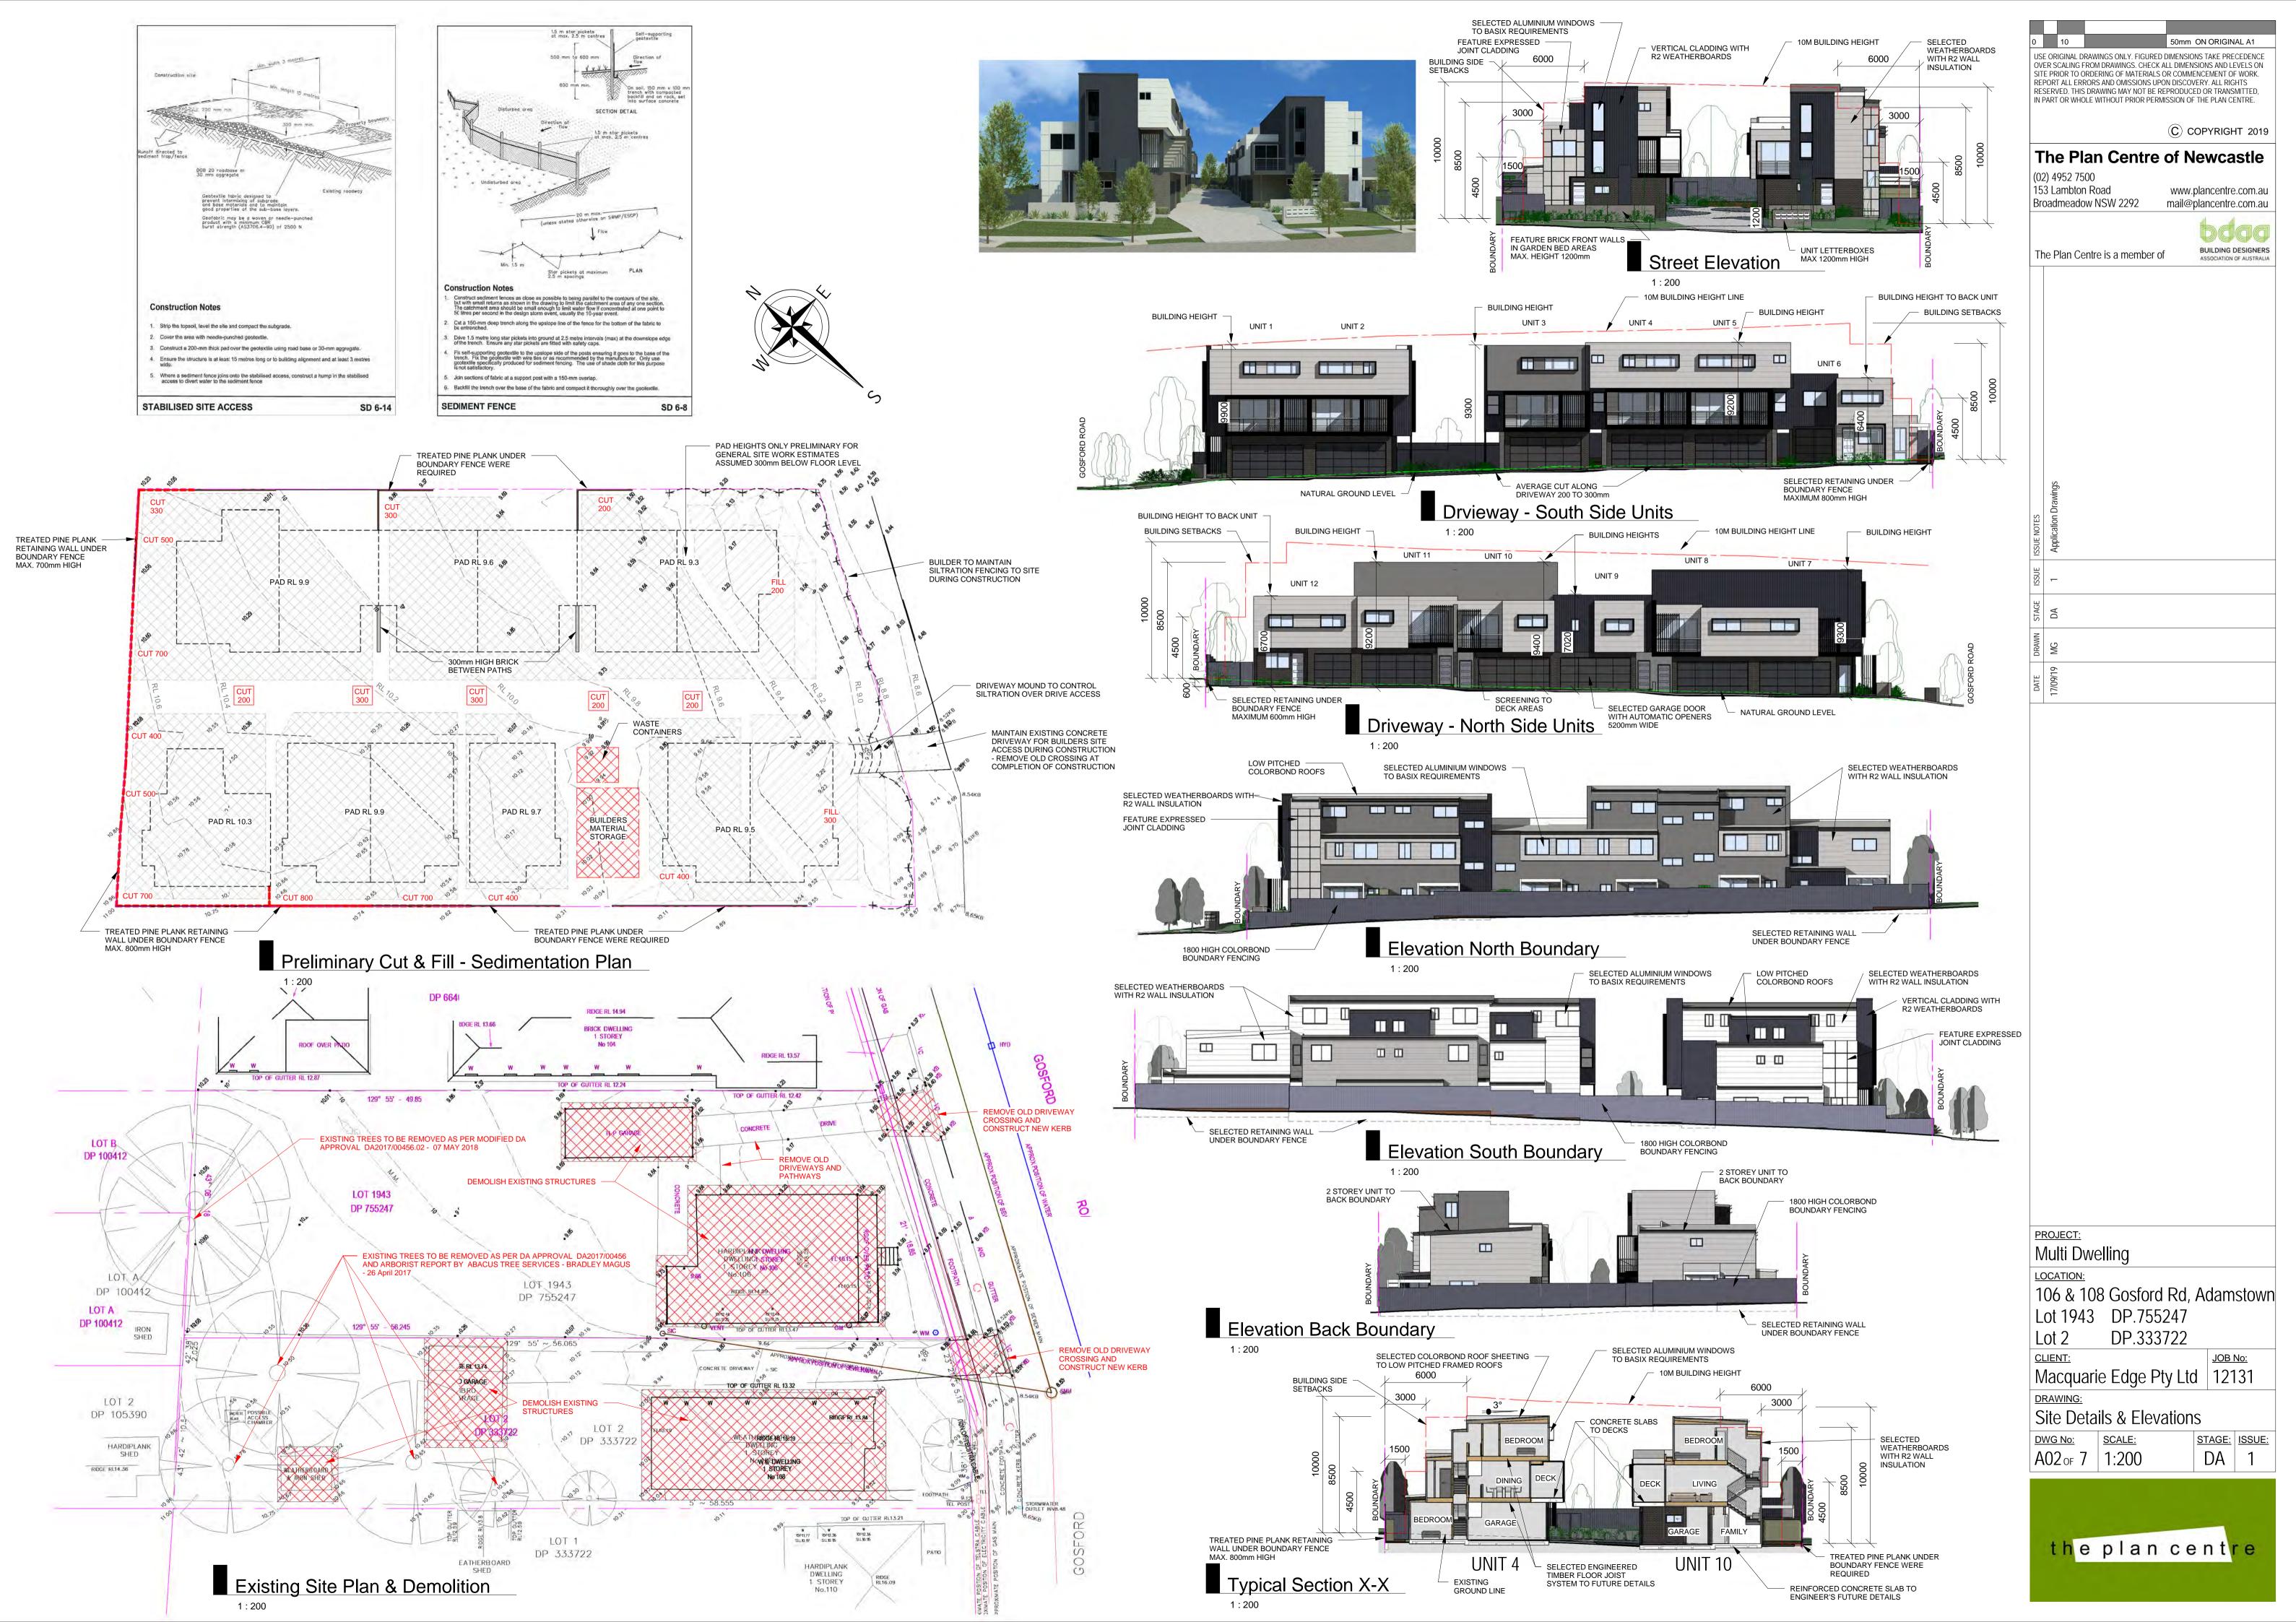

5.7

Certificate no.: 000
Assessor Name: Ga
Accreditation no.: VIO
Certificate date: 18
Dwelling Address:
106-108 Gosford Road
Adamstown, NSW

0004217480 Gavin Chambers VIC/BDAV/13/1491 18 September 2019

www.nathers.gov.au

September 2019

BSA Reference: 15176

Building Sustainability Assessments
enquiries@buildingsustainability.net.au
Important Note
The following specification was used to achieve the themal performance values indicated on the Assessor Certificate and takes precedence over any other specification.

If different construction elements are applied then the Assessor Certificate is no longer valid.

Thermal Performance Specifications (does not apply to garage)

External Wall Construction

Brick Veneer & Lightweight

R2.0

Internal Wall Construction

Plasterboard on studs

R2.0 to walls adjacent to garage

Plasterboard + studs + shaft liner + studs + Plasterboard (party walls)

R2.0 + R2.0

Ceiling Construction

Added Insulation

Plasterboard

R3.5 to ceilings adjacent to roof space

 Ceiling Construction
 Added Insulation

 Plasterboard
 R3.5 to ceilings adjacent to roof space

 Roof Construction
 Colour
 Added Insulation

 Metal
 Light
 Foil + R1.0 blanket

 Floor Construction
 Covering
 Added Insulation

 Concrete (waffle pod)(Ground floor)
 As drawn
 None

 Timber (First and second floor)
 As drawn
 R1.0 to floors adjacent to garage

 Timber (First and second floor)
 As drawn
 R2.0 to floors where open below

 Windows
 Glass and frame type
 U Value
 SHGC Range
 Area sq m

 ALM-001-01 A
 Aluminium Type A Single clear
 6.70
 0.51 - 0.63
 As drawn

 ALM-002-01 A
 Aluminium Type B Single clear
 6.70
 0.63 - 0.77
 As drawn

Type B windows are double hung windows, sliding windows & doors, fixed windows, stacker doors, louvres

Skylights Glass and frame type U Value SHGC Area sq m

U and SHGC values are according to AFRC. Alternate products may be used if the U value is lower and the SHGC is within the range specified

External Window Shading (eaves, verandahs, pergolas, awnings etc)

Type A windows are awning windows, bifolds, casements, till 'n 'turn' windows, entry doors, french doors

All shade elements modelled as drawn

Ceiling Penetrations (downlights, exhaust fans, flues etc)

No adjustment has been made for losses to insulation arising from ceiling penetrations.

#### 106-108 Gosford Road Adamstown SUMMARY OF BASIX COMMITMENTS FOR EACH UNIT This is a summary of the BASIX Commitments as detailed in the BASIX Certificate. Refer to the CURRENT BASIX Certificate for Complete details. For definitions refer to basix.nsw.gov.au WATER COMMITMENTS 3 Star Toilet Yes 3 Star Kitchen / Basin Taps Yes Alternative Water 1500 Collected from Roof Area (m2) 30 Tank Connected To: Laundry W/M Cold Tap Yes One Outdoor Tap Yes THERMAL COMFORT COMMITMENTS - Refer to TPA Specification on plans ENERGY COMMITMENTS Hot Water Gas Instantaneous 6 Star EER 2.5 - 3.0 1 Phase A/C Zoned EER 2.5 - 3.0 1 Phase A/C Zoned EER 2.5 - 3.0 EER 2.5 - 3.0 Manual on/off Manual on/off N/A Laundry









SECOND CEILING


SECOND FLOOR

FIRST CEILING

GROUND CEILING

GROUND FLOOR

Elevation 4 - U1-2

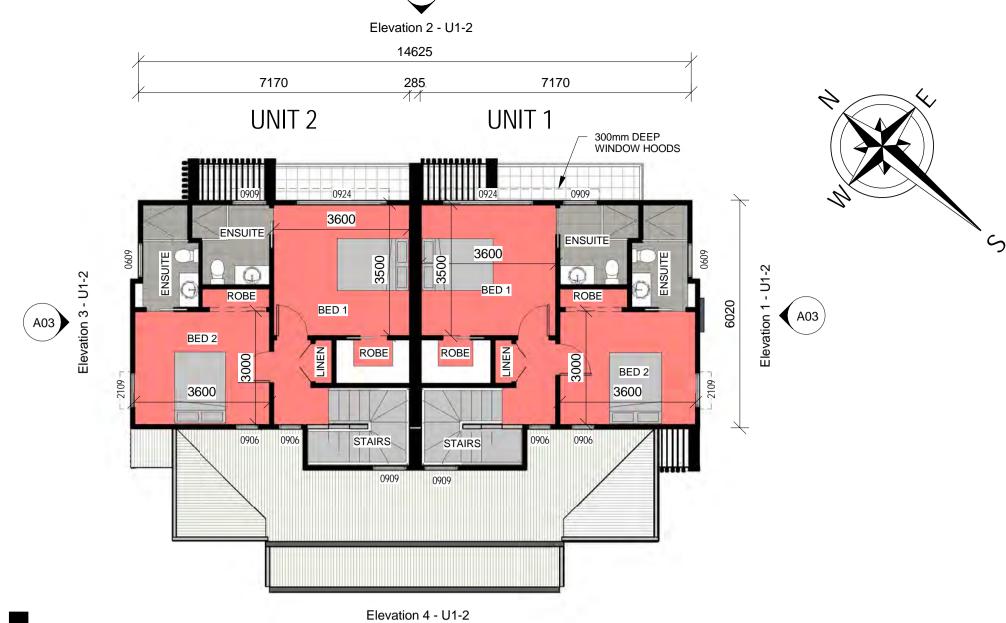

7380

A03

Units 1 & 2 - Second Floor

1:100

Elevation 4 - U1-2

A03

7380

15045

Units 1 & 2 - First Floor



Units 1 & 2 - Ground Floor

Unit		Ground Floor	Garage	First Floor	Deck	Second Floor	Total
1	- 3 Bed - 3 Storey	24.9	35.2	51.2	16.4	48.3	176.0 SqM
2	- 3 Bed - 3 Storey	24.9	35.2	51.2	16.4	48.3	176.0 SqM

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PROJECT:
Multi Dwelling

LOCATION:


106 & 108 Gosford Rd, Adamstown
Lot 1943 DP.755247
Lot 2 DP.333722

CLIENT:
Macquarie Edge Pty Ltd 12131

DRAWING:
Unit Plans - 1 & 2

DWG No: SCALE: STAGE: ISSUE:
A03 of 7 1:100 DA 1



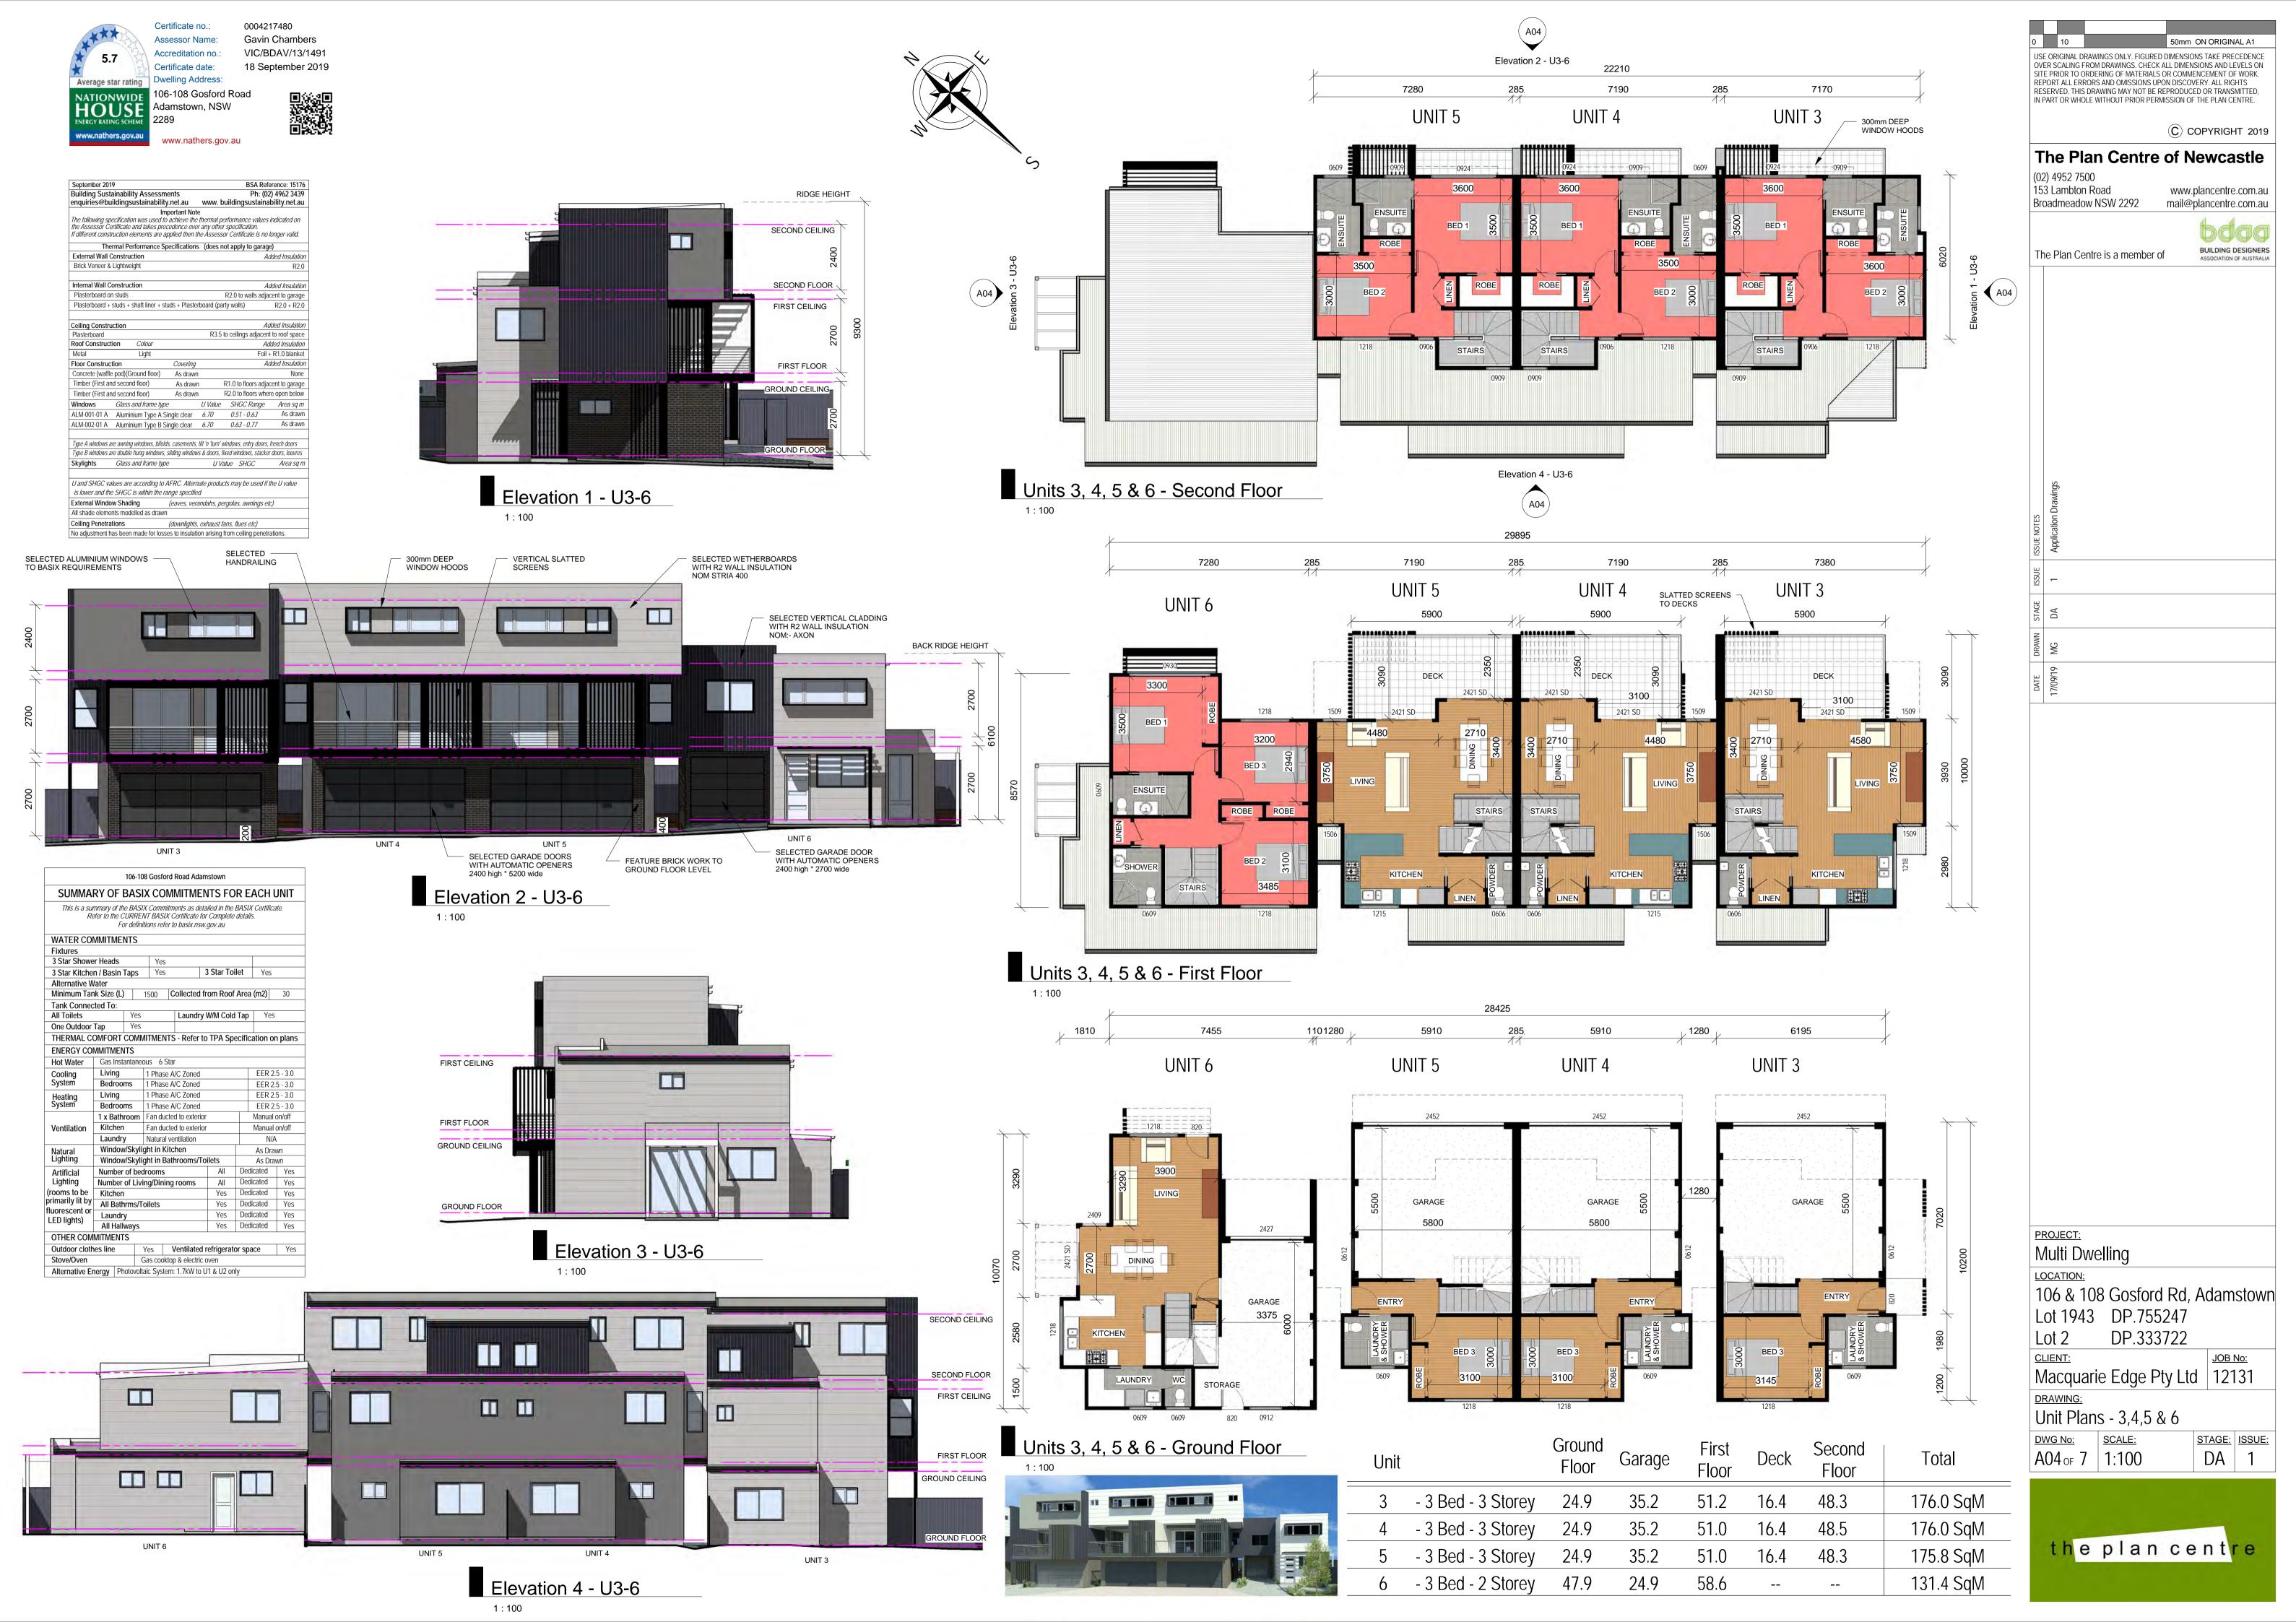

5.7

Average star rating
NATIONWIDE
HOUSE
ENERGY RATING SCHEME

www.nathers.gov.au

Certificate no.: 000
Assessor Name: Ga
Accreditation no.: VIC
Certificate date: 18
Dwelling Address:


0004217480
Gavin Chambers
UIC/BDAV/13/1491
18 September 2019

106-108 Gosford Road
Adamstown, NSW
2289

www.nathers.gov.au

**Building Sustainability Assessments** Ph: (02) 4962 3439 enquiries@buildingsustainability.net.au www. buildingsustainability.net.au Important Note
The following specification was used to achieve the thermal performance values indicated on the Assessor Certificate and takes precedence over any other specification.

If different construction elements are applied then the Assessor Certificate is no longer valid. Thermal Performance Specifications (does not apply to garage) External Wall Construction Brick Veneer & Lightweight Internal Wall Construction R2.0 to walls adjacent to garage Plasterboard on studs Plasterboard + studs + shaft liner + studs + Plasterboard (party walls) Ceiling Construction R3.5 to ceilings adjacent to roof space Roof Construction Colour Foil + R1.0 blanket Floor Construction Concrete (waffle pod)(Ground floor) As drawn As drawn As drawn ALM-001-01 A Aluminium Type A Single clear 6.70 0.51 - 0.63 ALM-002-01 A Aluminium Type B Single clear *6.70 0.63 - 0.77* Type A windows are awning windows, bifolds, casements, tilt 'n 'turn' windows, entry doors, french doors ype B windows are double hung windows, sliding windows & doors, fixed windows, stacker doors, louvres U Value SHGC Skylights Glass and frame type U and SHGC values are according to AFRC. Alternate products may be used if the U value is lower and the SHGC is within the range specified External Window Shading (eaves, verandahs, pergolas, awnings etc) All shade elements modelled as drawn Ceiling Penetrations (downlights, exhaust fans, flues etc) No adjustment has been made for losses to insulation arising from ceiling penetrations

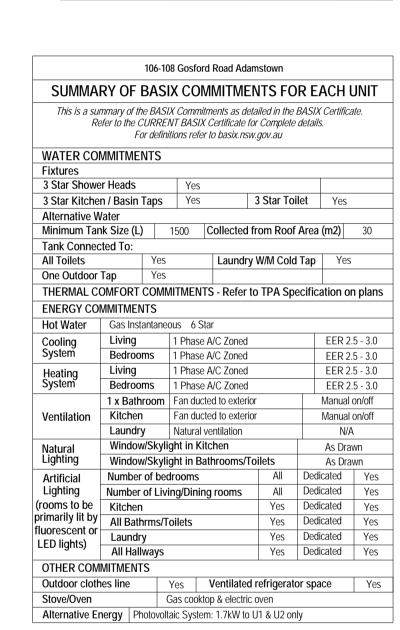





( A06)

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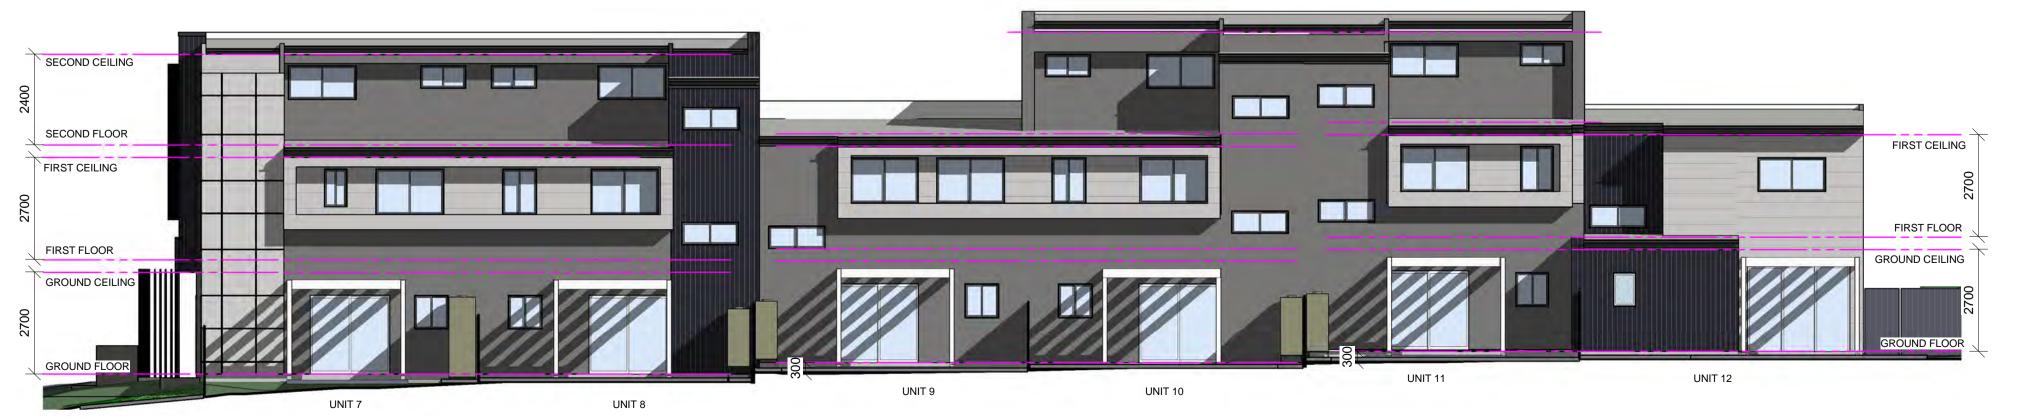
the plan cent<mark>re</mark>



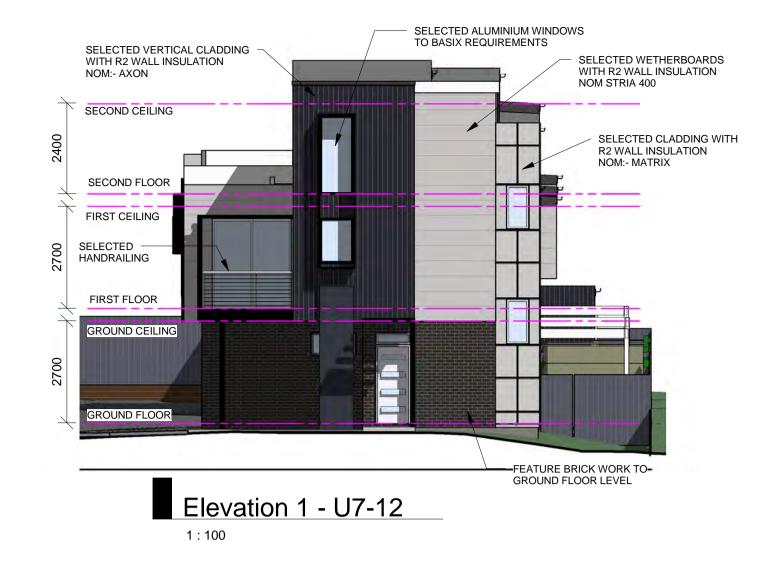

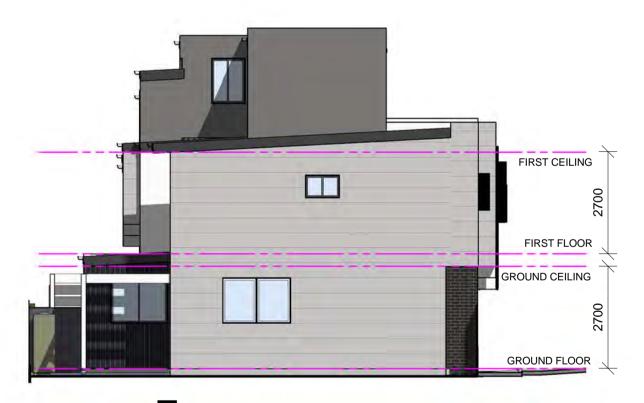

# Elevation 3 - U7-12



Elevation 4 - U7-12

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BUILDING DESIGNERS
ASSOCIATION OF AUSTRALIA

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The Plan Centre is a member of

PROJECT:
Multi Dwelling

LOCATION:

106 & 108 Gosford Rd, Adamstown Lot 1943 DP.755247 DP.333722


CLIENT: JOB No: 12131

Unit Elevations - 7,8,9,10,11 & 12 STAGE: ISSUE:

DWG No: SCALE: 1:100

DA 1



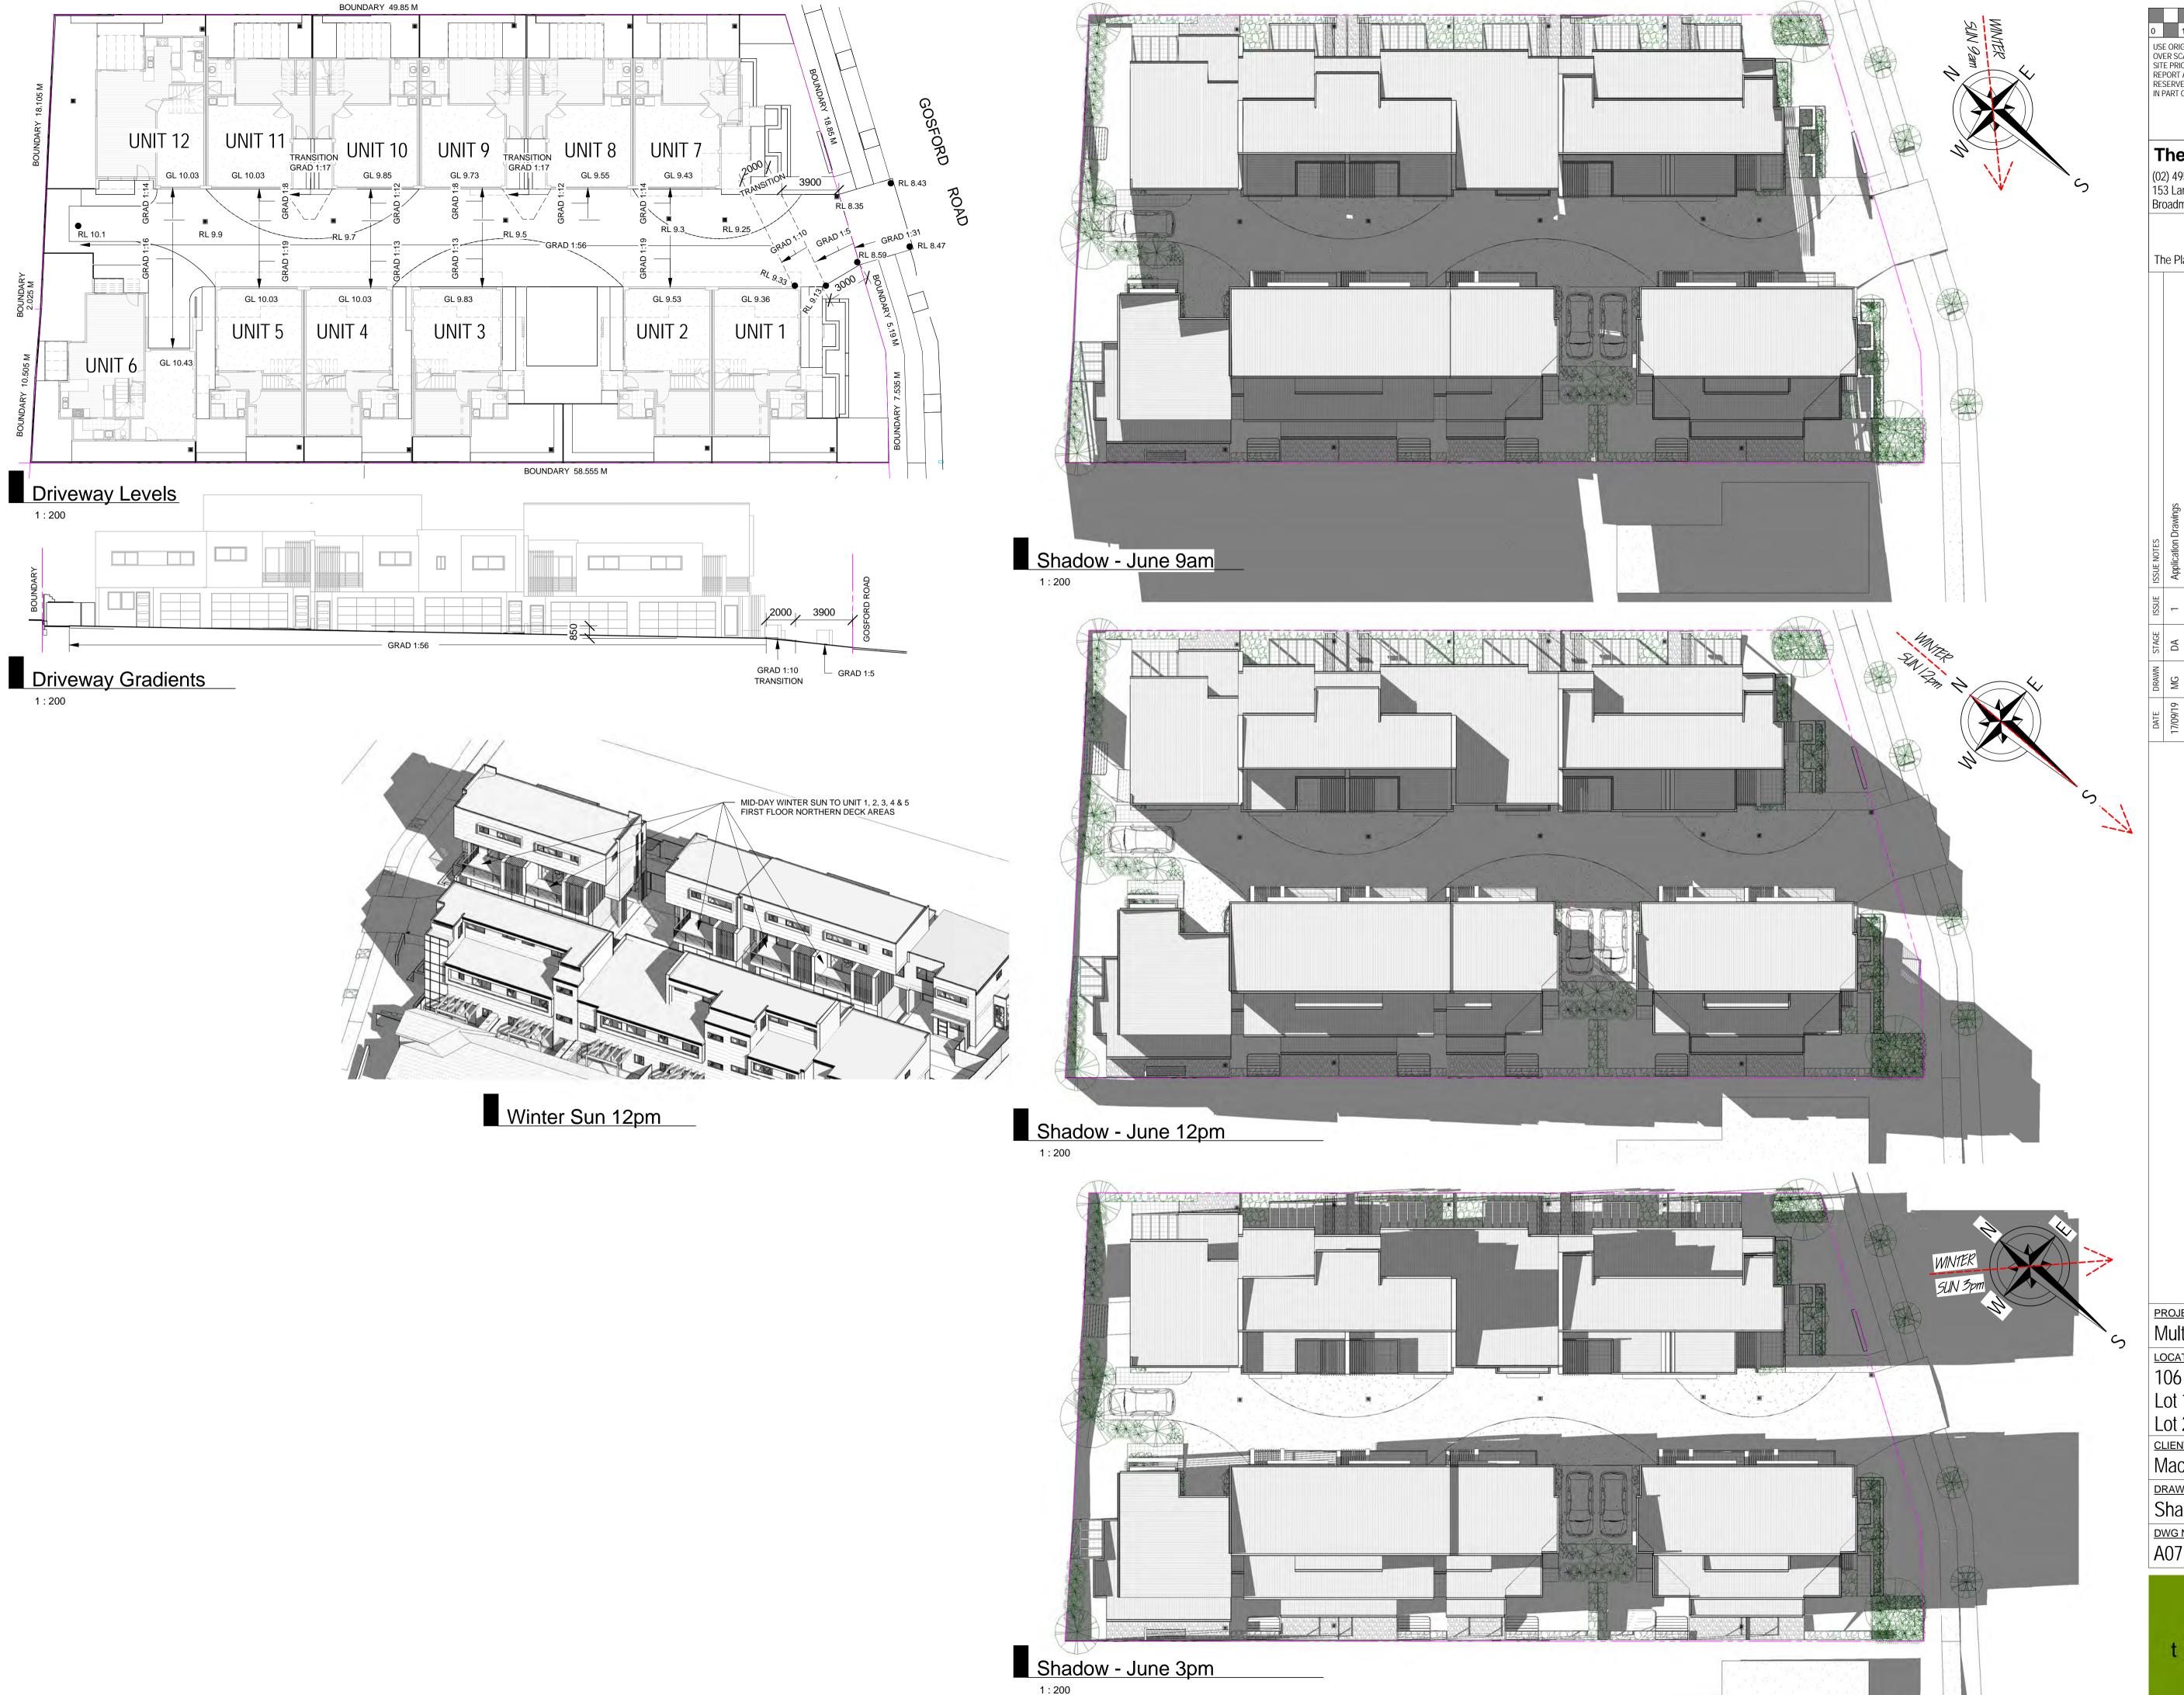

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ASSOCIATION OF AUSTRALIA The Plan Centre is a member of

PROJECT:
Multi Dwelling

106 & 108 Gosford Rd, Adamstown Lot 1943 DP.755247 DP.333722


CLIENT: JOB No: 12131

Shadows & Driveway Grades

DWG No: SCALE: 1:200

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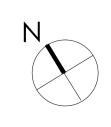
STAGE: ISSUE:

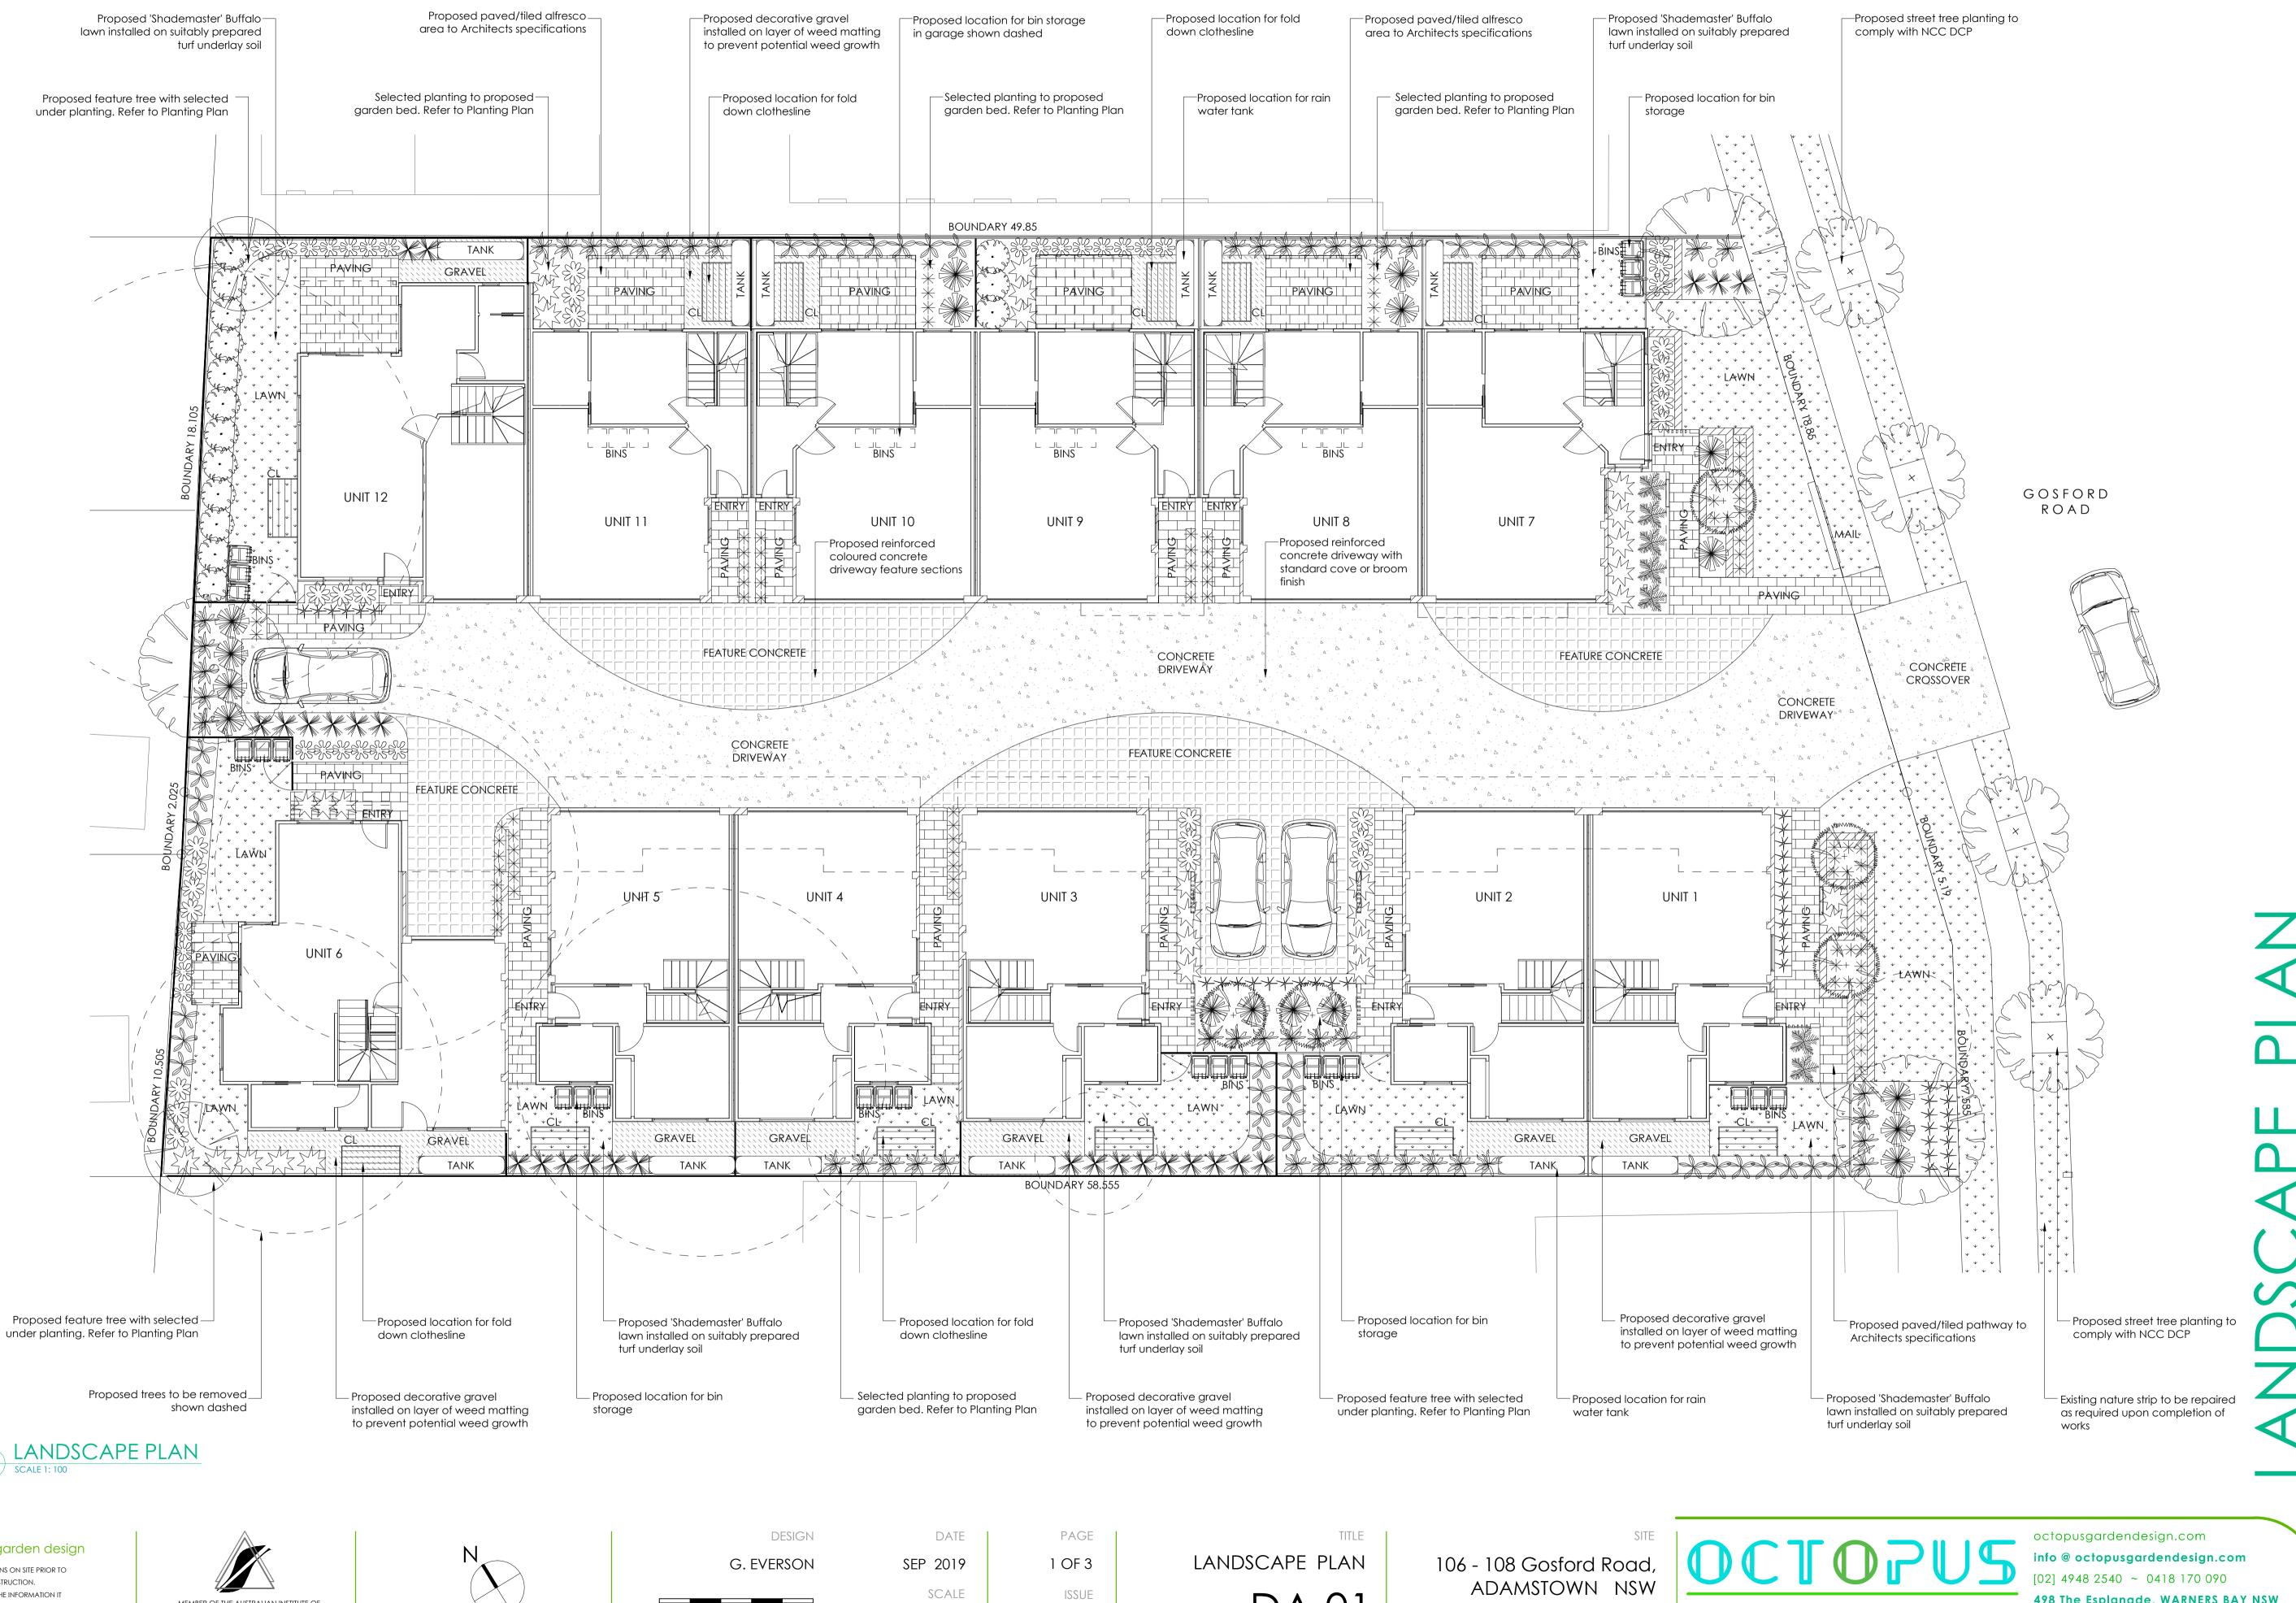



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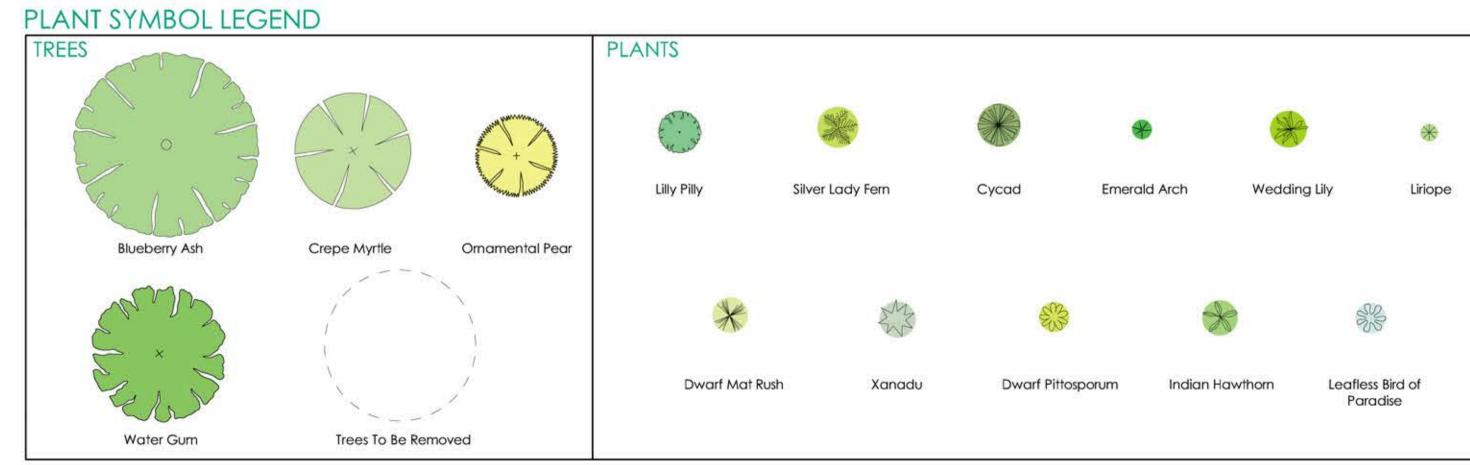
DA 01





# PLANT SCHEDULE

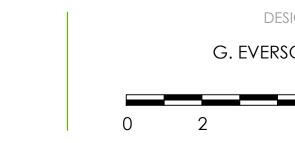
PLANT SCHEDULE		T			Some proming me	ay be required to achie	ve desired indiring
Tree Species	Common Name	Quantity	Pot Size	Install Height	Install Width	Final Height	Final Width
Elaeocarpus reticulatus	Blueberry Ash	3	45Lt	150cm	80cm	8m	5m
Lagerstroemia indica 'Natchez'	Crepe Myrtle	2	45L†	150cm	100cm	6m	5m
Pyrus calleryana 'Capital'	Ornamental Pear	5	45L†	150cm	80cm	6m	2m
Tristaniopsis laurina 'Luscious'	Water Gum	4	45L†	150cm	80cm	6m	4m
Acmena smithii	Lilly Pilly Hedge	15	20cm	50cm	20cm	300cm	90cm
Plant Species Acmena smithii	Lilly Pilly Hedge	15	20cm	50cm	20cm	300cm	90cm
Blechnum sp.	Silver Lady Fern	7	15cm	20cm	30cm	120cm	120cm
Cycas revoluta	Cycad	17	20cm	30cm	40cm	90cm	120cm
Dianella tasmanica 'Emerald Arch'	Emerald Arch	42	15cm	30cm	10cm	50cm	50cm
Dietes irridioides	Wedding Lilly	46	15cm	30cm	20cm	80cm	60cm
Liriope muscari	Liriope	93	15cm	40cm	40cm	30cm	30cm
Lomandra 'Tanika'	Dwarf Mat Rush	26	15cm	30cm	20cm	80cm	80cm
Phioldendron 'Xanadu'	Xanadu	29	20cm	30cm	30cm	90cm	90cm
Pittosporum'Miss Muffet'	Dwarf Pittosporum	26	20cm	20cm	20cm	80cm	80cm
Rhaphiolepis indica 'Snow Maiden'	Indian Hawthorn	34	15cm	20cm	30cm	80cm	80cm
Strelitzia juncea	Leafless Bird of Paradise	26	20cm	30cm	20cm	90cm	80cm

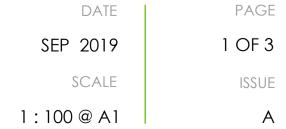


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TITLE



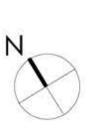

## PLANT IMAGES

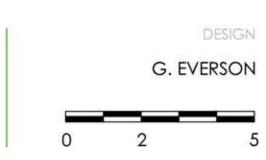

Ornamental Pear



Crepe Myrtle

Lilly Pilly Silver Lady Fern Cycad Emerald Arch Wedding Lilly Liriope



Dwarf Lomandra Xanadu Dwarf Pittosporum Indian Hawthorn Leafless Bird of Paradise

# LANDSCAPE SPECIFICATIONS

All garden beds are to be excavated to a depth of 300mm below the specified finished design levels to remove the existing compacted material in preparation for soil placement and planting.

#### **Sub-Soil Preparation** Cultivation

Cultivate the base of planting beds and planting holes to a depth of 150mm. Ensure the sides of the planting holes are cultivated and not compacted smooth by tools or mechanical digging. Do not disturb tree roots or services; if necessary, cultivate these areas by hand. Cultivate manually within 300mm of paths or structures. Remove stones exceeding 25mm, clods of earth exceeding 50mm and any weeds, stick, rubbish or other deleterious material brought to the surface during cultivation. Trim the surface to the required design levels after cultivation.

Soil for the purposes of landscape works shall be free from weeds and other deleterious materials or any material toxic to plant health. Soil Level

Finished soil levels shall allow mulch to be finished level to the top of the timber edging, paving or concrete foot paths or as otherwise shown on construction drawings.

Place the approved soil on the prepared sub-soil. Spread and grade evenly, making the necessary allowances so that the required finished design levels and contours may be achieved after light compaction. Avoid differential subsidence and produce a finished soil surface which is:

- smooth and free from stone or lumps of soil graded to drain freely, without ponding to catchment points
- graded evenly into adjoining ground surfaces
- ready for planting

# FERTILISERS

Ensure the use of an approved slow release fertiliser appropriate for Australian native plants equivalent to Osmocote Native with an N:P:K ration of 17.9:0.8:7.3. Apply at a rate recommended by the manufacturer and use only in accordance with manufacturers recommendations. Apply to each plant/planting hole as applicable.

Blueberry Ash

Ensure mulch is free from deleterious and extraneous matte such as soil, weeds, stones and sticks. Ensure the mulch contains less than 5% fines. Place mulch to a depth of 75mm and as specified in the Planting Notes. Rake mulch to an even surface flush with the surrounding finished levels.

Supply plants to the following quality:

are vigorous, well established, free from disease and pests, of good foliage, have large healthy root systems with no evidence of root curl, restriction or

are hardened off, not soft or forced and suitable for planting in the natural climatic conditions prevailing at the site

do not require staking to stand upright other that staking to control damage from strong wind or local conditions until established

Make no substitutions unless instructed by Octopus Garden Design

# Label at least one plant of each species or variety in a batch with a readable tag

Replacements Use only plants of the same type, quality and size when replacing plants that are damaged, fail or are rejected

Deliver plant material to the site on a day to day basis and plant immediately after delivery. If this is not possible, keep the plants in good condition on the site, adequately protected from frost, wind, sun and vermin by appropriate storage methods including the establishment of an on-site nursery of sufficient size with provision for watering and care of stored stock

Planting Conditions: Do not plant in unsuitable weather conditions such as extreme heat, wind, cold or rain. Watering: Thoroughly water all plants before planting with a diluted solution of seaweed based plant tonic. Immediately after planting, water with seaweed tonic -water solution.

Ensure the plants are kept moist but not wet for the next (6) weeks by deep watering at least

once per week Placing: Remove the plant from the pot or container ensuring minimum disturbance to the root-ball and growing media. Place the root-ball in the centre of the prepared hole as outlined in the Planting Detail; ensure the plant is plumb and the topsoil level of the plant root-ball is level with the finished surface level of the surrounding soil.

Backfilling: Back fill the hole with excavated soil that has had organic compost added or use a topsoil mixture as specified. Lightly firm the soil around the plant and then irrigate to field capacity. Keep the topsoil away from the plant stem or trunk and ensure the root-ball remains level with the finished ground levels as per the

Mulching: Cover the area around and between the plants with organic mulch to a depth of 75mm. Ensure that the mulch does not contact the stem/trunk of the plant.

The care of newly planted plants is critical for the first 52 weeks depending on the species, growth rate and stage of plant development.

It is recommended that a 52 week maintenance period be undertaken to ensure a minimum 90% success rate of all plants and trees. During this period works should include but not limited to watering, weeding, fertilising, pest and disease control, re-turfing, staking and tying, replanting, pruning, aerating and top dressing as necessary.

## Water Managment Strategies for newly planted materials:


Water Gum

 Maintain adequate soil moisture - match supplemented water needs to climatic conditions and available soil moisture. Daily monitoring of the soil moisture and root ball is recommended for the first few weeks after installation.


Water early in the morning or late in the afternoon to reduce water loss due to evaporation

Avoid over-watering as this may lead to root rot


Garden edging shall be assumed to be laid to all mass planting beds that interface with turf, gravel or mulched areas. Edging material shall be fixed so that it does not lift, twist or create a trip hazard and finish flush with adjoining surfaces.

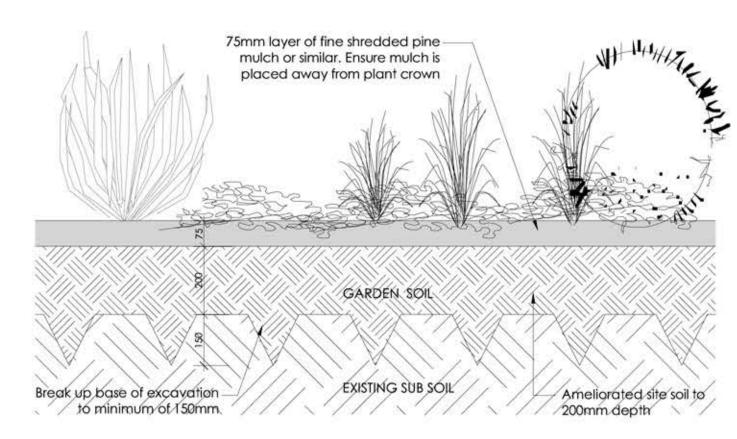

# GARDEN AREA PROFILE

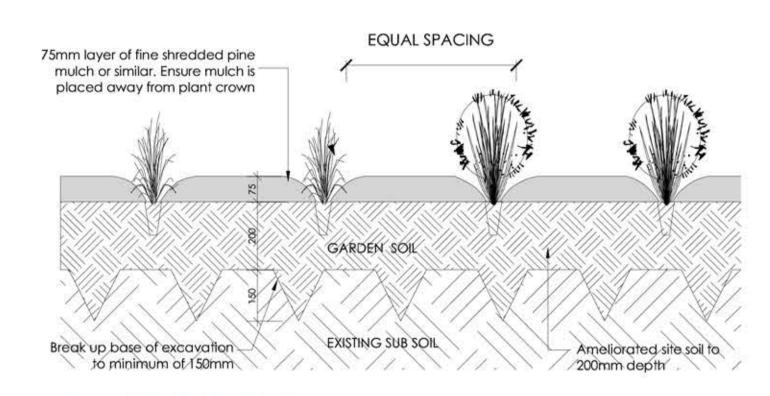

# PLANTING SETOUT

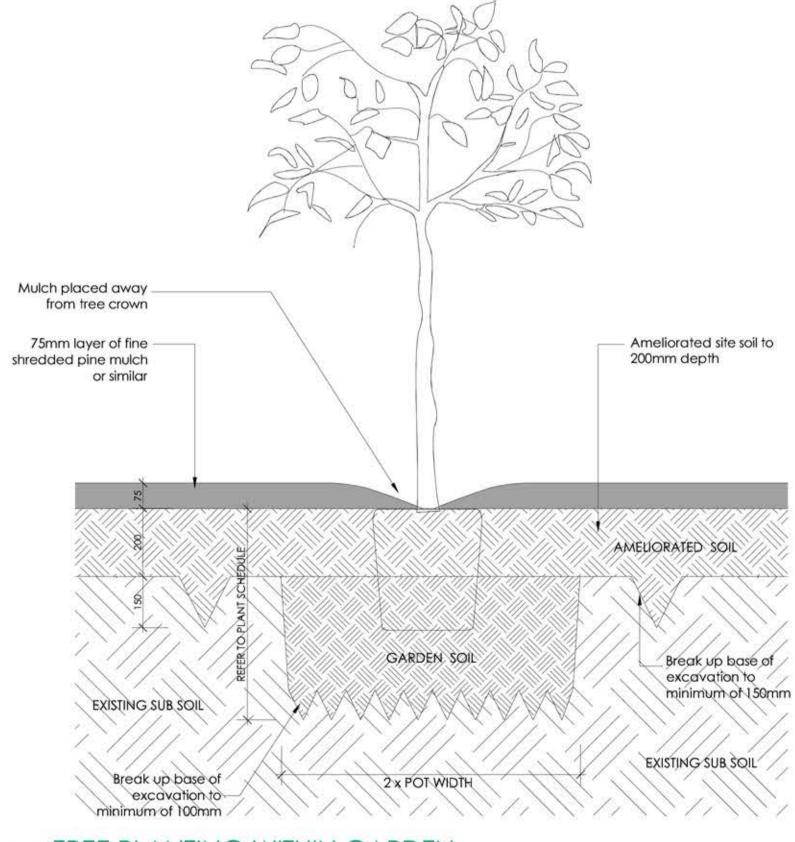

TREE PLANTING WITHIN GARDEN

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G. EVERSON

DATE SEP 2019

3 OF 3


+ PLANT IMAGES


106 - 108 Gosford Road, ADAMSTOWN NSW




octopus garden design

DESIGN

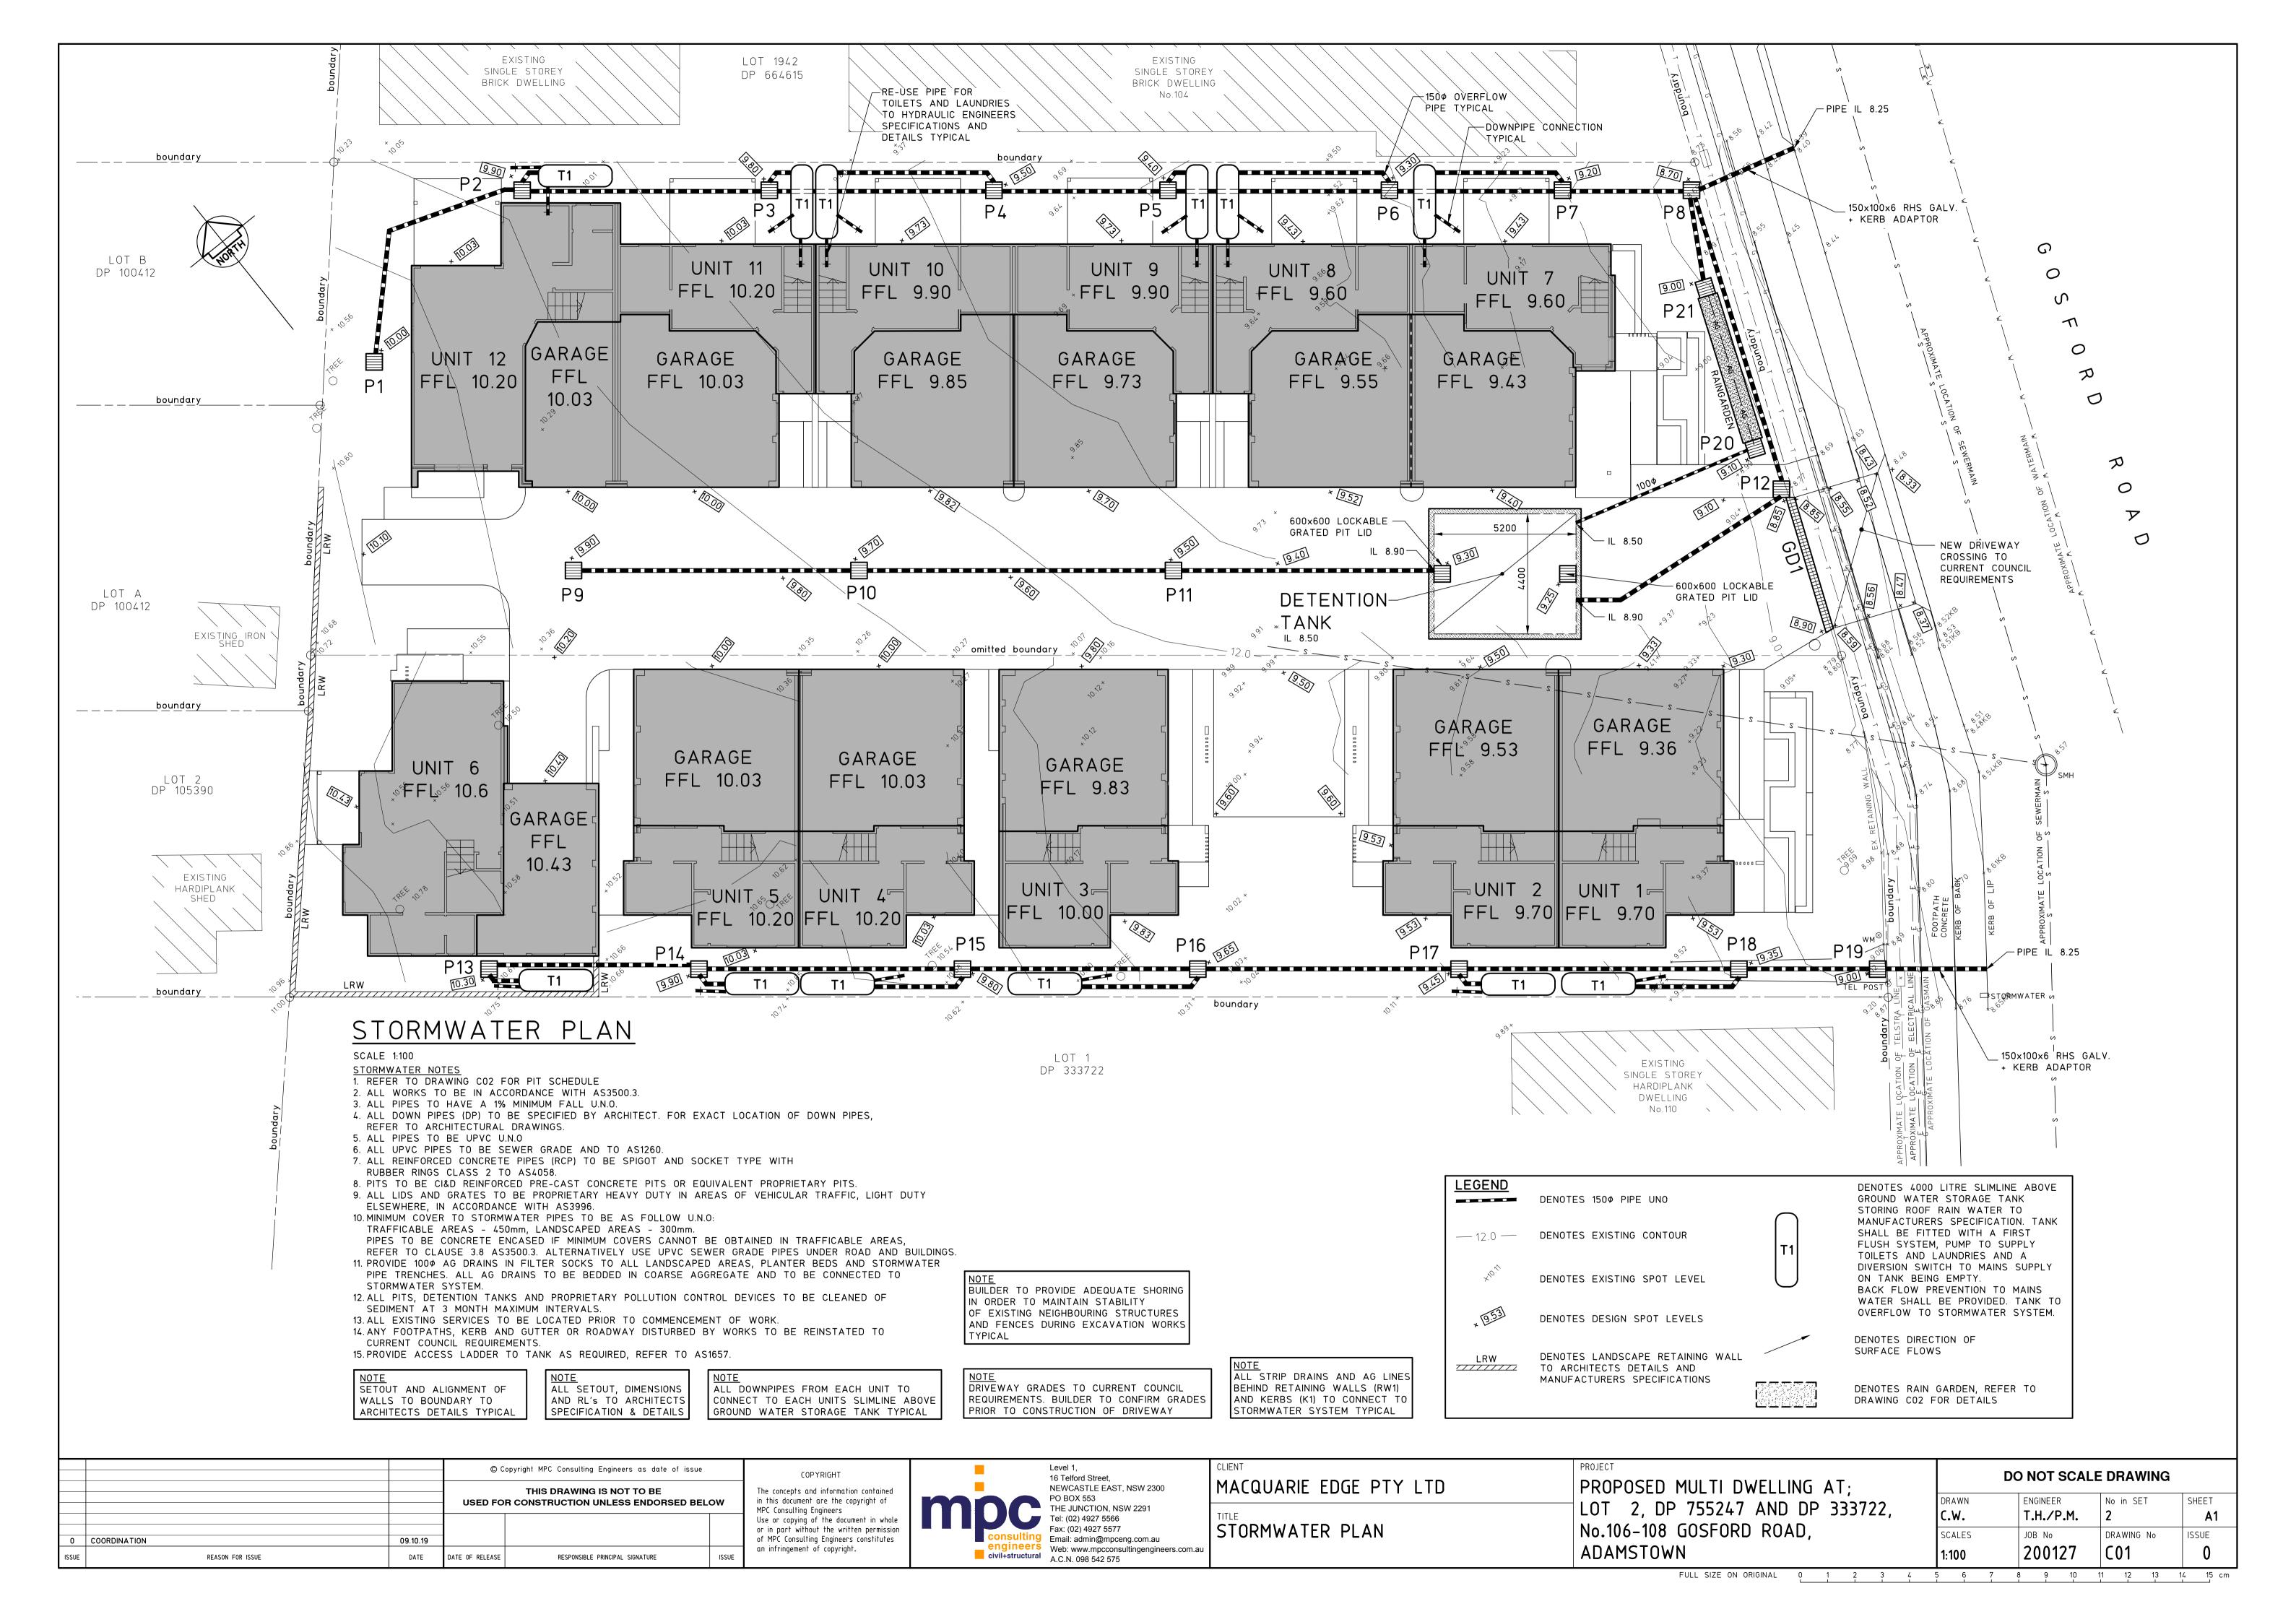


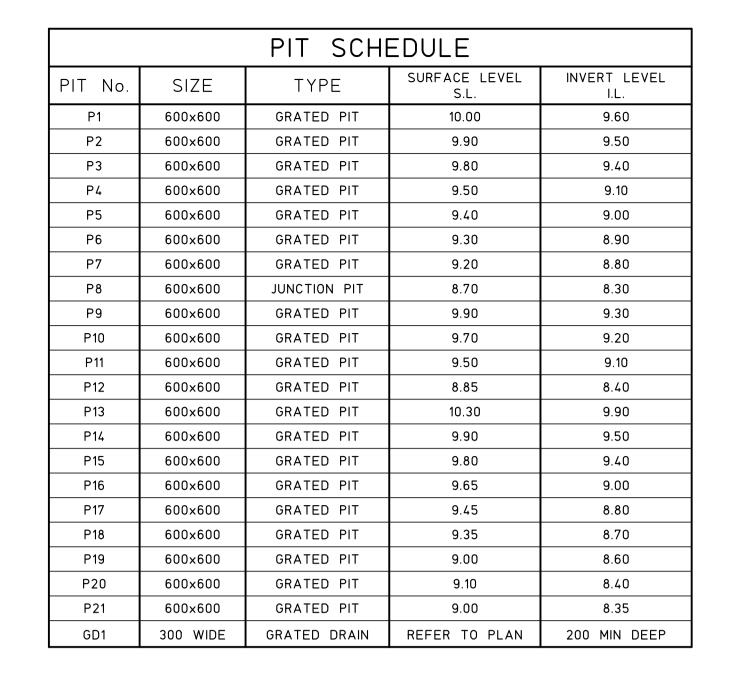

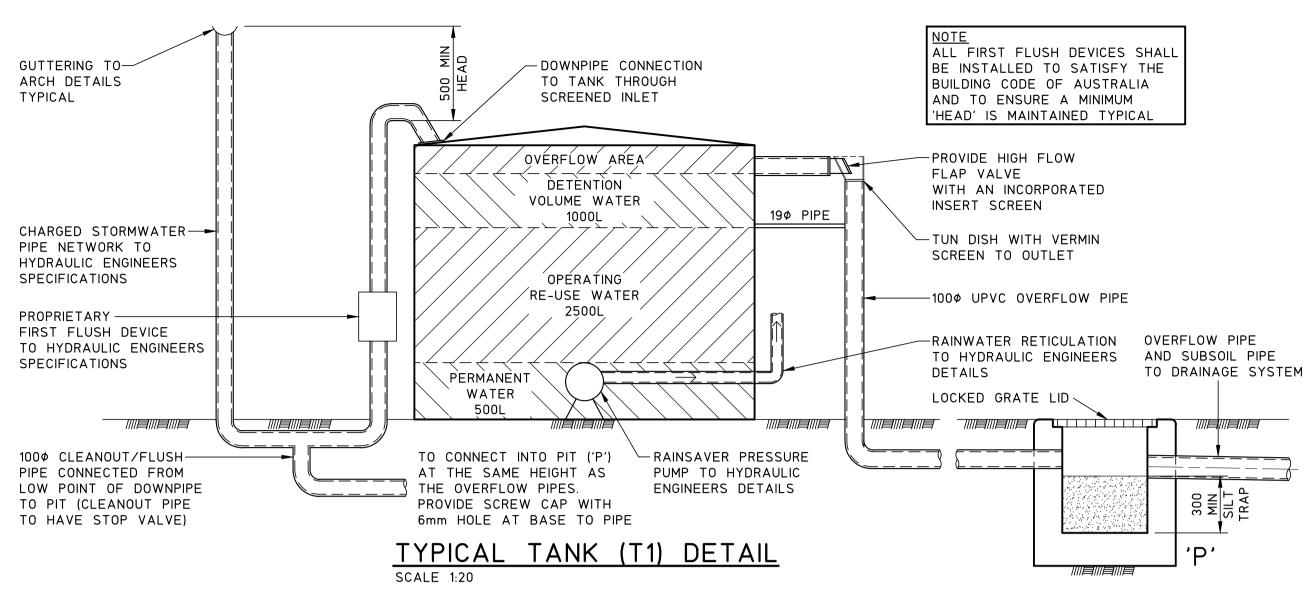

WATER MANAGEMENT CALCULATIONS AREA CALCULATIONS TOTAL SITE AREA =  $1680 \text{m}^2$ TOTAL IMPERMEABLE AREA = 1176m<sup>2</sup> SITE STORAGE REQUIREMENTS SITE STORAGE REQUIRED = 30m3 (FIGURE 1, SECTION 7.06, DCP 2012) PROPOSED TO STORE ROOF RAINWATER IN ABOVE GROUND SLIMLINE WATER TANKS AND RE-USE IN TOILETS AND LAUNDRIES. MAIN DRAW DOWN: 11 - 3 BEDROOMS - 25m³ 1 - 2 BEDROOM - 1.9m SITE DISCHARGE CONTROLS PROVIDE 1 x 4000 LITRE ABOVE GROUND SLIMLINE WATER TANK FOR RE-USE PER UNIT WITH 2.5m3 AS RE-USE AND 0.5m3 AS PERMANENT WATER AND 1.0m3 AS DETENTION. DRIVEWAY AREA =  $370m^2$ PROVIDE 9m3 OF STORAGE AND 4.0m2 RAINGARDEN FOR POLISHING FALL ALL PAVED AREAS TO GRASSED OR LANDSCAPED AREAS.

PROVIDE HIGH LEVEL OVERFLOW FROM STORMWATER SYSTEM TO PIT IN BACK RESERVE.

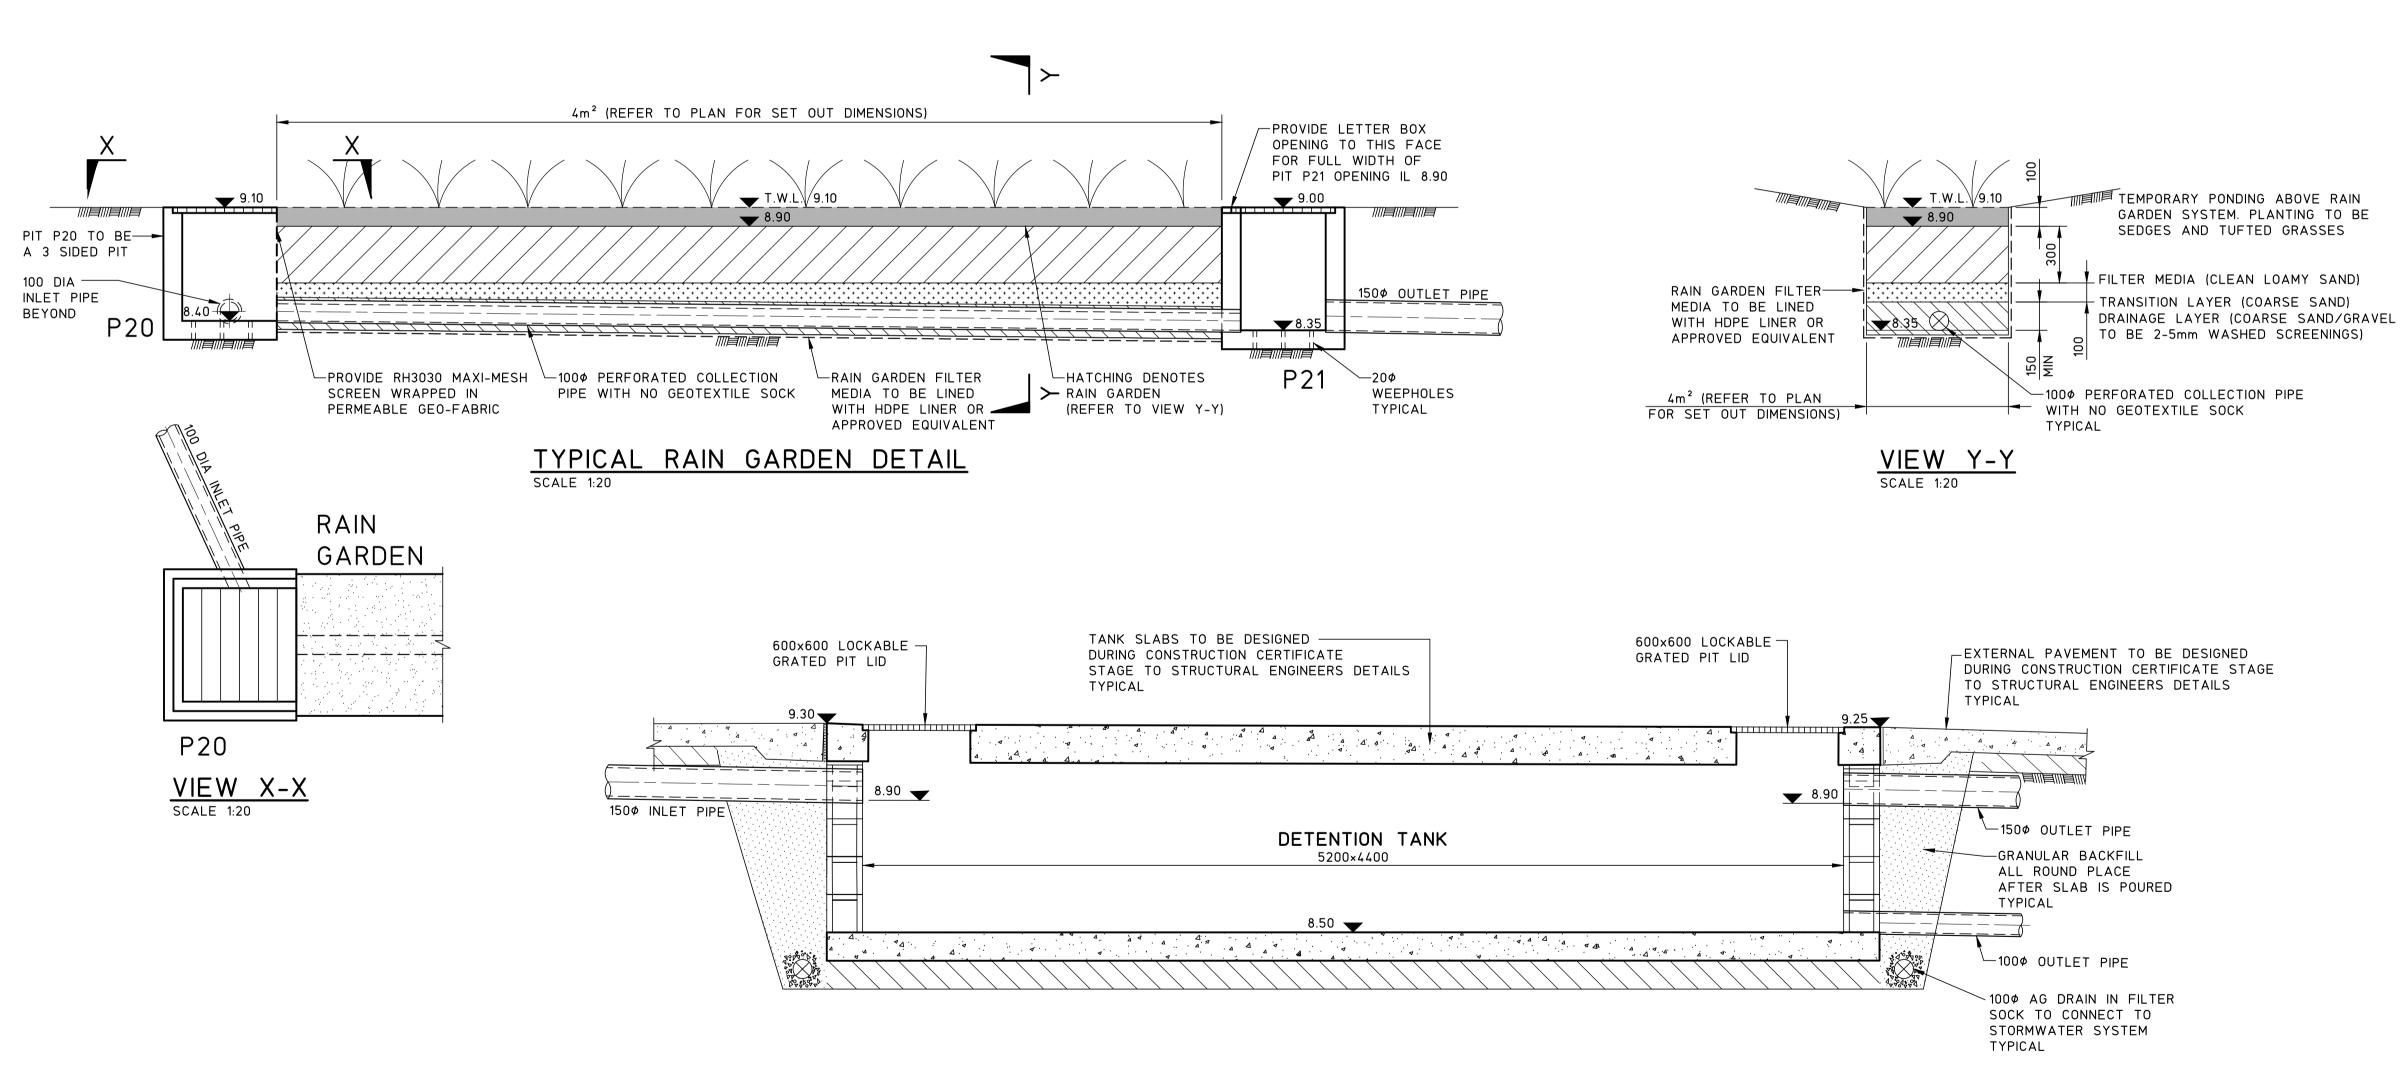

# TYPICAL DETENTION TANK SECTION

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0	COORDINATION	09.10.19			
ISSUE	REASON FOR ISSUE	DATE	DATE OF RELEASE	RESPONSIBLE PRINCIPAL SIGNATURE	ISSUE

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16 Telford Street, NEWCASTLE EAST, NSW 2300 PO BOX 553 THE JUNCTION, NSW 2291 Tel: (02) 4927 5566 Fax: (02) 4927 5577 Email: admin@mpceng.com.au engineers Web: www.mpcconsultingengineers.com.a civil+structural A.C.N. 098 542 575

MACQUARIE EDGE PTY LTD PIT SCHEDULE AND STORMWATER DETAILS

PROPOSED MULTI DWELLING AT; LOT 2, DP 755247 AND DP 333722, No.106-108 GOSFORD ROAD, ADAMSTOWN

DO NOT SCALE DRAWING No in SET DRAWN c.w. T.H./P.M. Α1 SCALES JOB No DRAWING No ISSUE 200127 C02

## PUBLIC VOICE COMMITTEE MEETING

#### 17 MARCH 2020

PV 17/03/2020

#### DA2019/01146 - 106 GOSFORD ROAD ADAMSTOWN

**Attachment B: Processing Chronology** 



### PROCESSING CHRONOLOGY

#### DA2019/01146 - 106-108 Gosford Road Adamstown

22 October 2019 - Application lodged

31 October 2019 to - Public Notification 18 November 2019

17 March 2020 - Public Voice Committee Meeting



### ATTACHMENTS DISTRIBUTED UNDER SEPARATE COVER

ITEM 2 DA2019/01255 - 25 LLEWELLYN STREET MEREWETHER

Veterinary Hospital - change of use from a commercial premise

**Attachment A - Submitted Plans** 

**Attachment B** - Processing Chronology


### PUBLIC VOICE COMMITTEE MEETING

#### 17 MARCH 2020

#### PV 17/03/2020

#### DA2019/01255 - 25 LLEWELLYN STREET MEREWETHER

**Attachment A: Submitted Plans** 

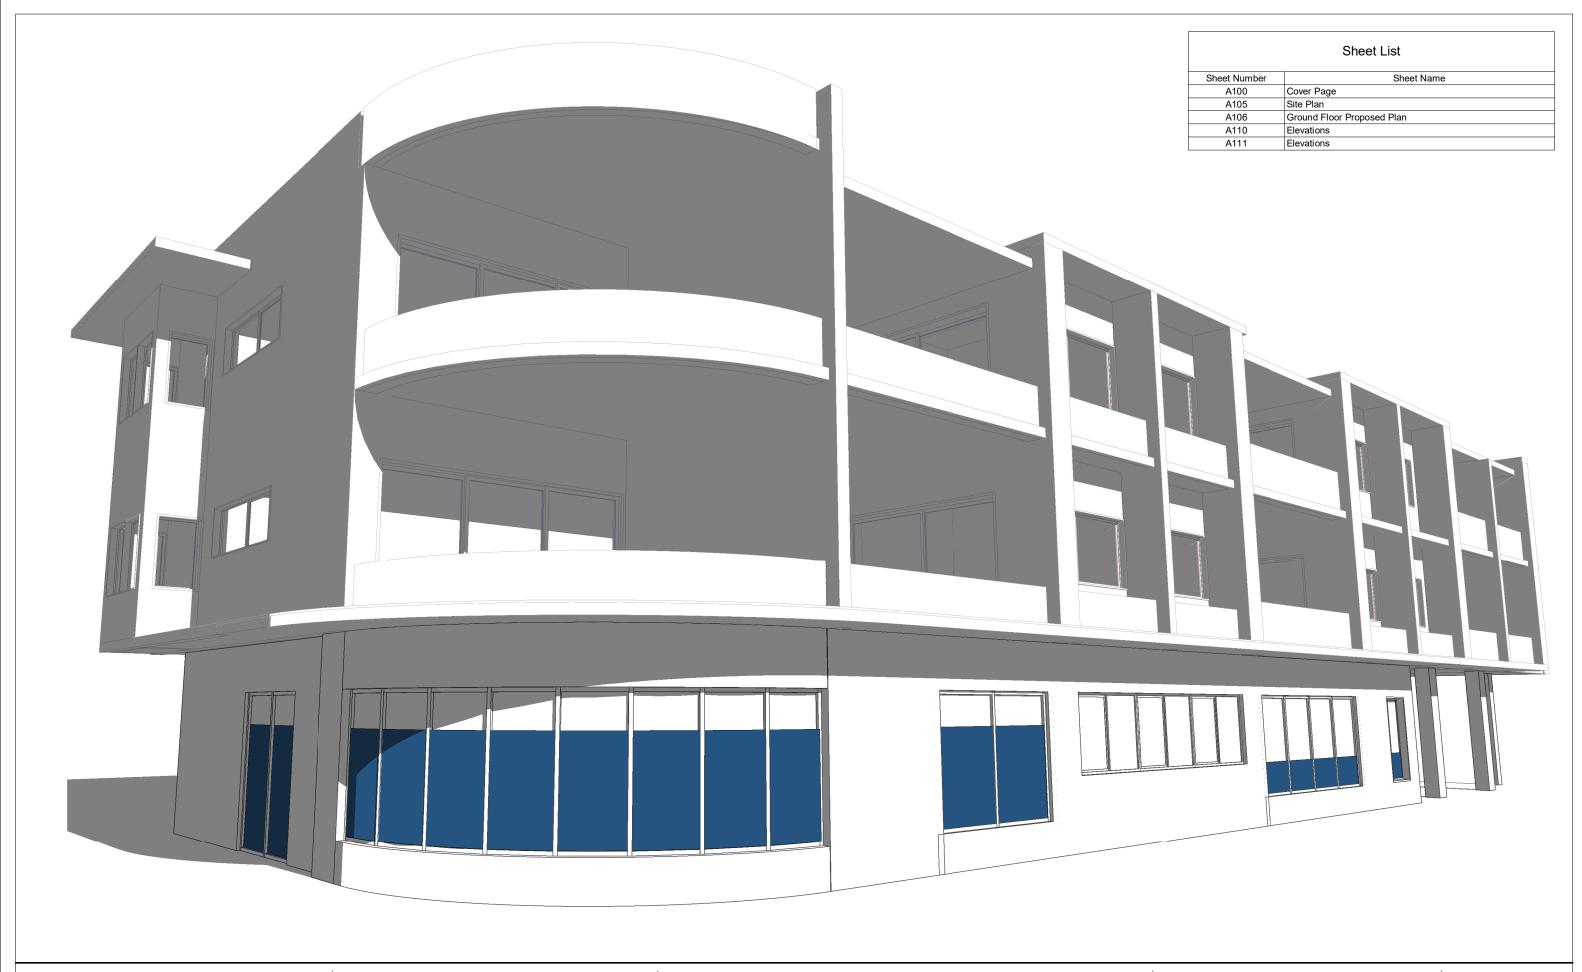



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THE BUILDER SHALL CHECK ALL DIMENSIONS AND LEVELS ON SITE PRIOR TO CONSTRUCTION.

NOTIFY ANY ERRORS, DISCREPANCIES OR OMISSIONS TO THE ARCHITECT. DRAWINGS SHALL NOT BE USED FOR CONSTRUCTION PURPOSES UNTIL ISSUED FOR CONSTRUCTION.
DO NOT SCALE DRAWINGS.
ALL BOUNDARIES AND CONTOURS SUBJECT TO SURVEY.

**Proposed Fitout** PROJECT:

**Merewether Veterinary Hospital** CLIENT: 25 LLEWELYN STREET, MEREWETHER ADDRESS:

DRAWING TITLE: Cover Page

SCALE: JCC DRAWN BY: DATE: 08/11/19 STATUS: FOR DA DRAWING NO: A100

REV: C

Document Set ID: 6192443 Version: 1, Version Date: 25/11/201





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ALL BOUNDARIES AND CONTOURS SUBJECT TO SURVEY.

**Proposed Fitout** PROJECT:

**Merewether Veterinary Hospital** CLIENT: **25 LLEWELYN STREET, MEREWETHER** ADDRESS:


DRAWING TITLE: Site Plan

SCALE: 1:600 DRAWN BY: JCC DATE: 08/11/19 STATUS: FOR DA DRAWING NO: A105

NORTH

REV:

C

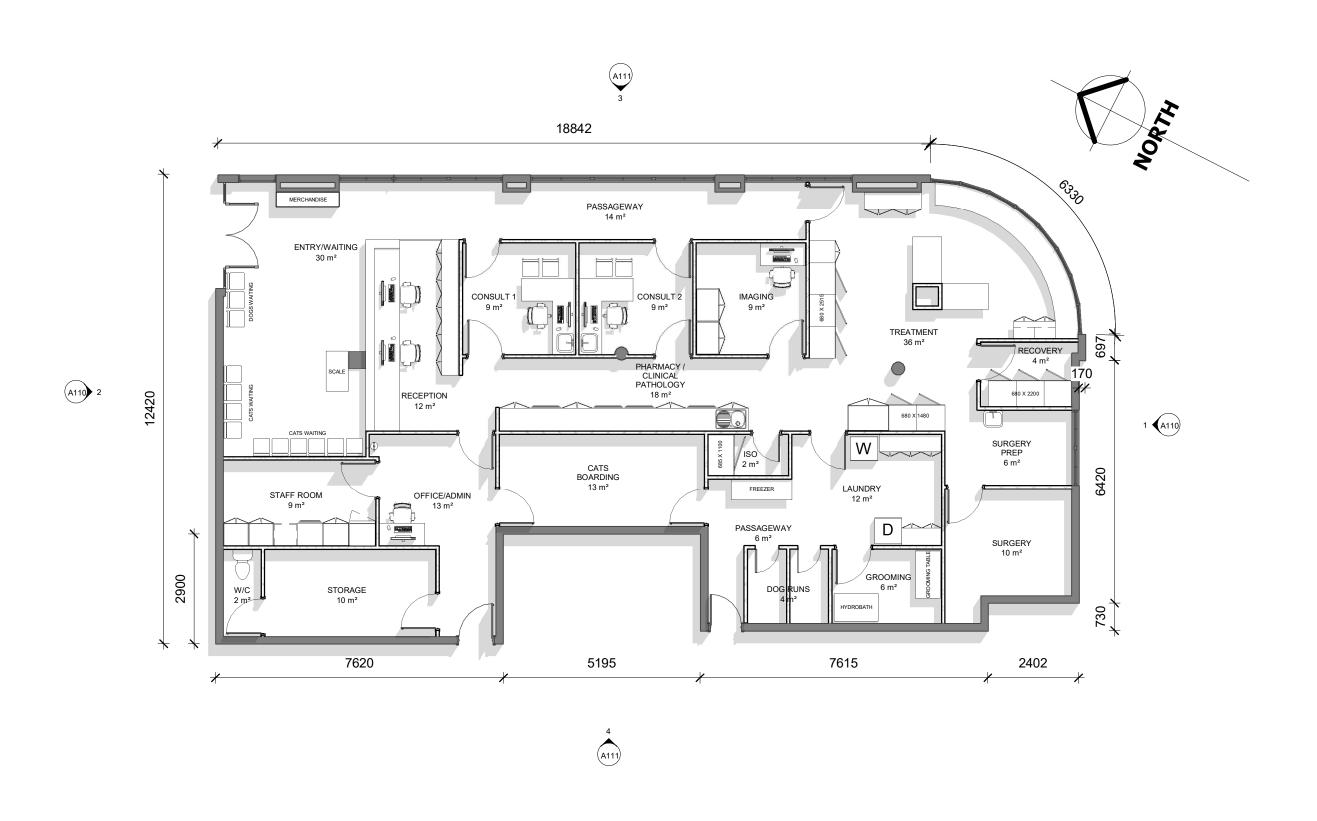



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ALL BOUNDARIES AND CONTOURS SUBJECT TO SURVEY.

PROJECT: **Proposed Fitout** 


**Merewether Veterinary Hospital** CLIENT: 25 LLEWELYN STREET, MEREWETHER ADDRESS:

DRAWING TITLE: Ground Floor Proposed Plan


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A106

REV: F

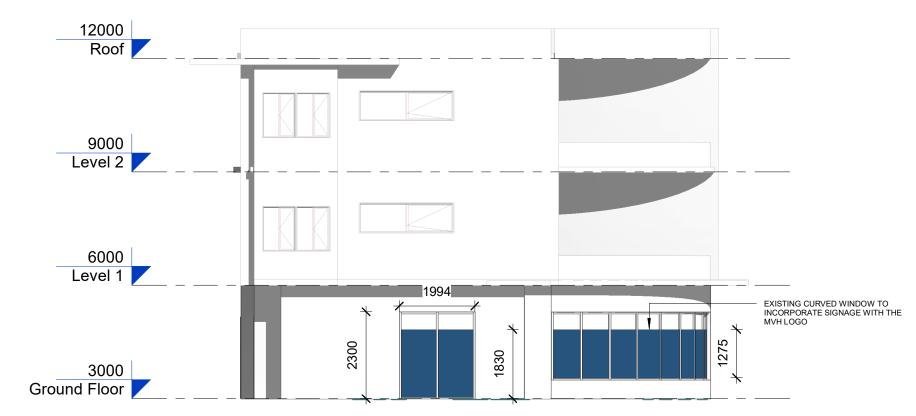

# South East Elelvation



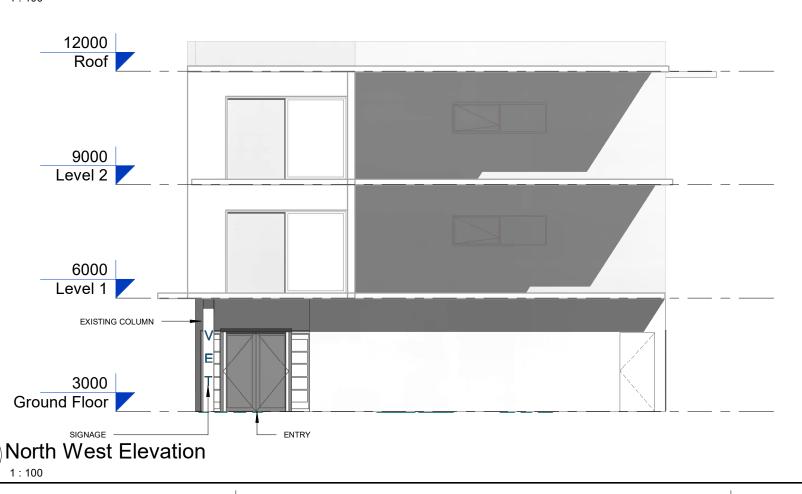

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ALL BOUNDARIES AND CONTOURS SUBJECT TO SURVEY.

**Proposed Fitout** PROJECT:

08/11/19

CLIENT: **Merewether Veterinary Hospital** 25 LLEWELYN STREET, MEREWETHER ADDRESS:

DRAWING TITLE: **Elevations** 

1:100 SCALE:

DATE:

DRAWN BY: STATUS:


JCC

FOR DA

DRAWING NO: A110

REV:

C

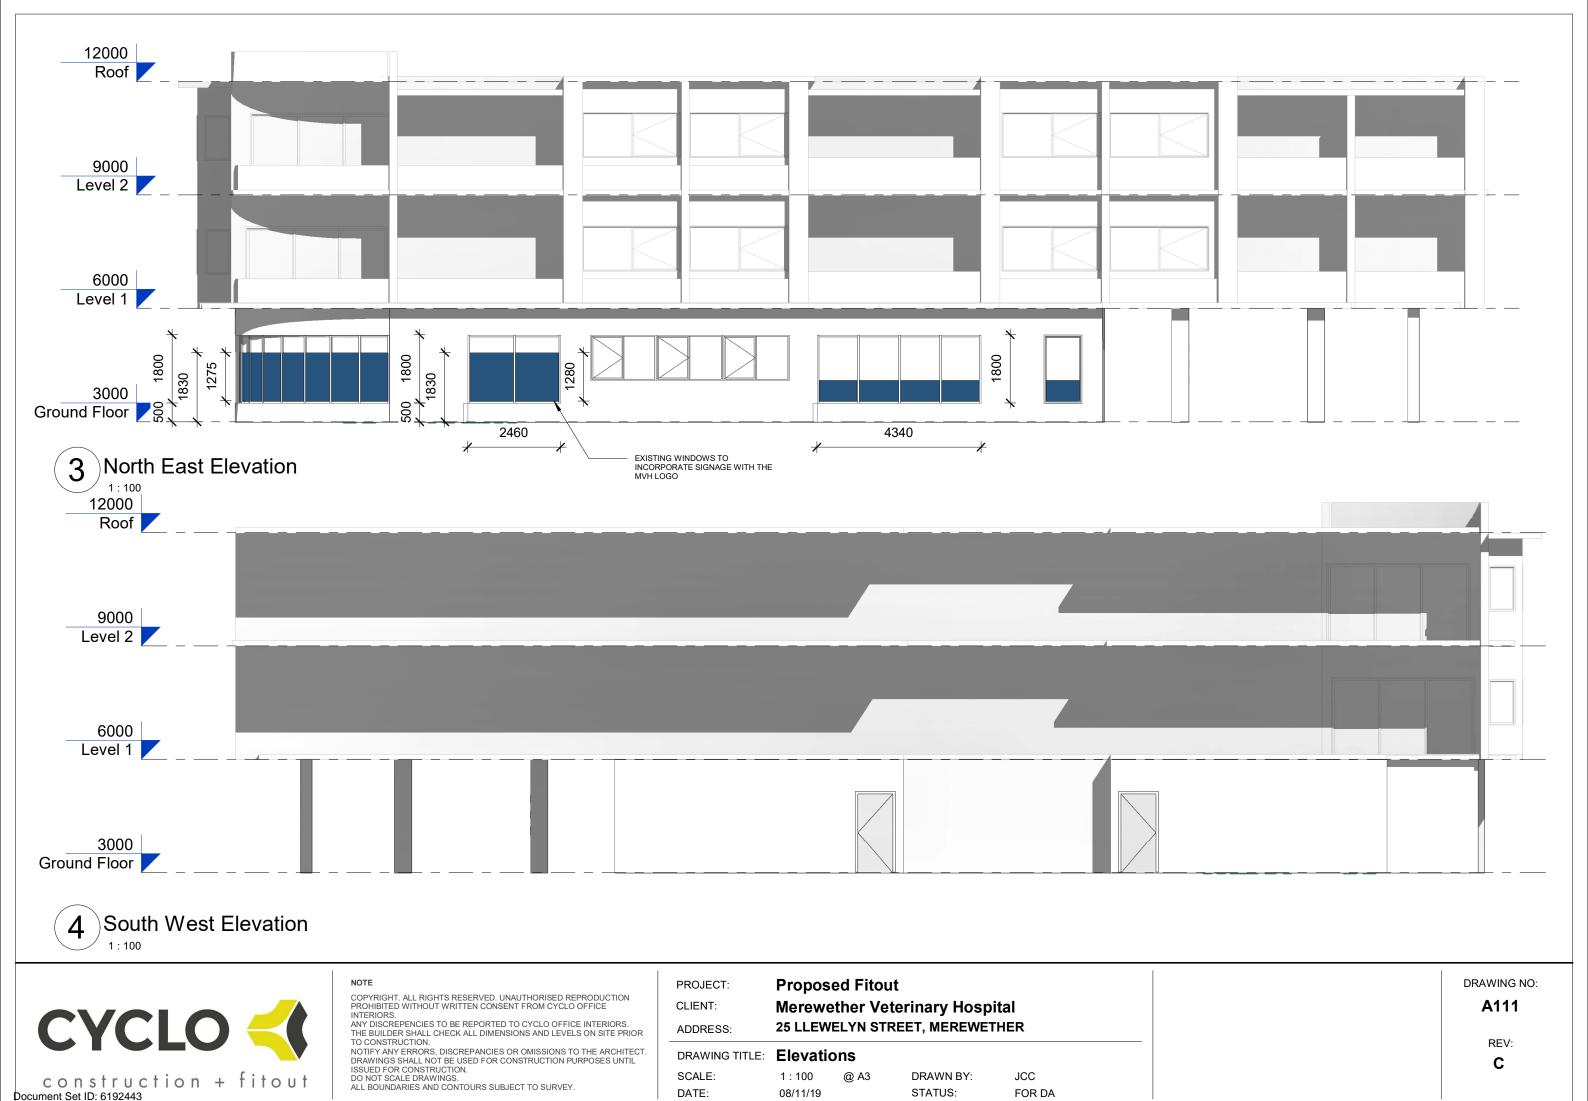

Version: 1, Version Date: 25/11/2019

### PUBLIC VOICE COMMITTEE MEETING

#### 17 MARCH 2020

#### PV 17/03/2020

#### DA2019/01255 - 25 LLEWELLYN STREET MEREWETHER

**Attachment B: Processing Chronology** 



### PROCESSING CHRONOLOGY

### DA2019/01255 – 25 Llewellyn Street Merewether

25 November 2019	-	Application lodged
2 December 2019	-	Public notification
3 December 2019	-	Applicant advised of technical issues raised after initial assessment of the application.
18 December 2019	-	Additional information received from the applicant
13 January 2020	-	Applicant provided a detailed response to public submissions
15 January 2020	-	Applicant advised of issues raised after assessment of the application and through public submissions
22 January 2020	-	Additional information received from applicant



### ATTACHMENTS DISTRIBUTED UNDER SEPARATE COVER

ITEM 3 DA2019/00603 - 26 SMITH STREET HAMILTON SOUTH

**Dwelling house - alterations and additions and ancillary structure** 

Attachment A - Submitted Plans

**Attachment B** - Processing Chronology

## PUBLIC VOICE COMMITTEE MEETING

#### 17 MARCH 2020

PV 17/03/2020

#### DA2019/00603 - 26 SMITH STREET HAMILTON SOUTH

**Attachment A: Submitted Plans** 

**DISTRIBUTED UNDER SEPARATE COVER** 







Local Government Area Newcastle City Council

Project name

Lot number Section number

Dwelling type

Type of alteration and

Plan type and number

BASIX	Certi	ficate

Building Sustainability Index www.basix.nsw.gov.au

## Alterations and Additions

Certificate number: A347322 02

This certificate confirms that the proposed development will meet the NSW government's requirements for sustainability, if it is built in accordance with the commitments set out below. Terms used in this certificate, or in the commitments, have the meaning given by the document entitled "BASIX Alterations and Additions Definitions" dated 06/10/2017 published by the Department. This document is available at www.basix.nsw.gov.au

This certificate is a revision of certificate number A347322 lodged with the consent authority or certifier on 31 May 2019 with application 2019/603.

It is the responsibility of the applicant to verify with the consent authority that the original, or any revised certificate, complies with the requirements of Sch 1 Cl 2A, 4A or 6A of the Environmental Planning and Assessment Regulation 2000

Secretary Date of issue: Friday, 13, December 2019
To be valid, this certificate must be lodged within 3 months of the date of issue.

	INWATER TANK L (MIN) ABOVE GROUND TANK
	TDOOR SWIMMING POOL L MAX, INSTALL POOL PUMP TIMBER, SOLAR HEATING
	T WATER Instantaneous
-AT	I <b>HTING</b> Least 40% of New Light or Altered Light Fittings are Fitt I Fluorescent, compact fluroescent or Led Globe.
FΙ>	TURES V OR ALTERERED SHOWERHEADS TO HAVE A FLOW RATE NO
-NE	ATER THAN 9L OR A 3 STAR RATING V OR ALTERERED TOILETS TO HAVE A FLOW RATE NO GREATER V 4L OR A 3 STAR RATING
-NE	VALOR A STAR RATING V OR ALTERERED TAPS TO HAVE A FLOW RATE NO GREATER TH <i>A</i> R A 3 STAR RATING
CC	NSTRUCTION INSULATION
- EX	OOR ABOVE EXISTING DWELLING (NIL INSULATION REQ.) FERNAL FRAMED PAINTED FC/FC SHEETING R1.3 MIN (R1.7 UDING CONSTRUCTION
-RA Ro.	ED CEILING, PITCHED SKILLION ROOF WITH R3.0 TO CEILING (MIN 4) AND FOIL/SARKING UNDER ROOF SHEETING (MEDIUM COLOUR)
0.47 (100	5-0.70 SOLAR ABSORBANCE; ROOF:- FOILED BACKED BLANKET

Certificate Prepared by (please complete before submitting to Council or PCA) Name / Company Name: Doring Design ABN (if applicable): 69 140 101 239

19003 - Wilkinson - 26 Smith St, Ham\_02

My renovation work is valued at \$50,000 or more,

Deposited Plan 37567

Separate dwelling house

and includes a pool (and/or spa).

Area Schedule			
Name	Area		
Existing Residence	166 m <sup>2</sup>		
Proposed Garage	39 m²		
Proposed Upper Floor	32 m²		
Grand total	237 m²		

SITE AREA - 530m2 FLOOR SPACE RATIO - 166+32/530 = 0.37

STANDARD TIMBER FRAMED WITH SINGLE CLEAR GLAZING (U-VALUE 7.57, SHGC 0.57) -WINDOW (1) AND (9) WITH EXTERNAL ADJUSTABLE BLIND/LOUVRE

desciption date issue

Application client\M Wilkinson

address\ 26 Smith St, Hamilton South

@A1 indicated

issue date\18.02.20


sheet\

A101 project no\ 19003

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issue\ G p/ po box 3387 merewether nsw 229 m/ 0404 755250

doring design commercial



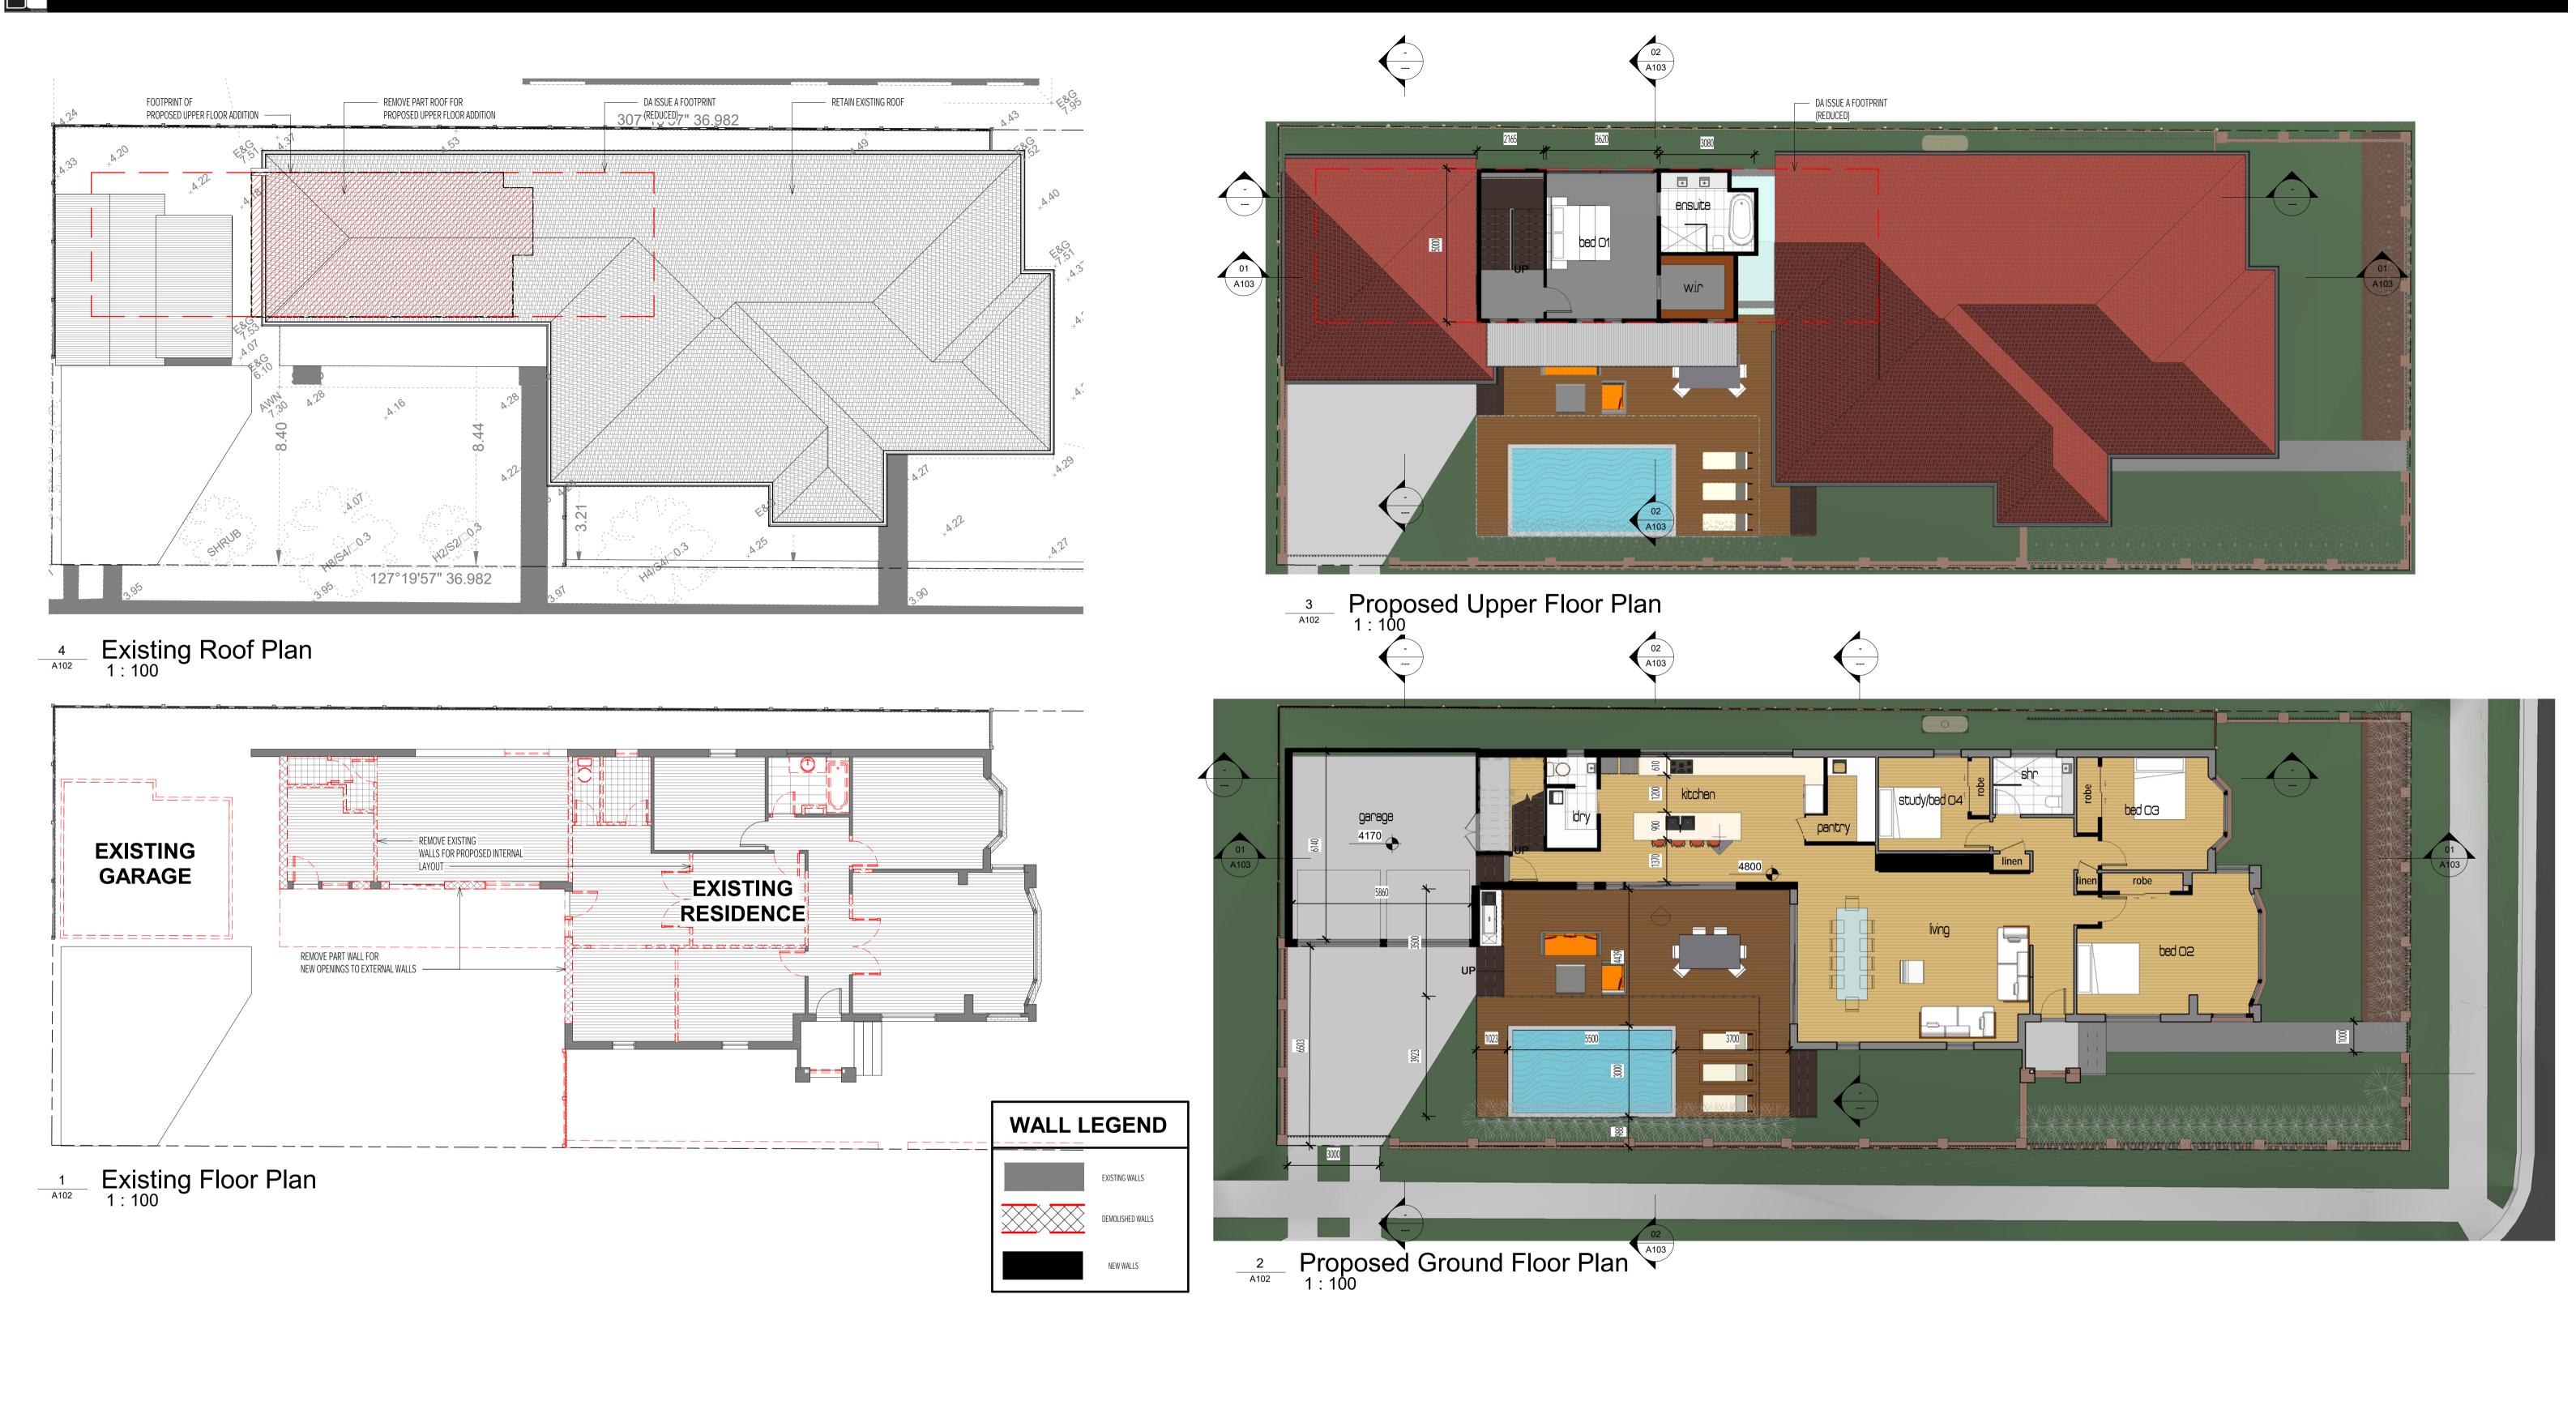

consultants\ date desciption issue

status\Development Application client\M Wilkinson

description\ Proposed Alterations + Additions to residence

26 Smith St, Hamilton South

address\


scale\ As @A1 indicated issue date\18.02.20


sheet\

**project no\** 19003

A102 issue\ G p/ po box 3387 merewether nsw 2291 m/ 0404 755250 ©соруяюнт 2020



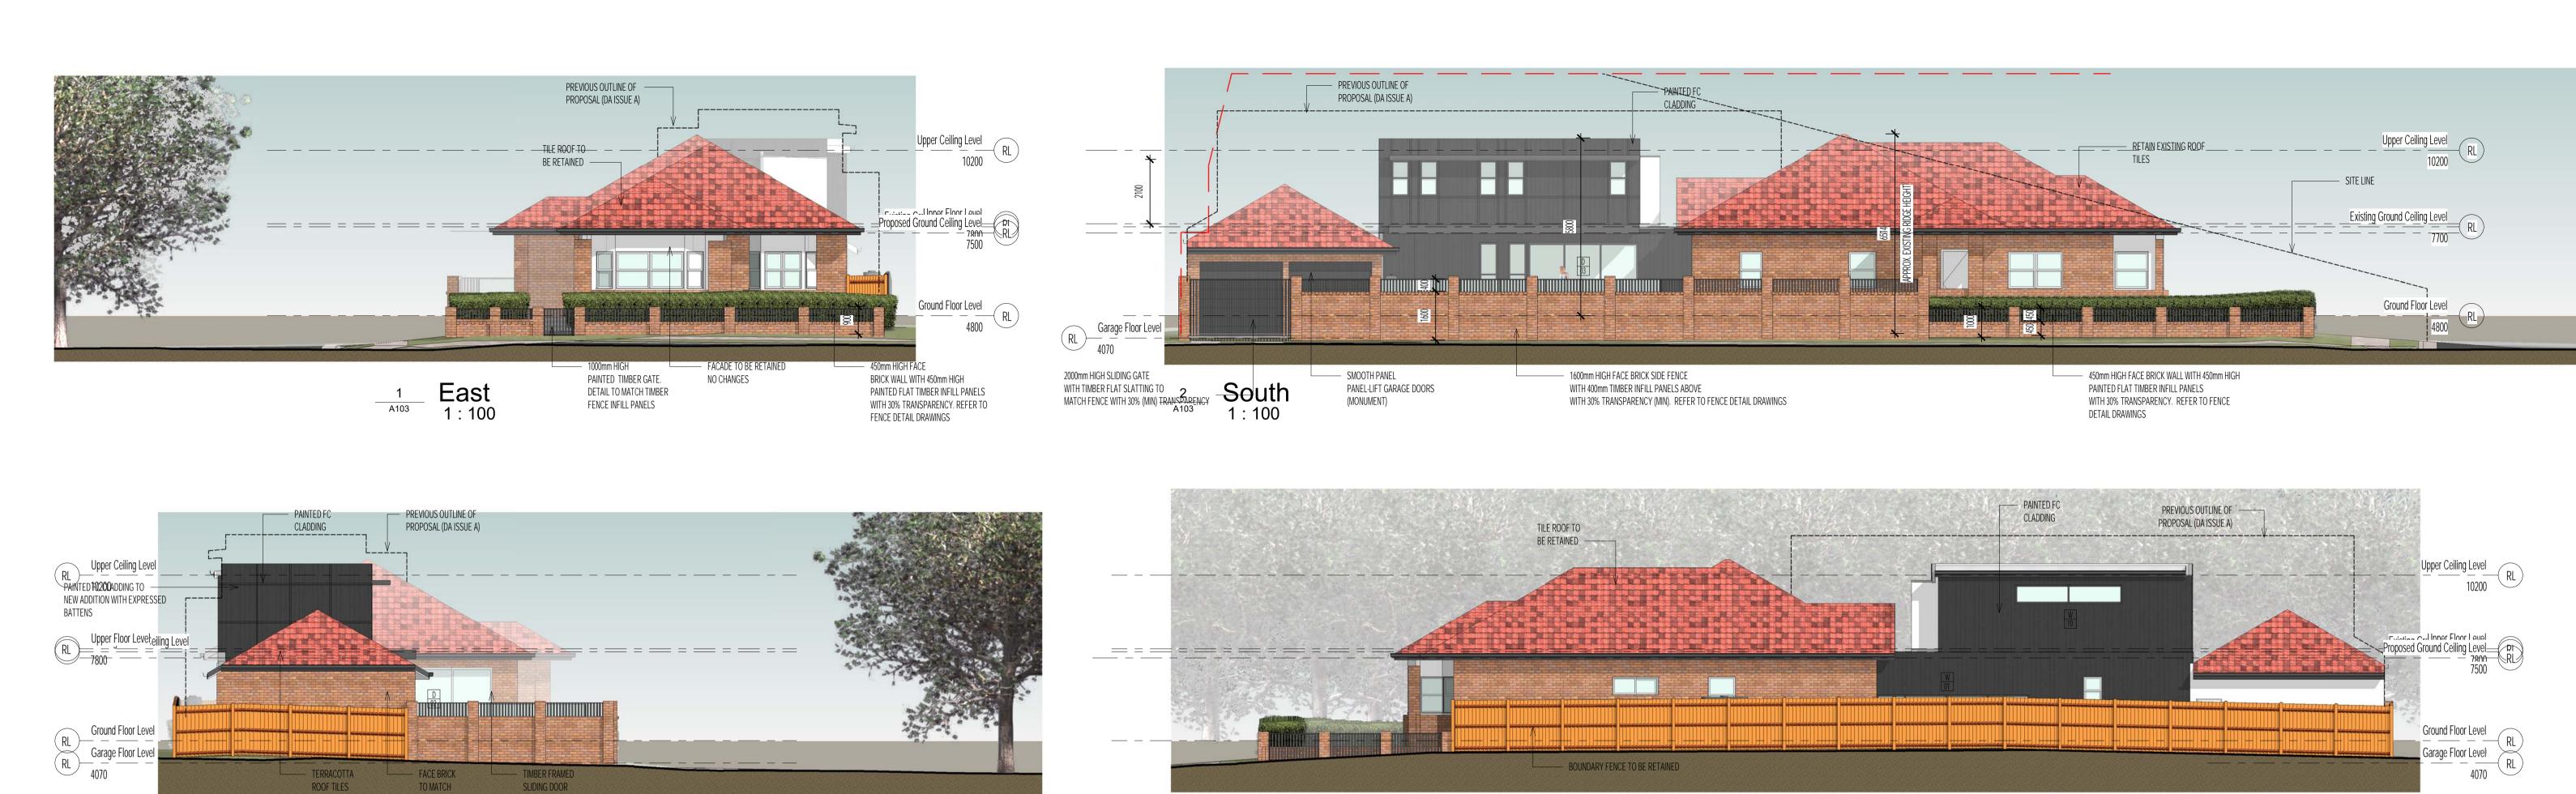

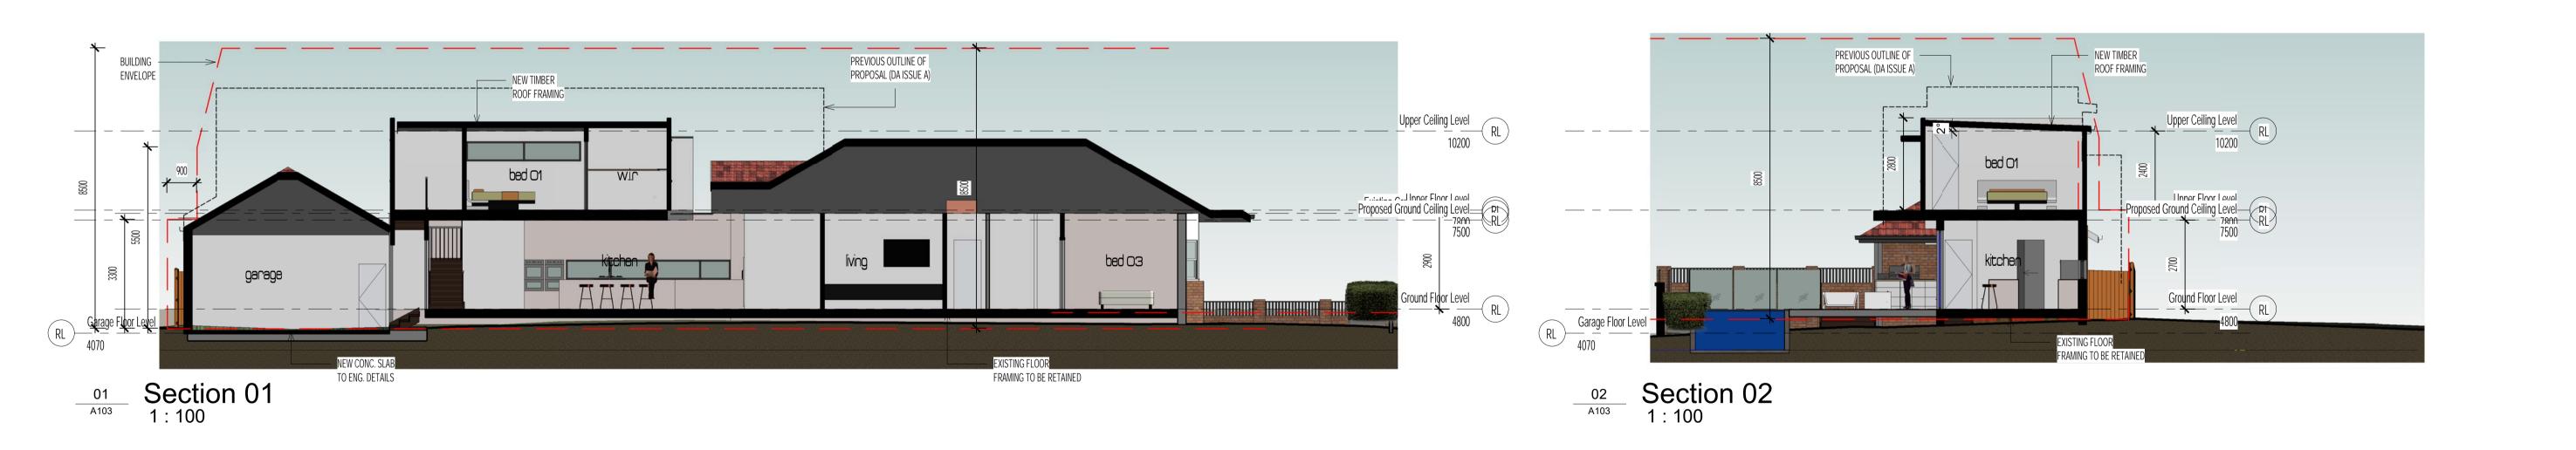



**EXISTING** 

status\Development Application client\M Wilkinson

description\ Proposed Alterations + Additions to residence

26 Smith St, Hamilton South

address\

scale\


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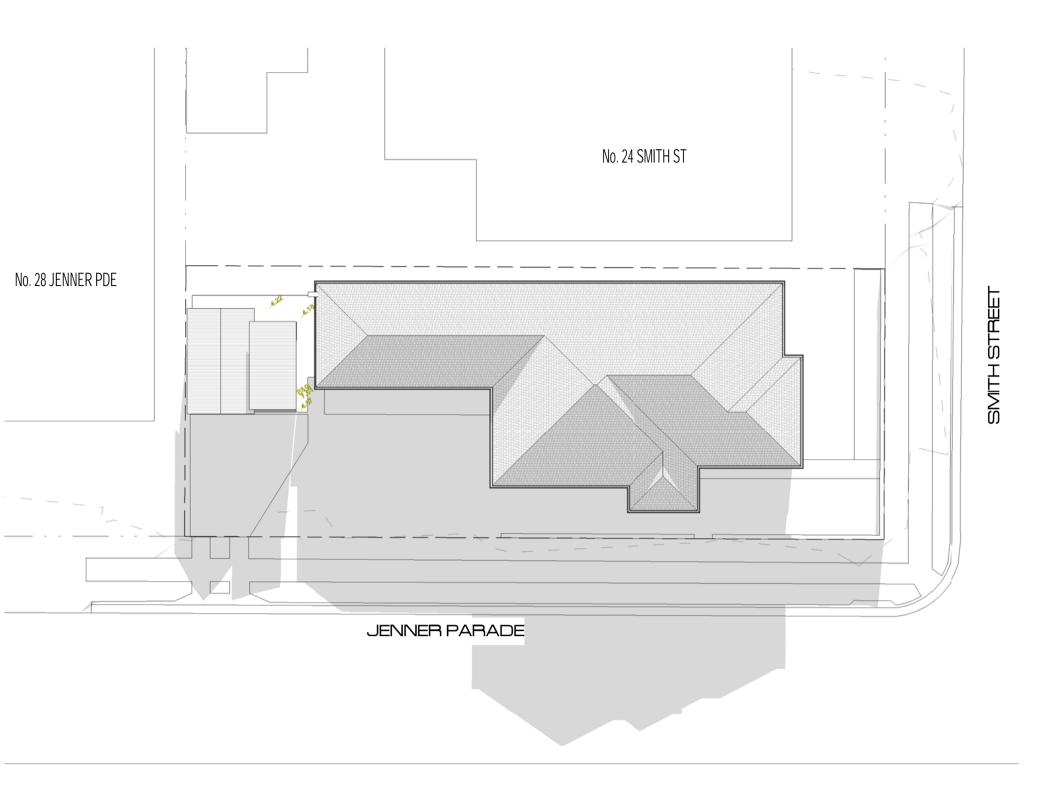
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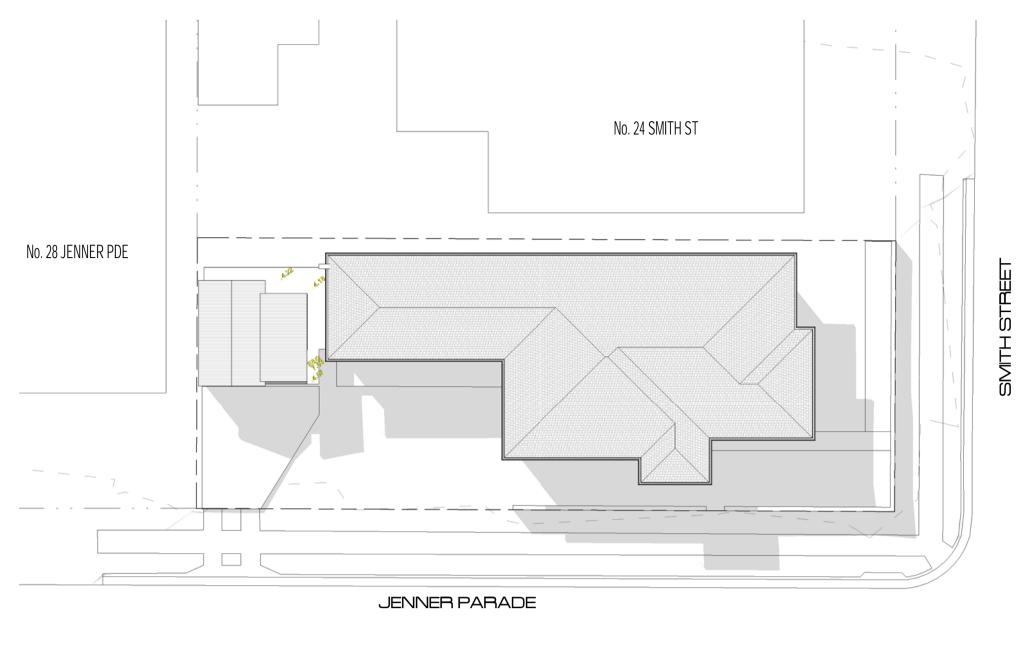
sheet\


A103 **issue\ G** p/ po box 3387 merewether nsw 2291 m/ 0404 755250 ©соруяюнт 2020 project no\ 19003







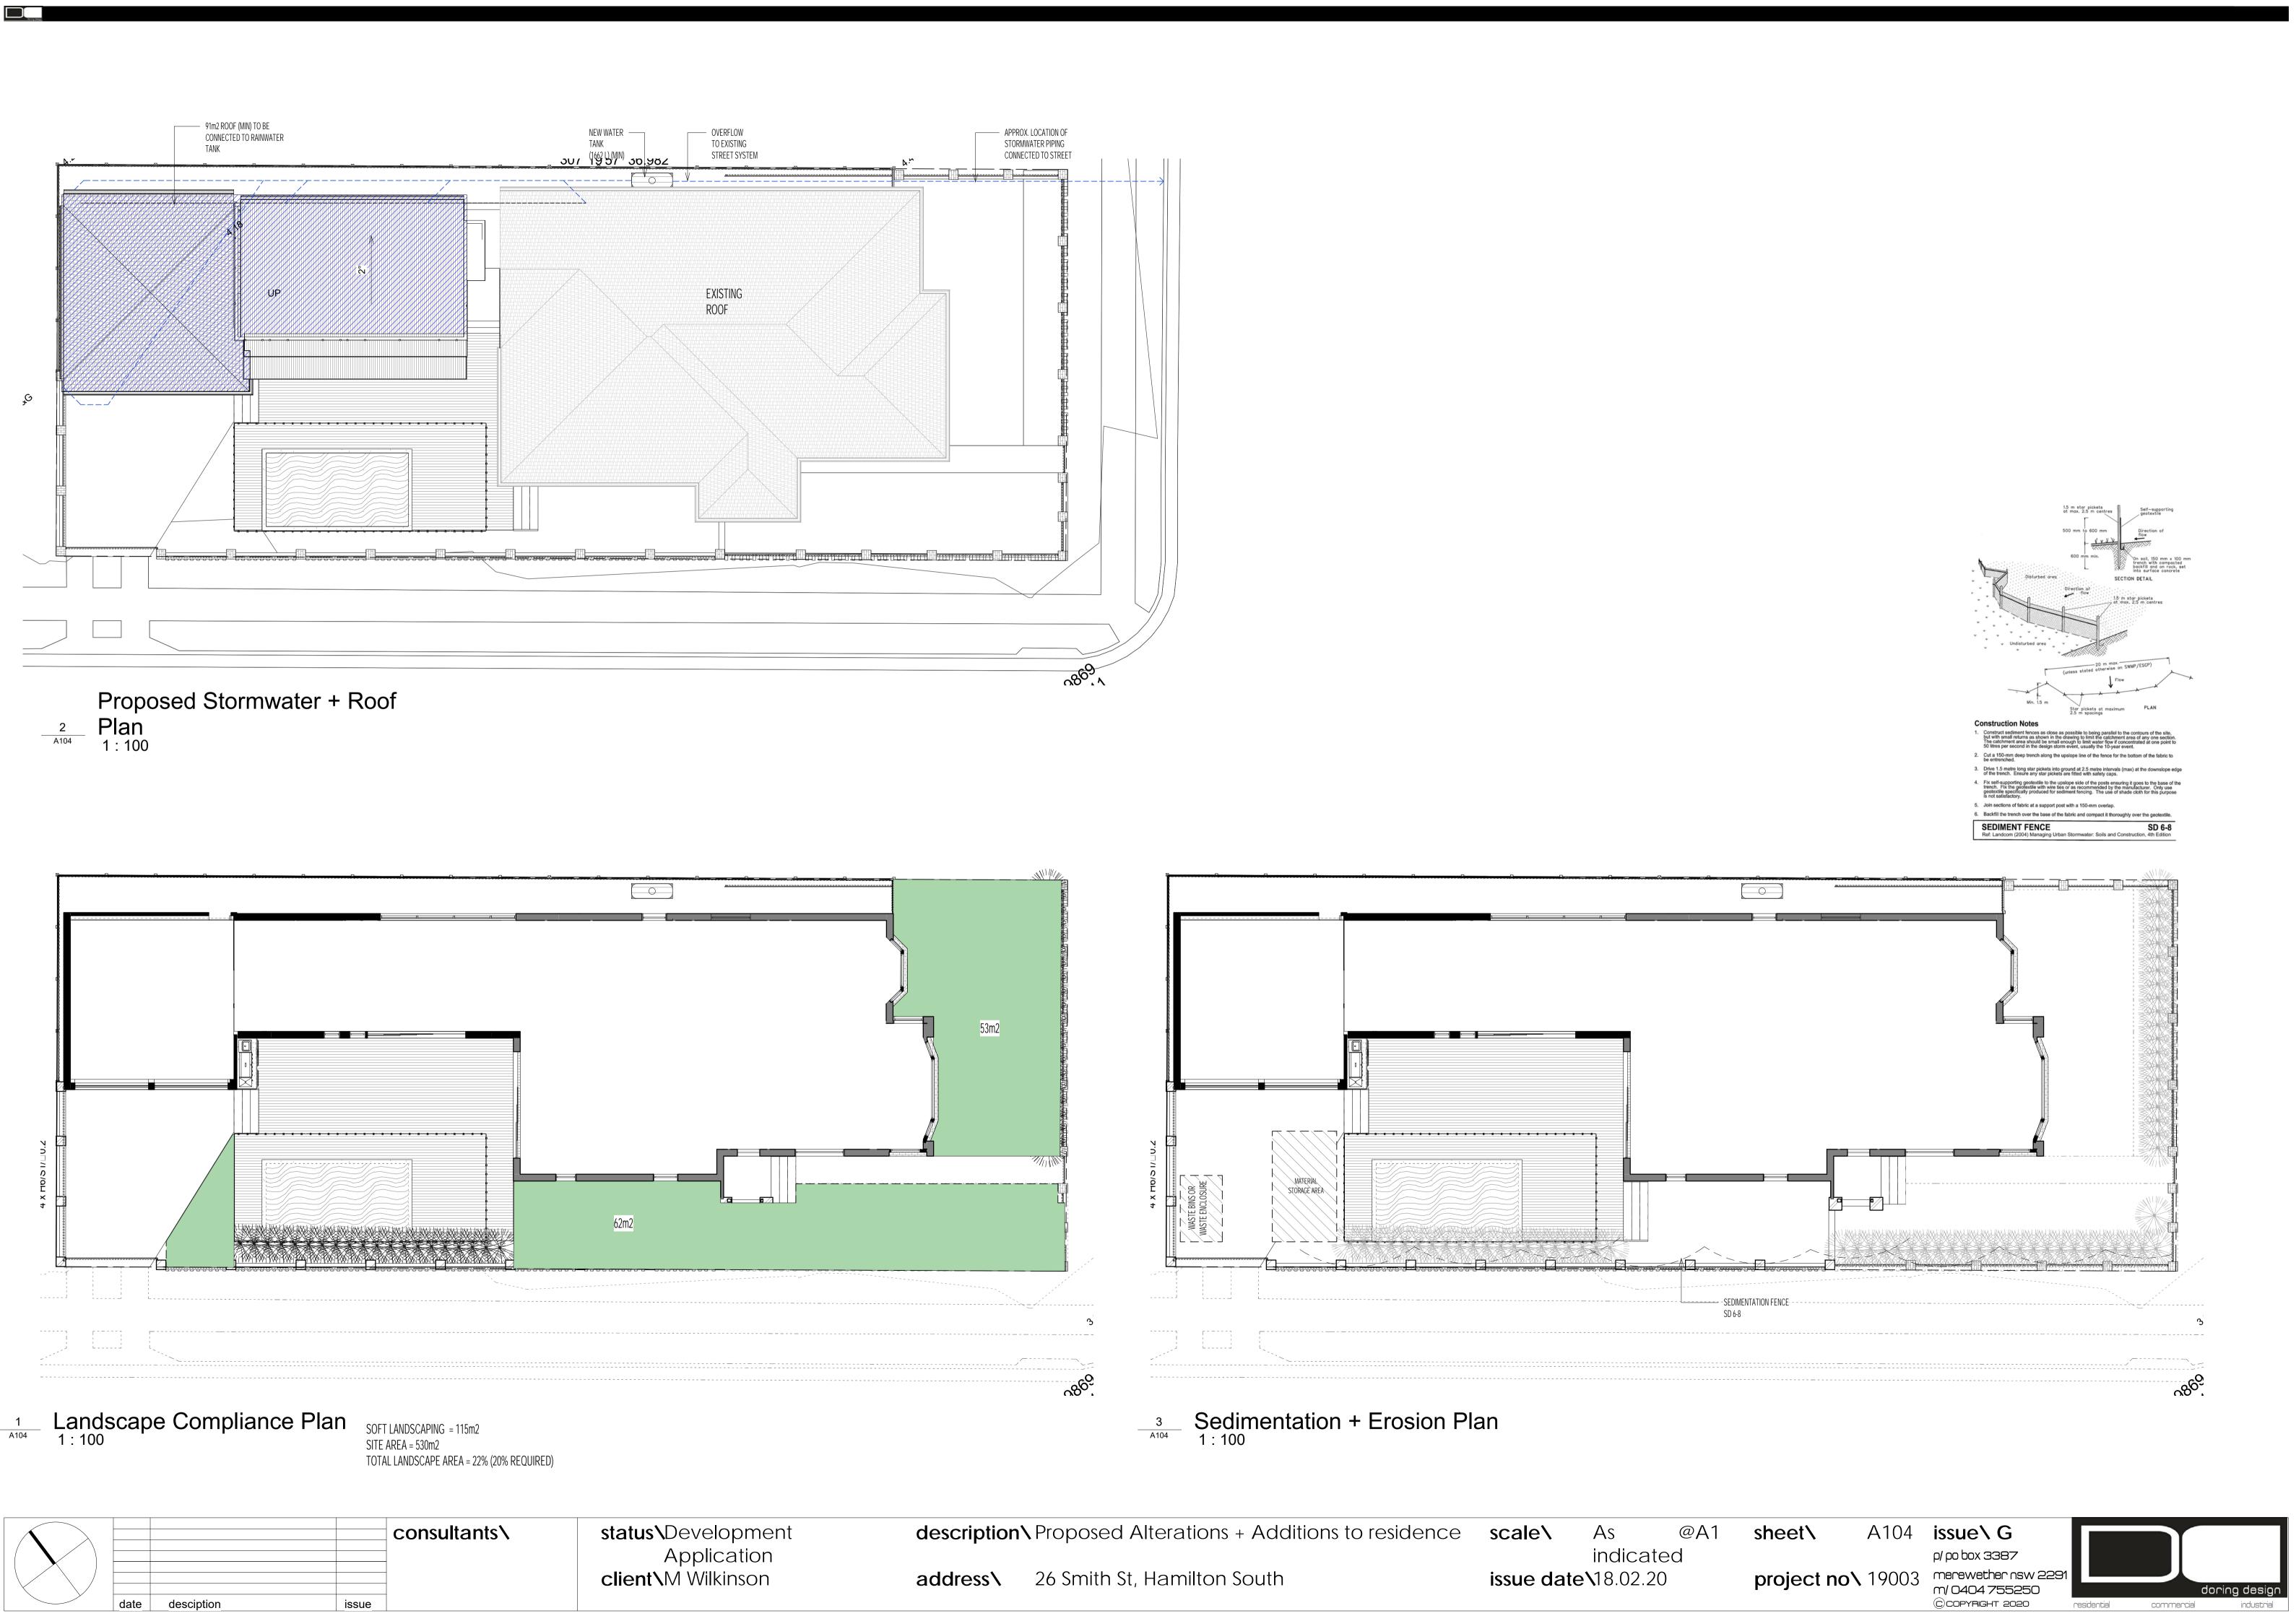

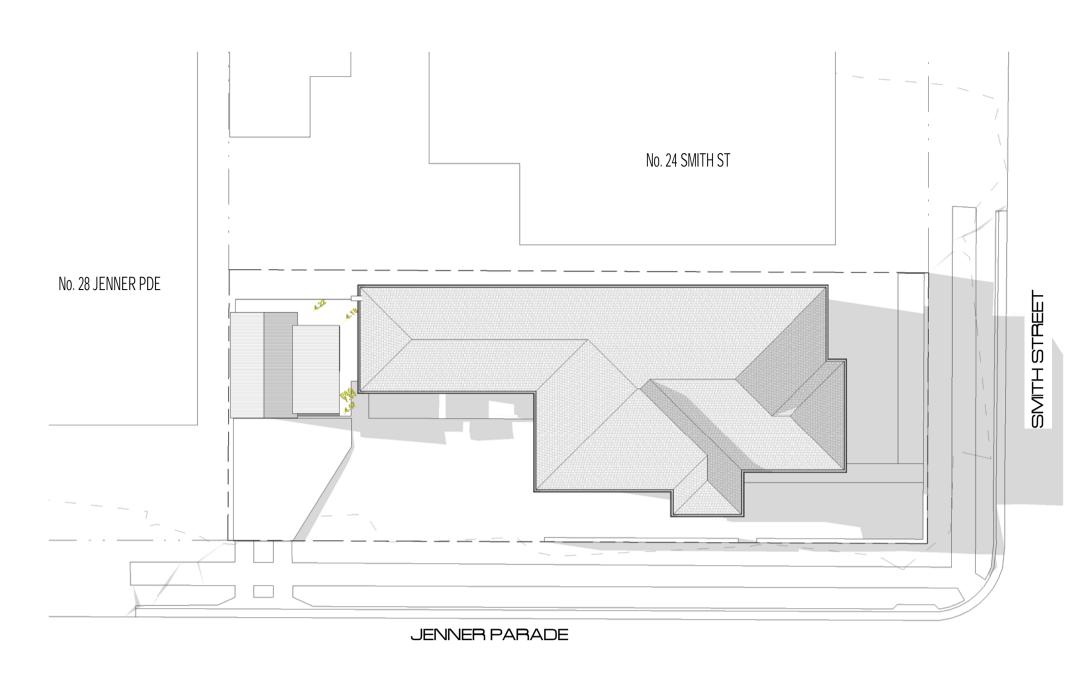



Existing Shadows - 9am - June


21st
1:200

Existing Shadows - 12pm- June 21st 1:200

Existing Shadows - 3pm- June 21st 1:200

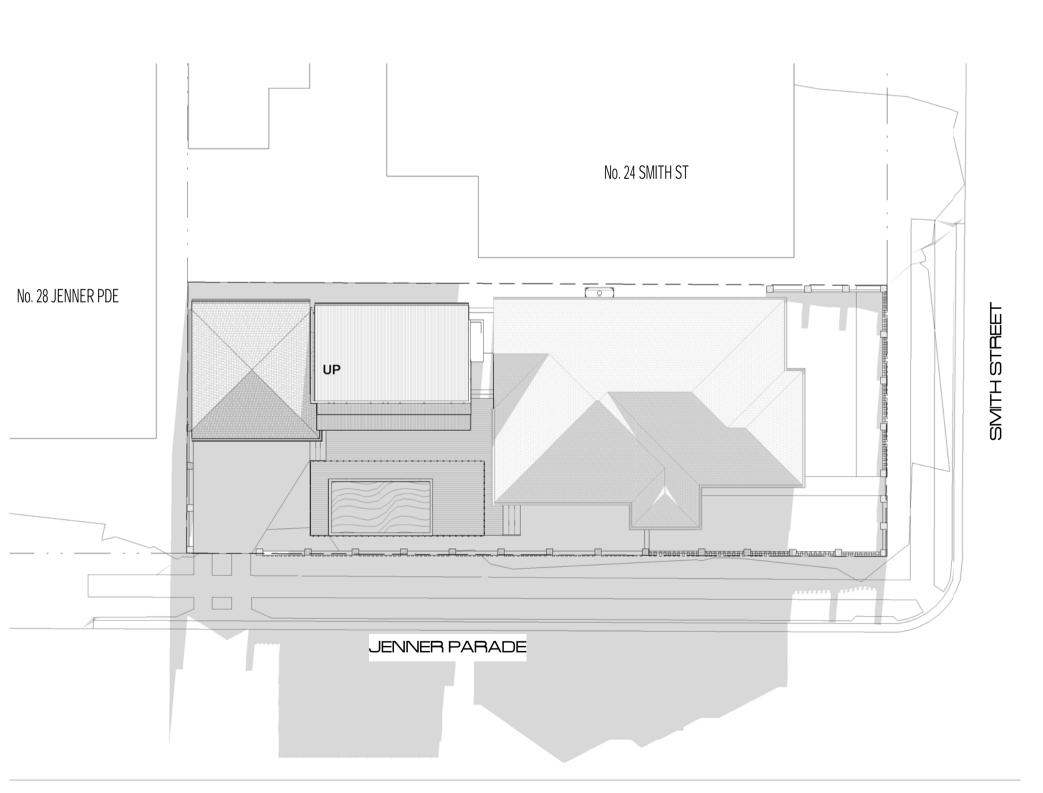

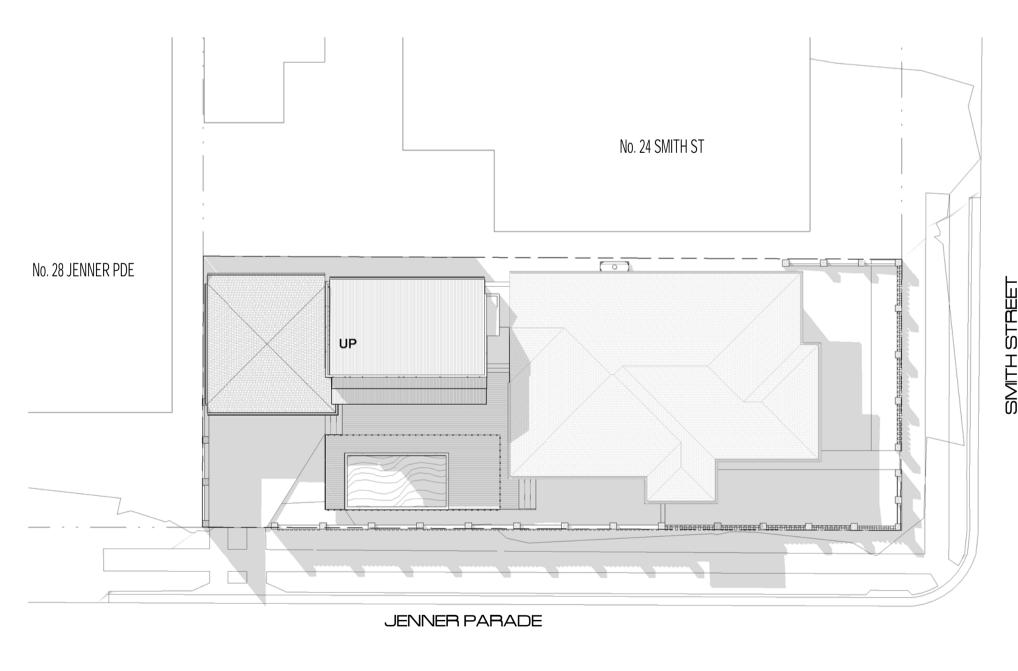

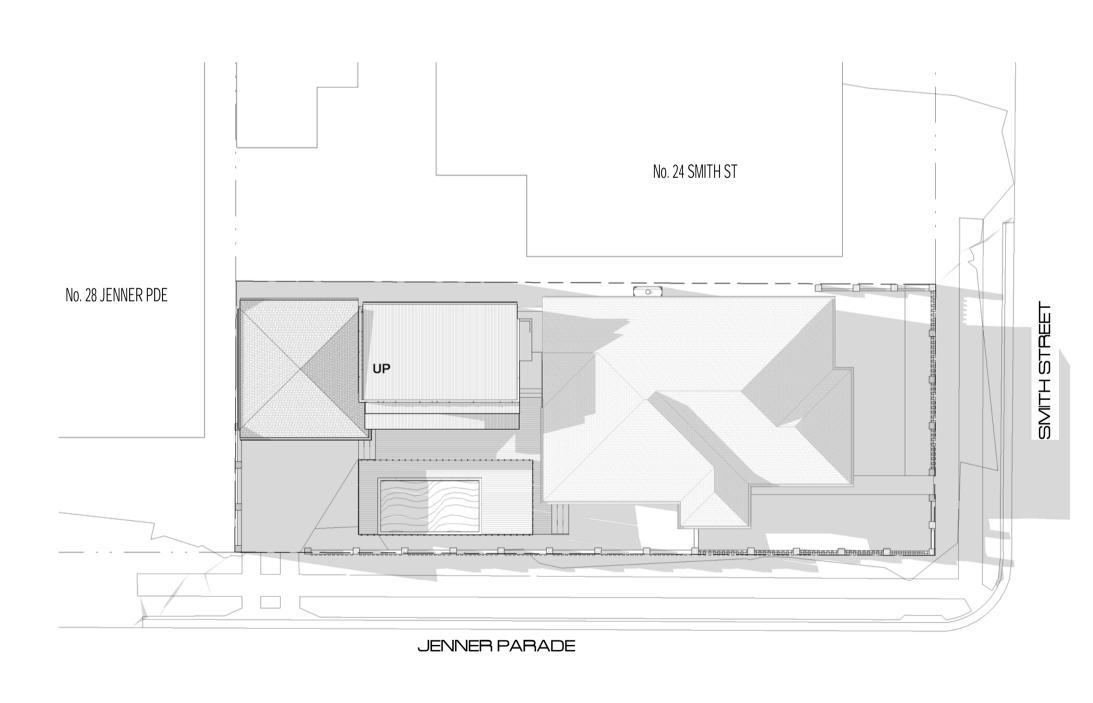

Proposed Shadows - 9am -June 21st

Proposed Shadows - 12pm-June 21st

address\

Proposed Shadows - 3pm- June

21st 1:200

consultants\ date desciption issue

status\Development Application client\M Wilkinson

description\ Proposed Alterations + Additions to residence

26 Smith St, Hamilton South

As @A1 scale\ indicated issue date\18.02.20

sheet\

A105 **issue\ G** p/ po box 3387 project no\ 19003 merewether nsw 2291 m/ 0404 755250 © COPYRIGHT 2020

doring design
industrial commercial

## PUBLIC VOICE COMMITTEE MEETING

#### 17 MARCH 2020

PV 17/03/2020

#### DA2019/00603 - 26 SMITH STREET HAMILTON SOUTH

**Attachment B: Processing Chronology** 



### PROCESSING CHRONOLOGY

#### DA2019/00603 - 26 Smith Street Hamilton South

31 May 2019	-	Application lodged
6 June 2019 to 25 June 2019	-	Application publicly notified. Twenty-two submissions were received in response to the notification period
20 June 2019	-	Preliminary request for additional information
17 July 2019	-	Additional information received from applicant
29 July 2019	-	Additional information received from applicant
7 August 2019	-	Request from Councillor Elliott and Councillor Duncan received (PB2019/08468)
26 August 2019	-	Response sent to applicant
22 October 2019	-	Meeting with designer, planner and CN staff to discuss design issues to resolve
29 October 2019	-	Request for additional information
17 December 2019	-	Additional information received from applicant
2 January 2020 to 28 January 2020	-	Application publicly notified. Forty submissions of objection were received, and five submissions of support received in response to the notification period.
11 February 2020	-	Request from Lord Mayor Nelmes received (PB2020/01569)
19 February 2020	-	Additional information received from applicant
17 March 2020	-	Application scheduled to proceed to Public Voice meeting